



ARCHITECTURE - INTERIOR DESIGN - CIVIL ENGINEERING -LANDSCAPE ARCHITECTURE


Bermello Ajamil & Partners, Inc. Architecture Engineering Planning Interior Design Landscape Architecture 2601 South Bayshore Drive, 10th Floor Miami, Florida 33133 T: (305) 859-2050 F: (305) 860-3700

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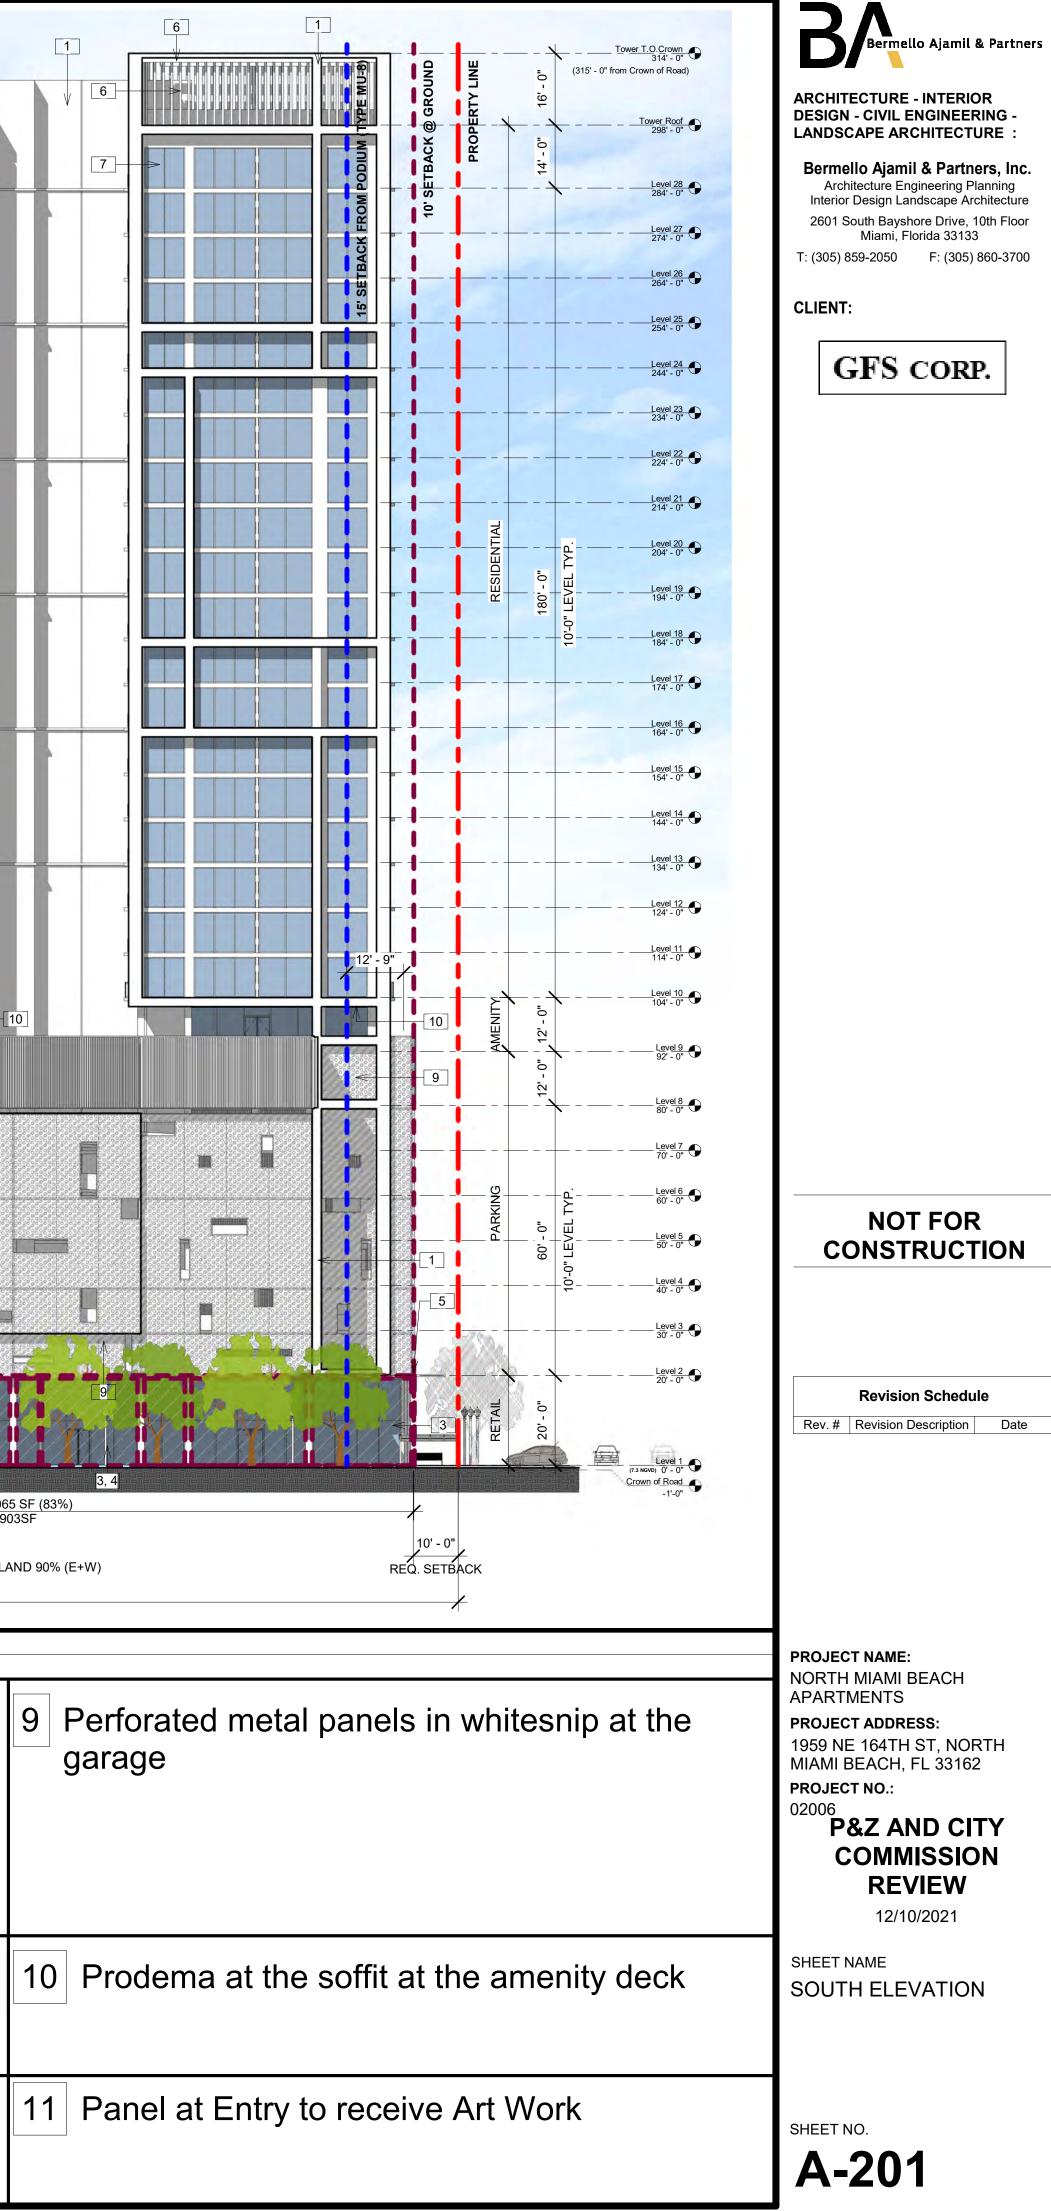
	Revision Schedu	le
Rev. #	Revision Description	Date
PROJEC	T NAME:	
	MIAMI BEACH	
	E ADDRESS: E 164TH ST, NOF	ктн
	3EACH, FL 33162	
PROJEC	T NO.:	
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•	REVIEW	
	12/10/2021	
	12,10,2021	
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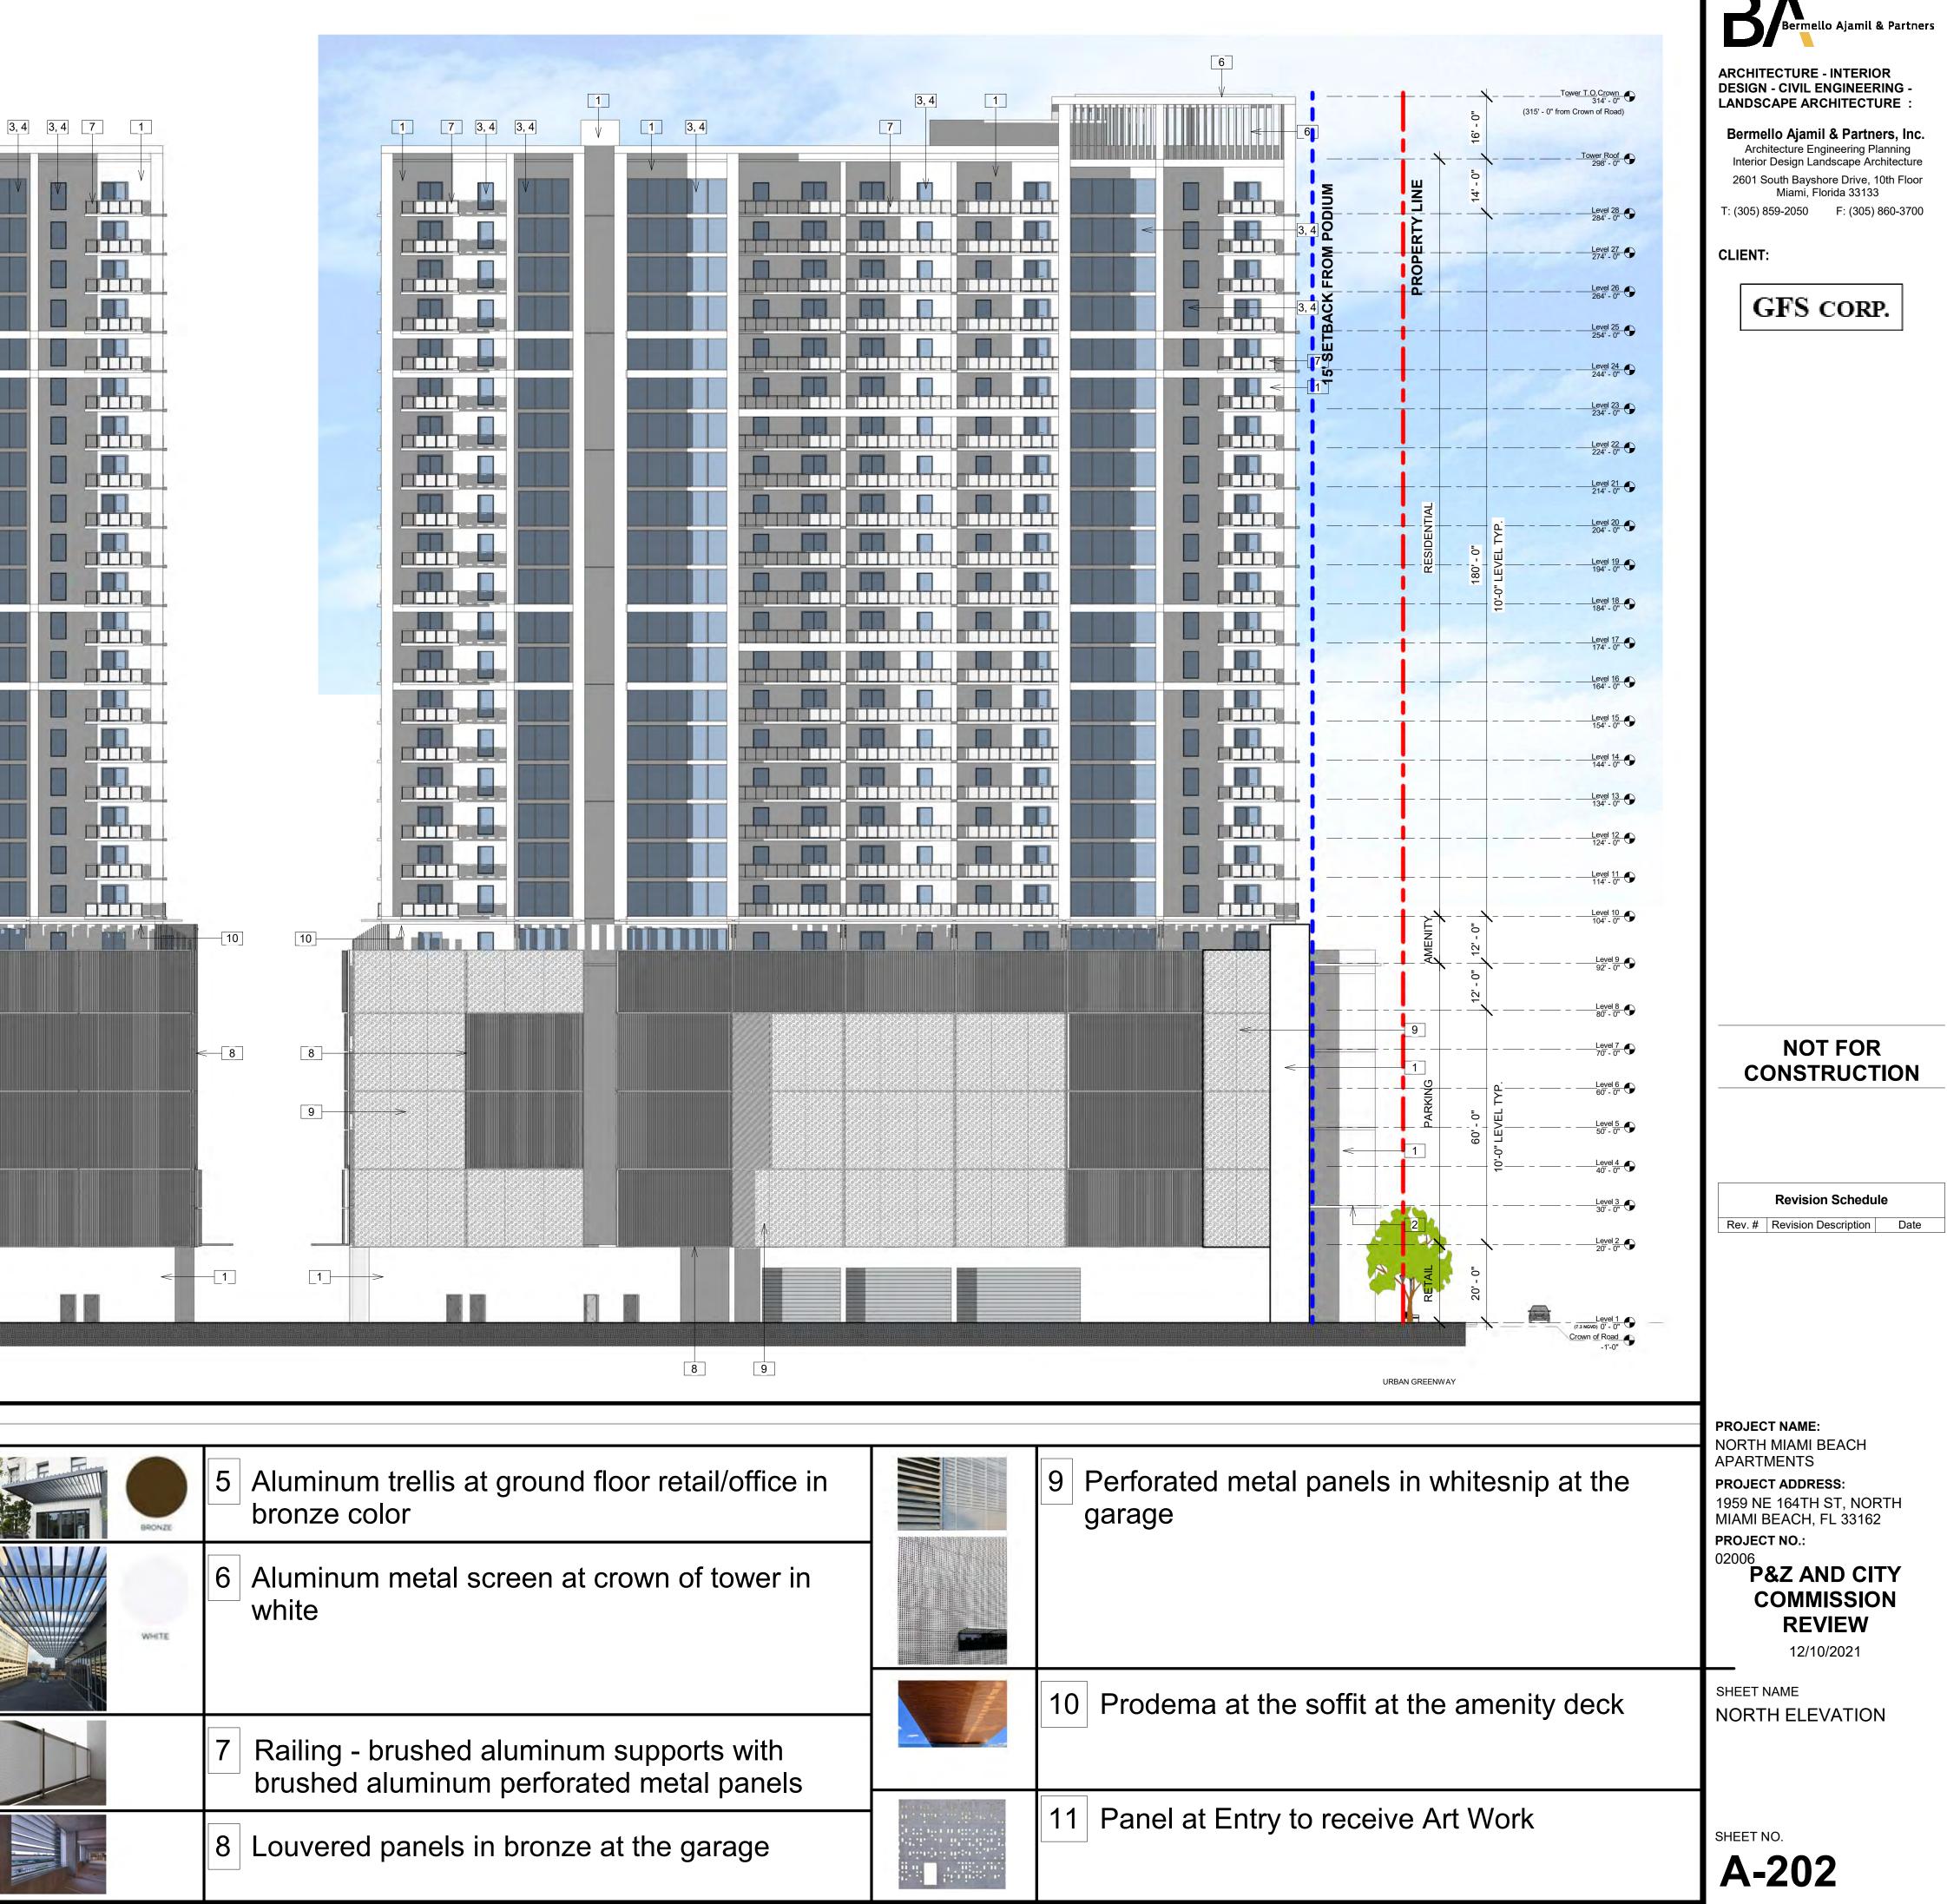
<u>[3, 4]</u> [3, 4] [7] [1]		<u>1</u> <u>7</u> <u>3, 4</u>	[3, 4]	[1] [7]	3,4	3,4 1
				5		
PROPERTY FRONTAGE	40' - 0" 40' - 0" MOTOR COURT 561' - 2" ON 164TH STREET (PRIMARY) "SII	DE"			FRONT GROUND FLO ROUND FLOOR HABI	

	5 Aluminum trellis at ground floor retail/office in bronze color	
BRONZE WHITE	6 Aluminum metal screen at crown of tower in white	
	7 Railing - brushed aluminum supports with brushed aluminum perforated metal panels	
	8 Louvered panels in bronze at the garage	

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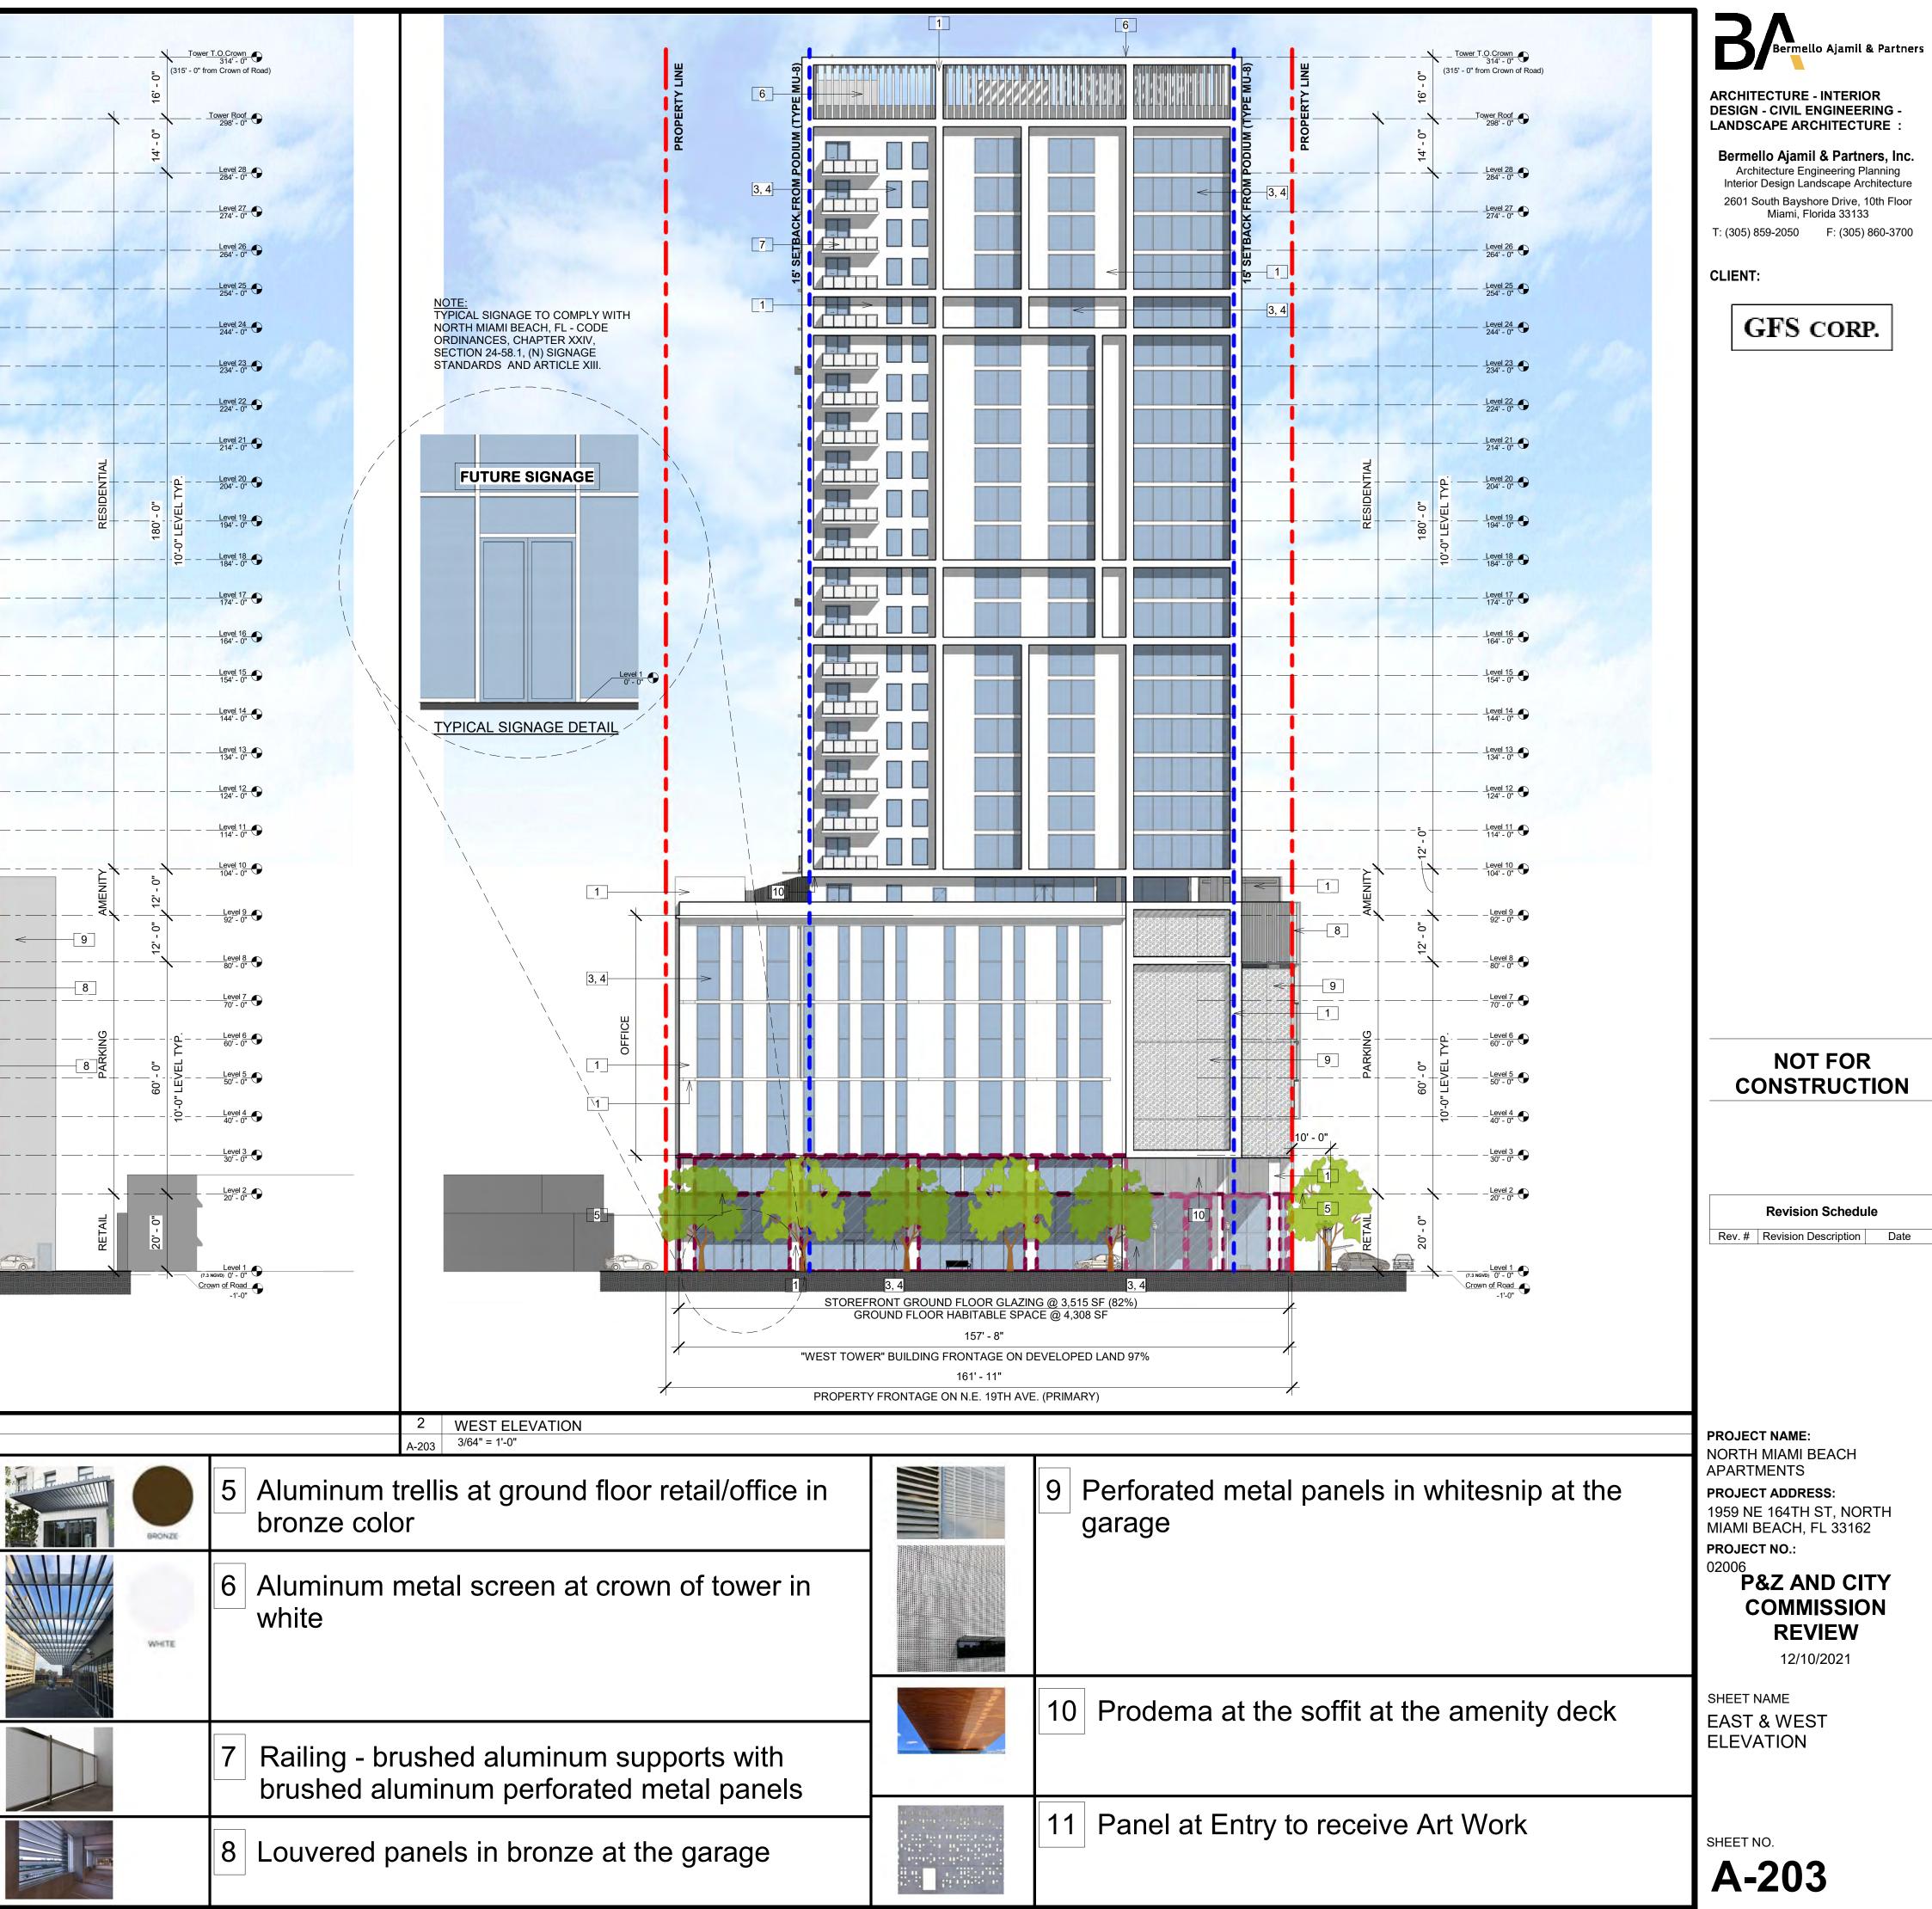



A-202 1 Simply White BM - OC-117 for body of and grid.LRV: 91.7 Image: Simply white OC-117 2 Mustang for accent color on building - 2		BRONZE	 5 Aluminum trellis at ground floor retail/office in bronze color 6 Aluminum metal screen at crown of tower in 	
LRV: 8.95 3 Window glass clear with light tint. (glas mirror type and shall permit view of act inside)	ss is not tivities	WHITE	white 7 Railing - brushed aluminum supports with	
Image: state of the state	e storefront)		 8 Louvered panels in bronze at the garage 	DESIGN PROPERTY OF

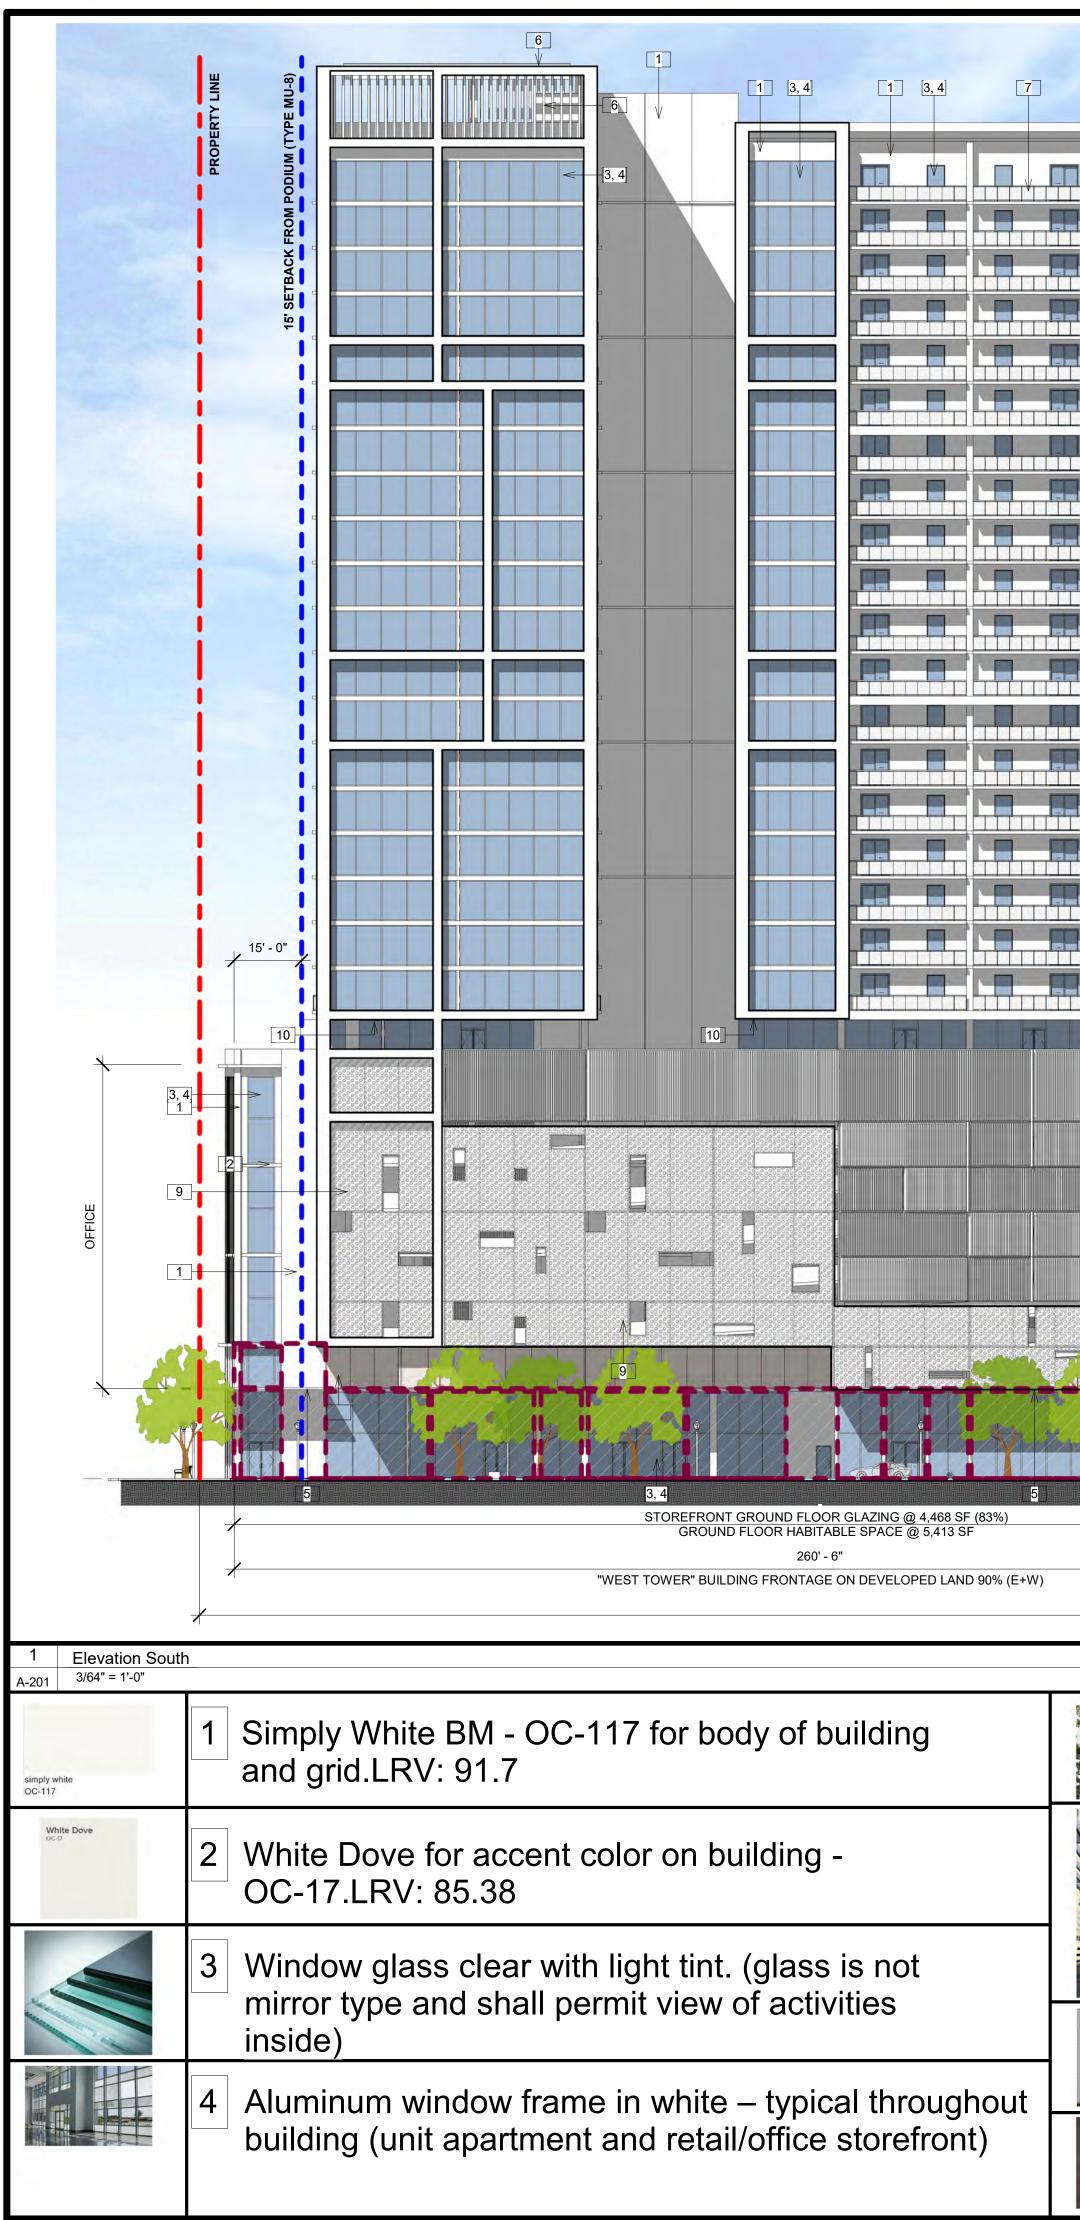

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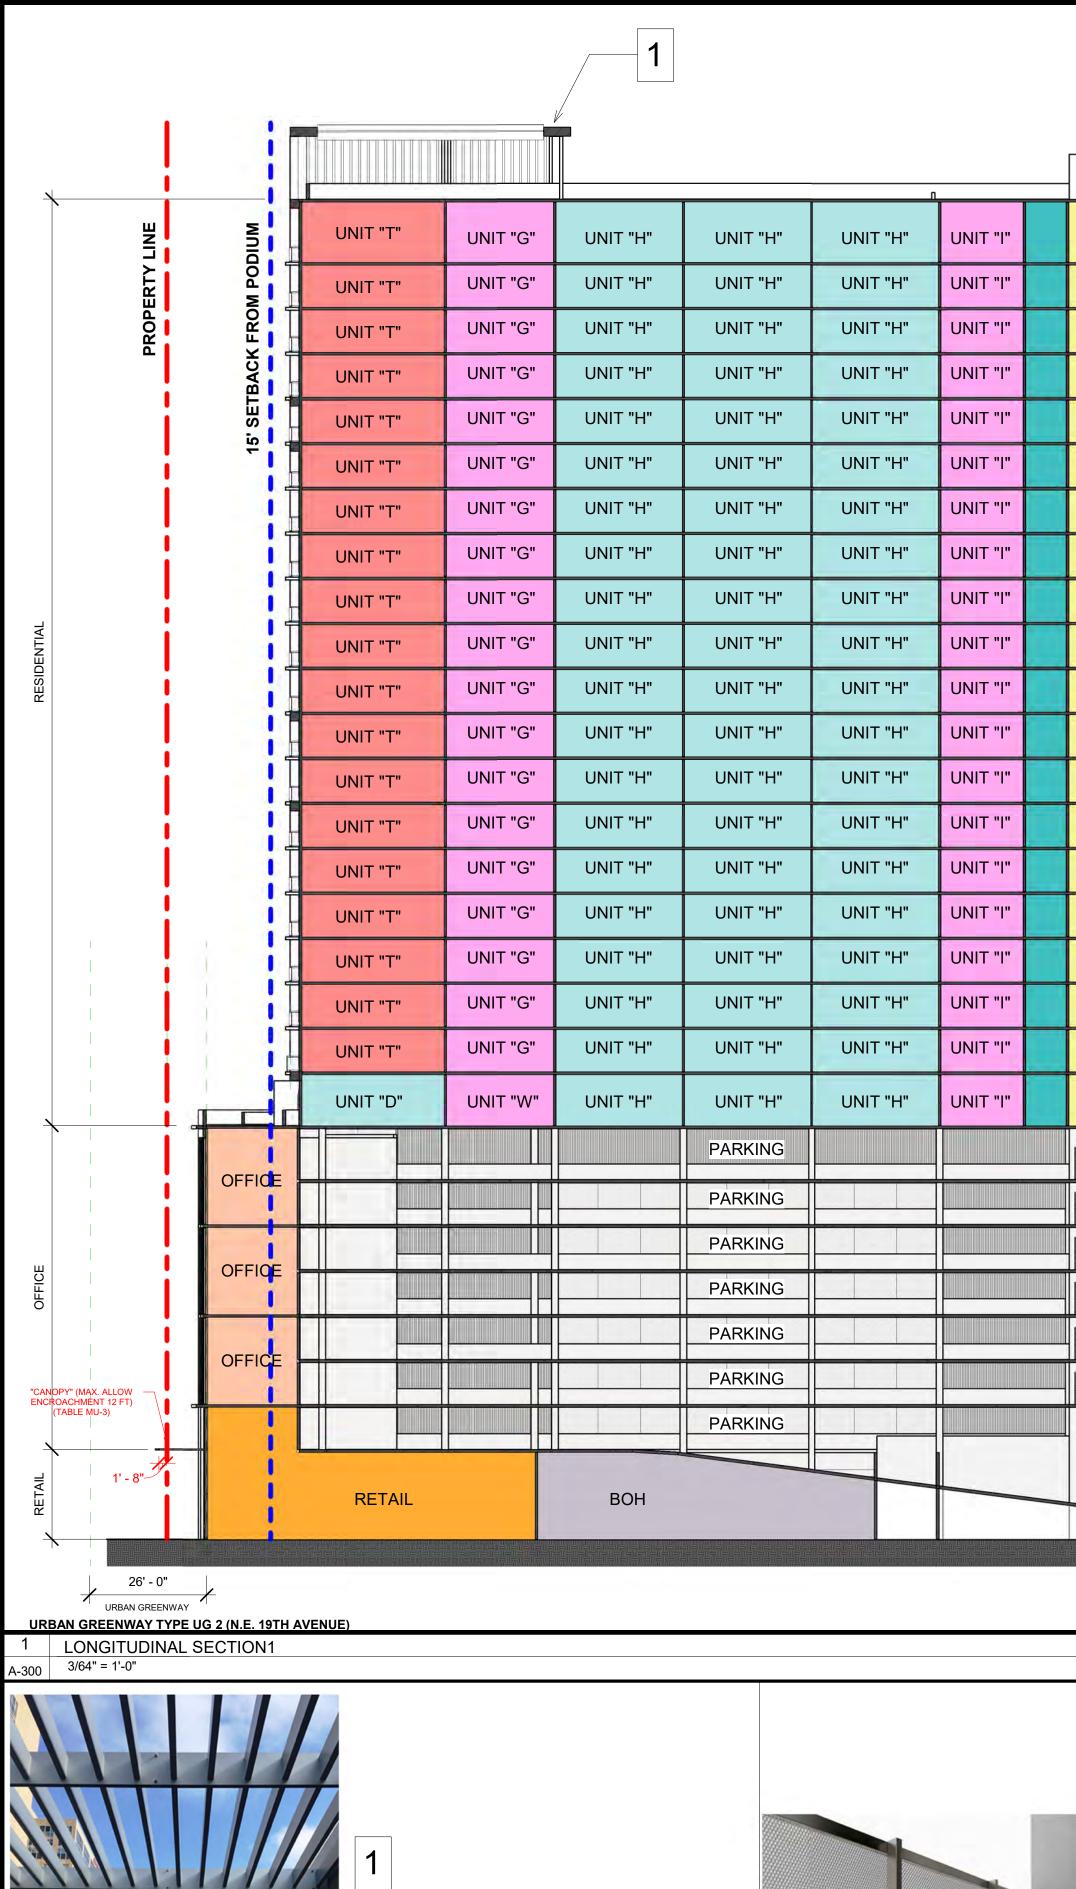
	6
	Image: Constraint of the second se
1 EAST ELEVATION A-203 3/64" = 1'-0"	
A-203 3/64 = 1-0 simply white OC-117 Mustang 211530 211	Simply White BM - OC-117 for body of building and grid.LRV: 91.7 Mustang for accent color on building - 2111-30.
3	Window glass clear with light tint. (glass is not mirror type and shall permit view of activities inside)
4	Aluminum window frame in white – typical throughout building (unit apartment and retail/office storefront)



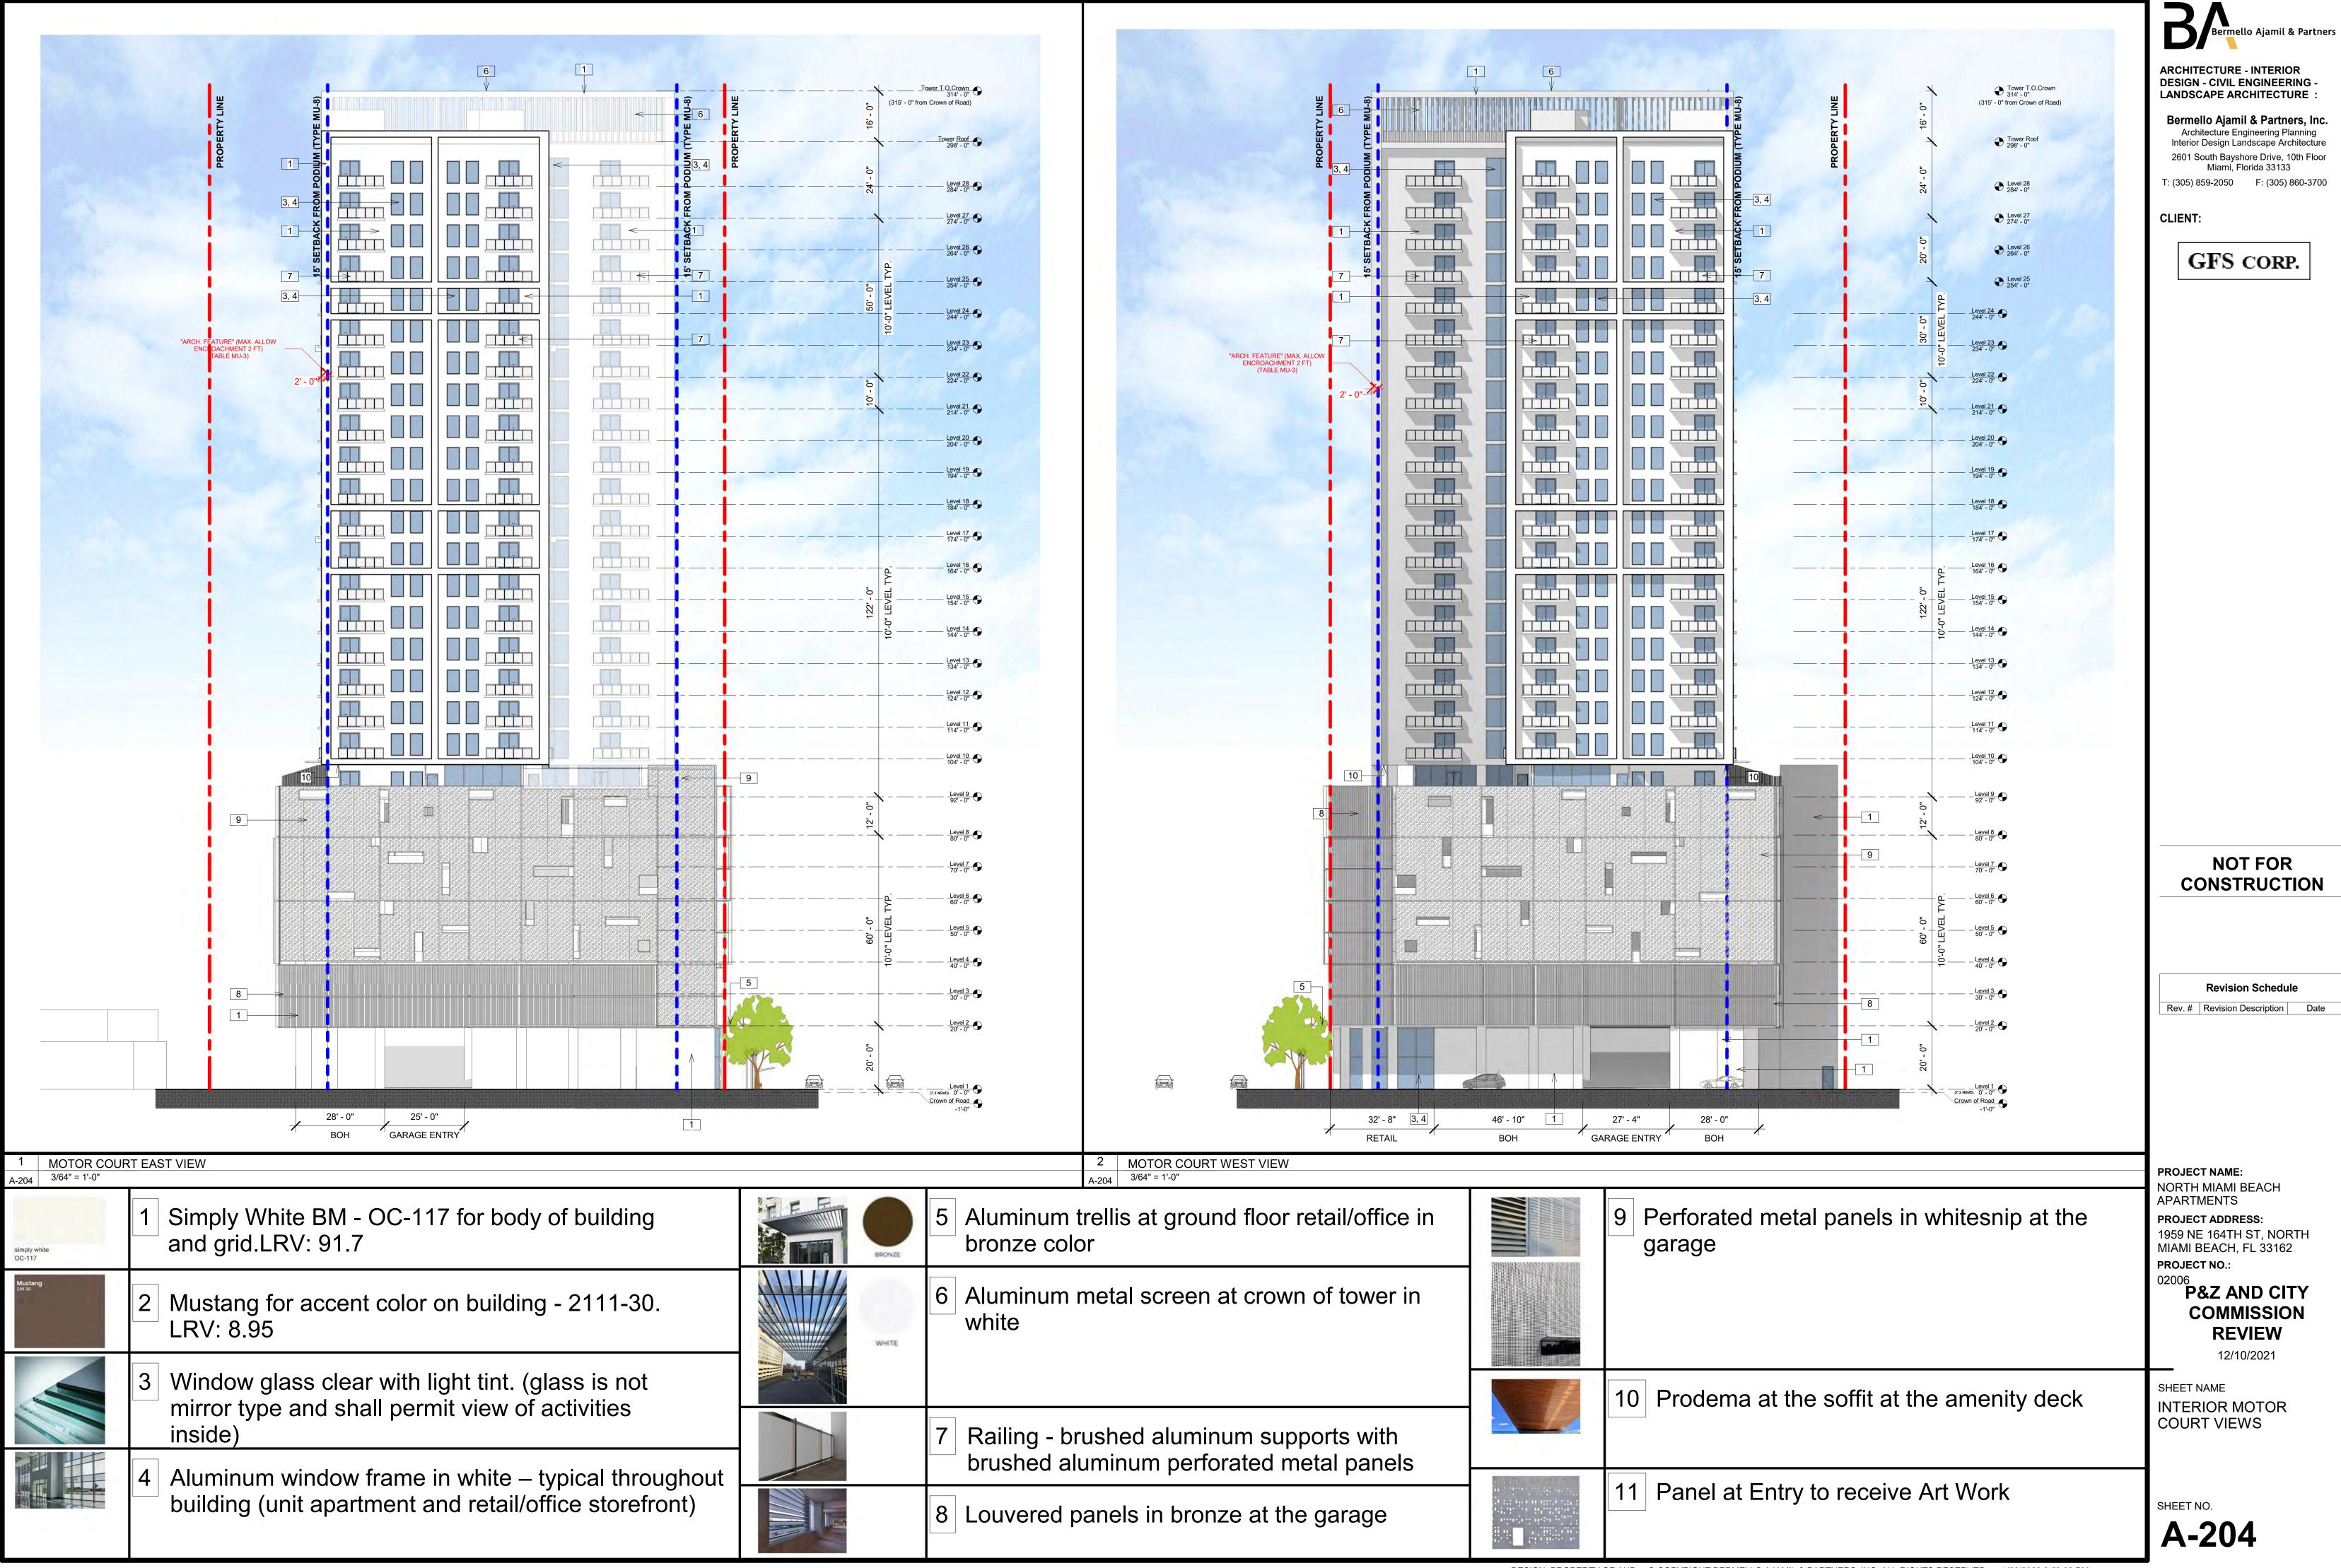

	5 Aluminum trellis at ground floor retail/office in bronze color	
WHITE	6 Aluminum metal screen at crown of tower in white	
	7 Railing - brushed aluminum supports with brushed aluminum perforated metal panels	
	8 Louvered panels in bronze at the garage	

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Aluminum metal screen at crown of tower in white




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		UNIT "J"	UNIT "U"		\square	UNIT "U"	UNIT ".	J		UNIT "I"	UNIT "X"	UNIT "X"	
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Railing - brushed aluminum supports with brushed alum. perforated metal panels



Louvered panels in bronze at the garage



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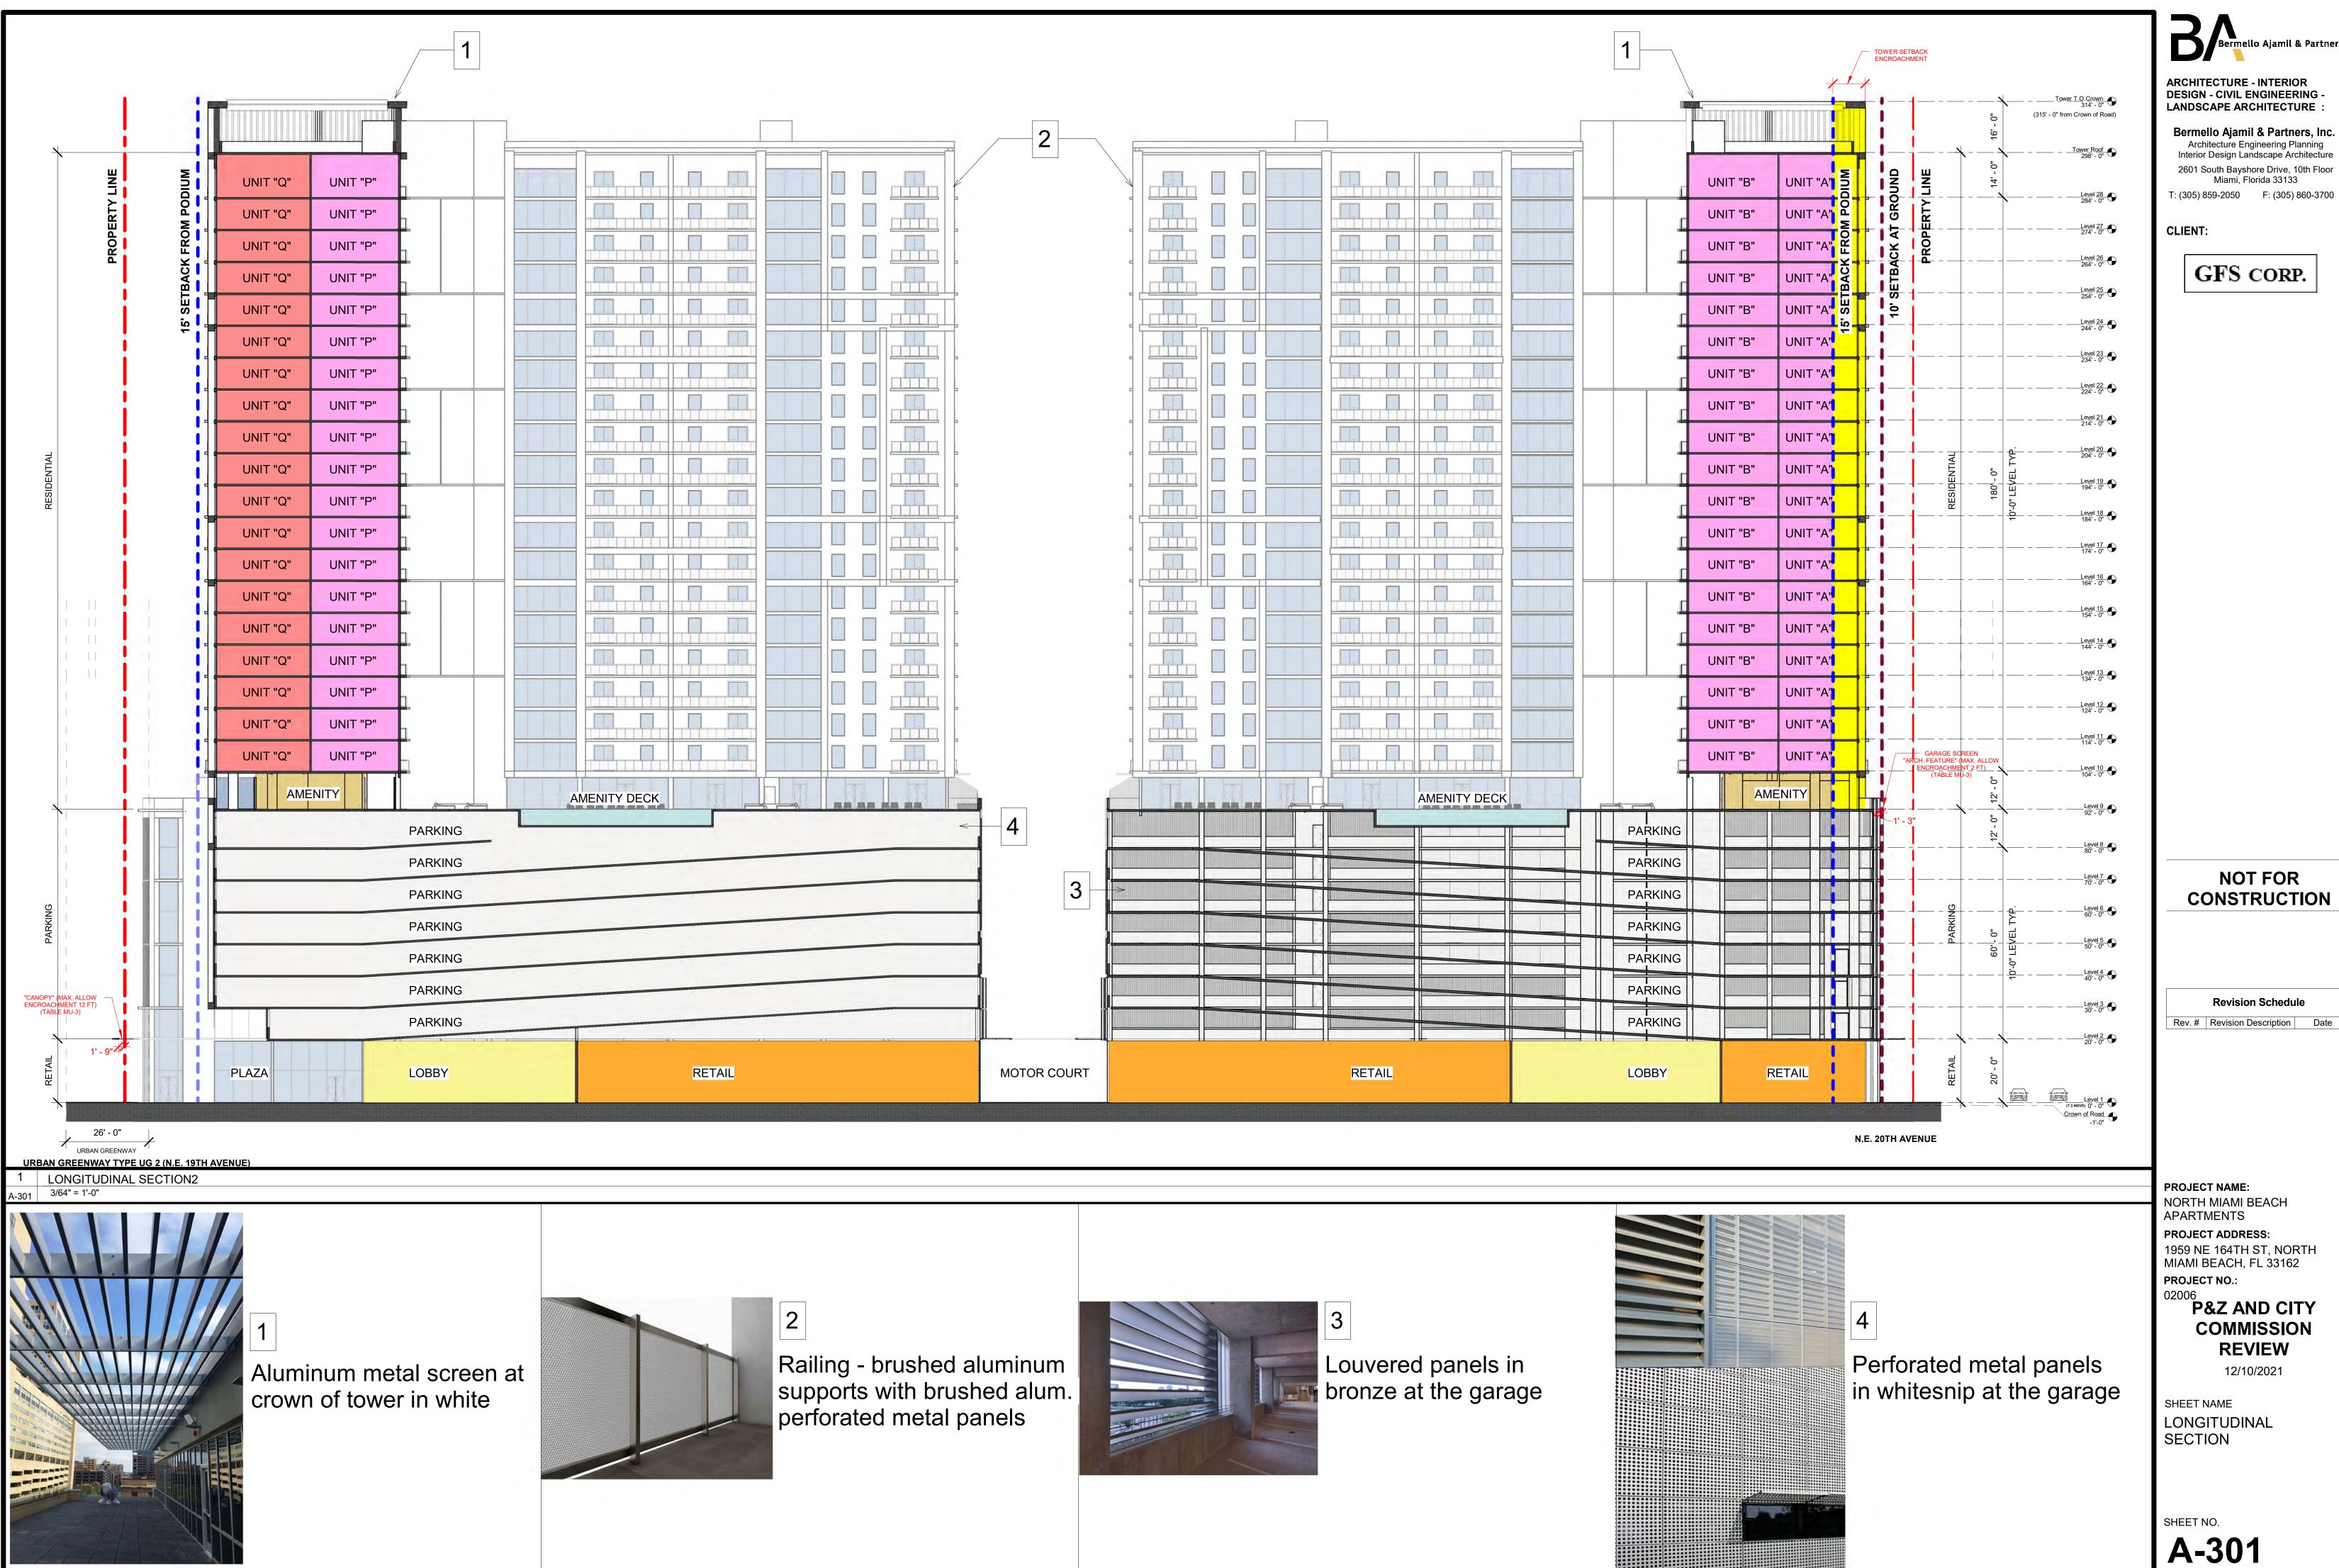
Revision Schedule Rev. # Revision Description Date

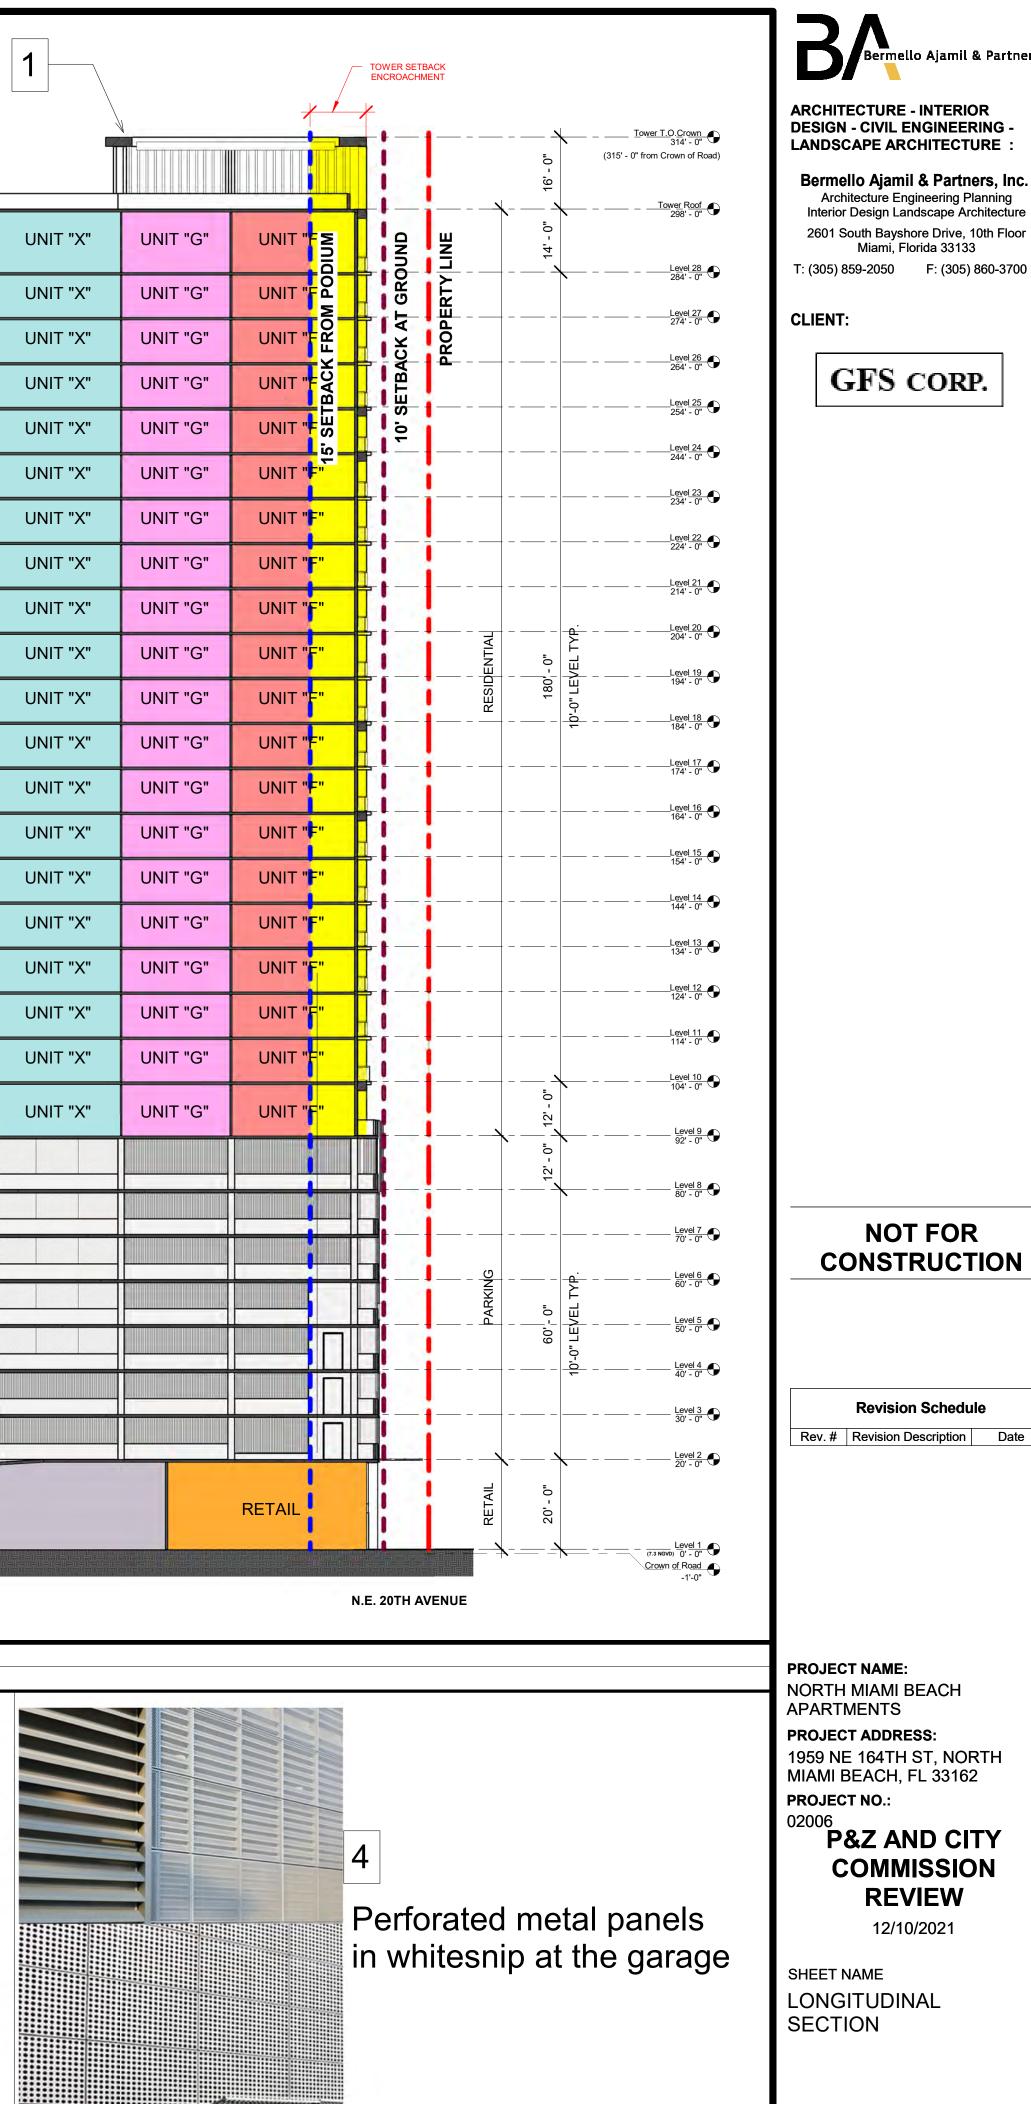NORTH MIAMI BEACH APARTMENTS **PROJECT ADDRESS:** 1959 NE 164TH ST, NORTH MIAMI BEACH, FL 33162 PROJECT NO.: P&Z AND CITY

COMMISSION REVIEW 12/10/2021


SHEET NAME LONGITUDINAL SECTION

SHEET NO. A-300



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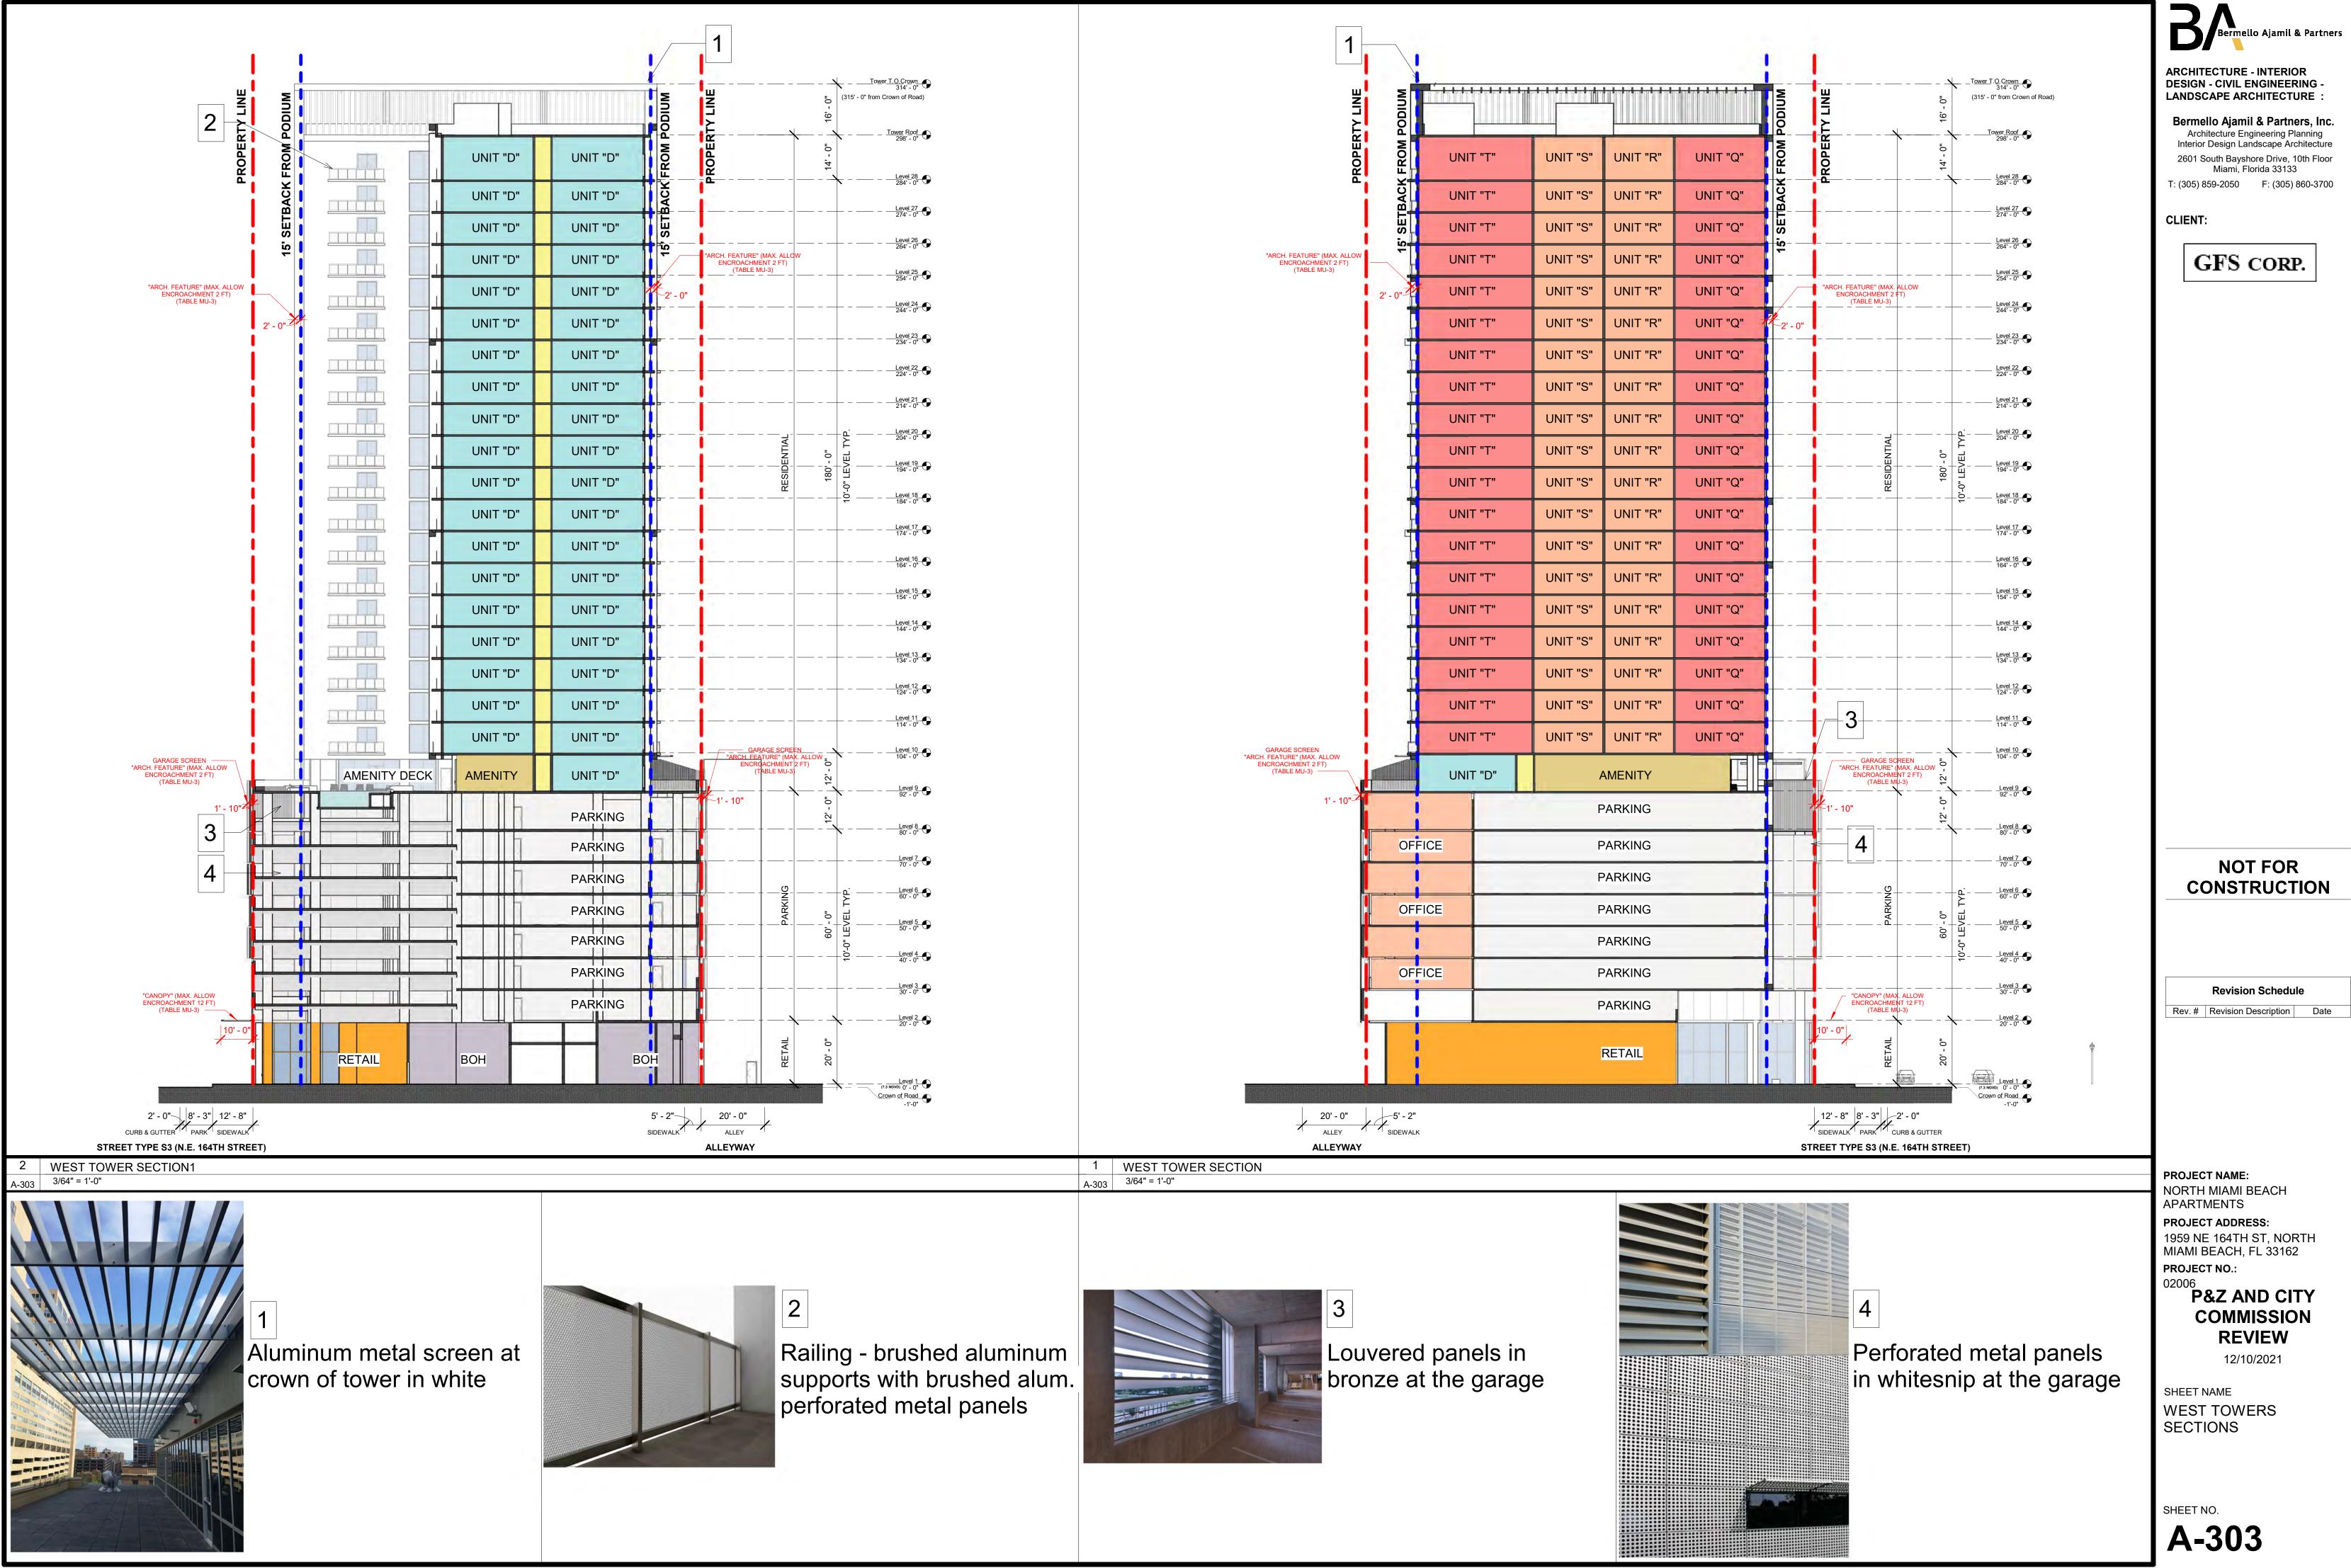
Bermello Ajamil & Partners



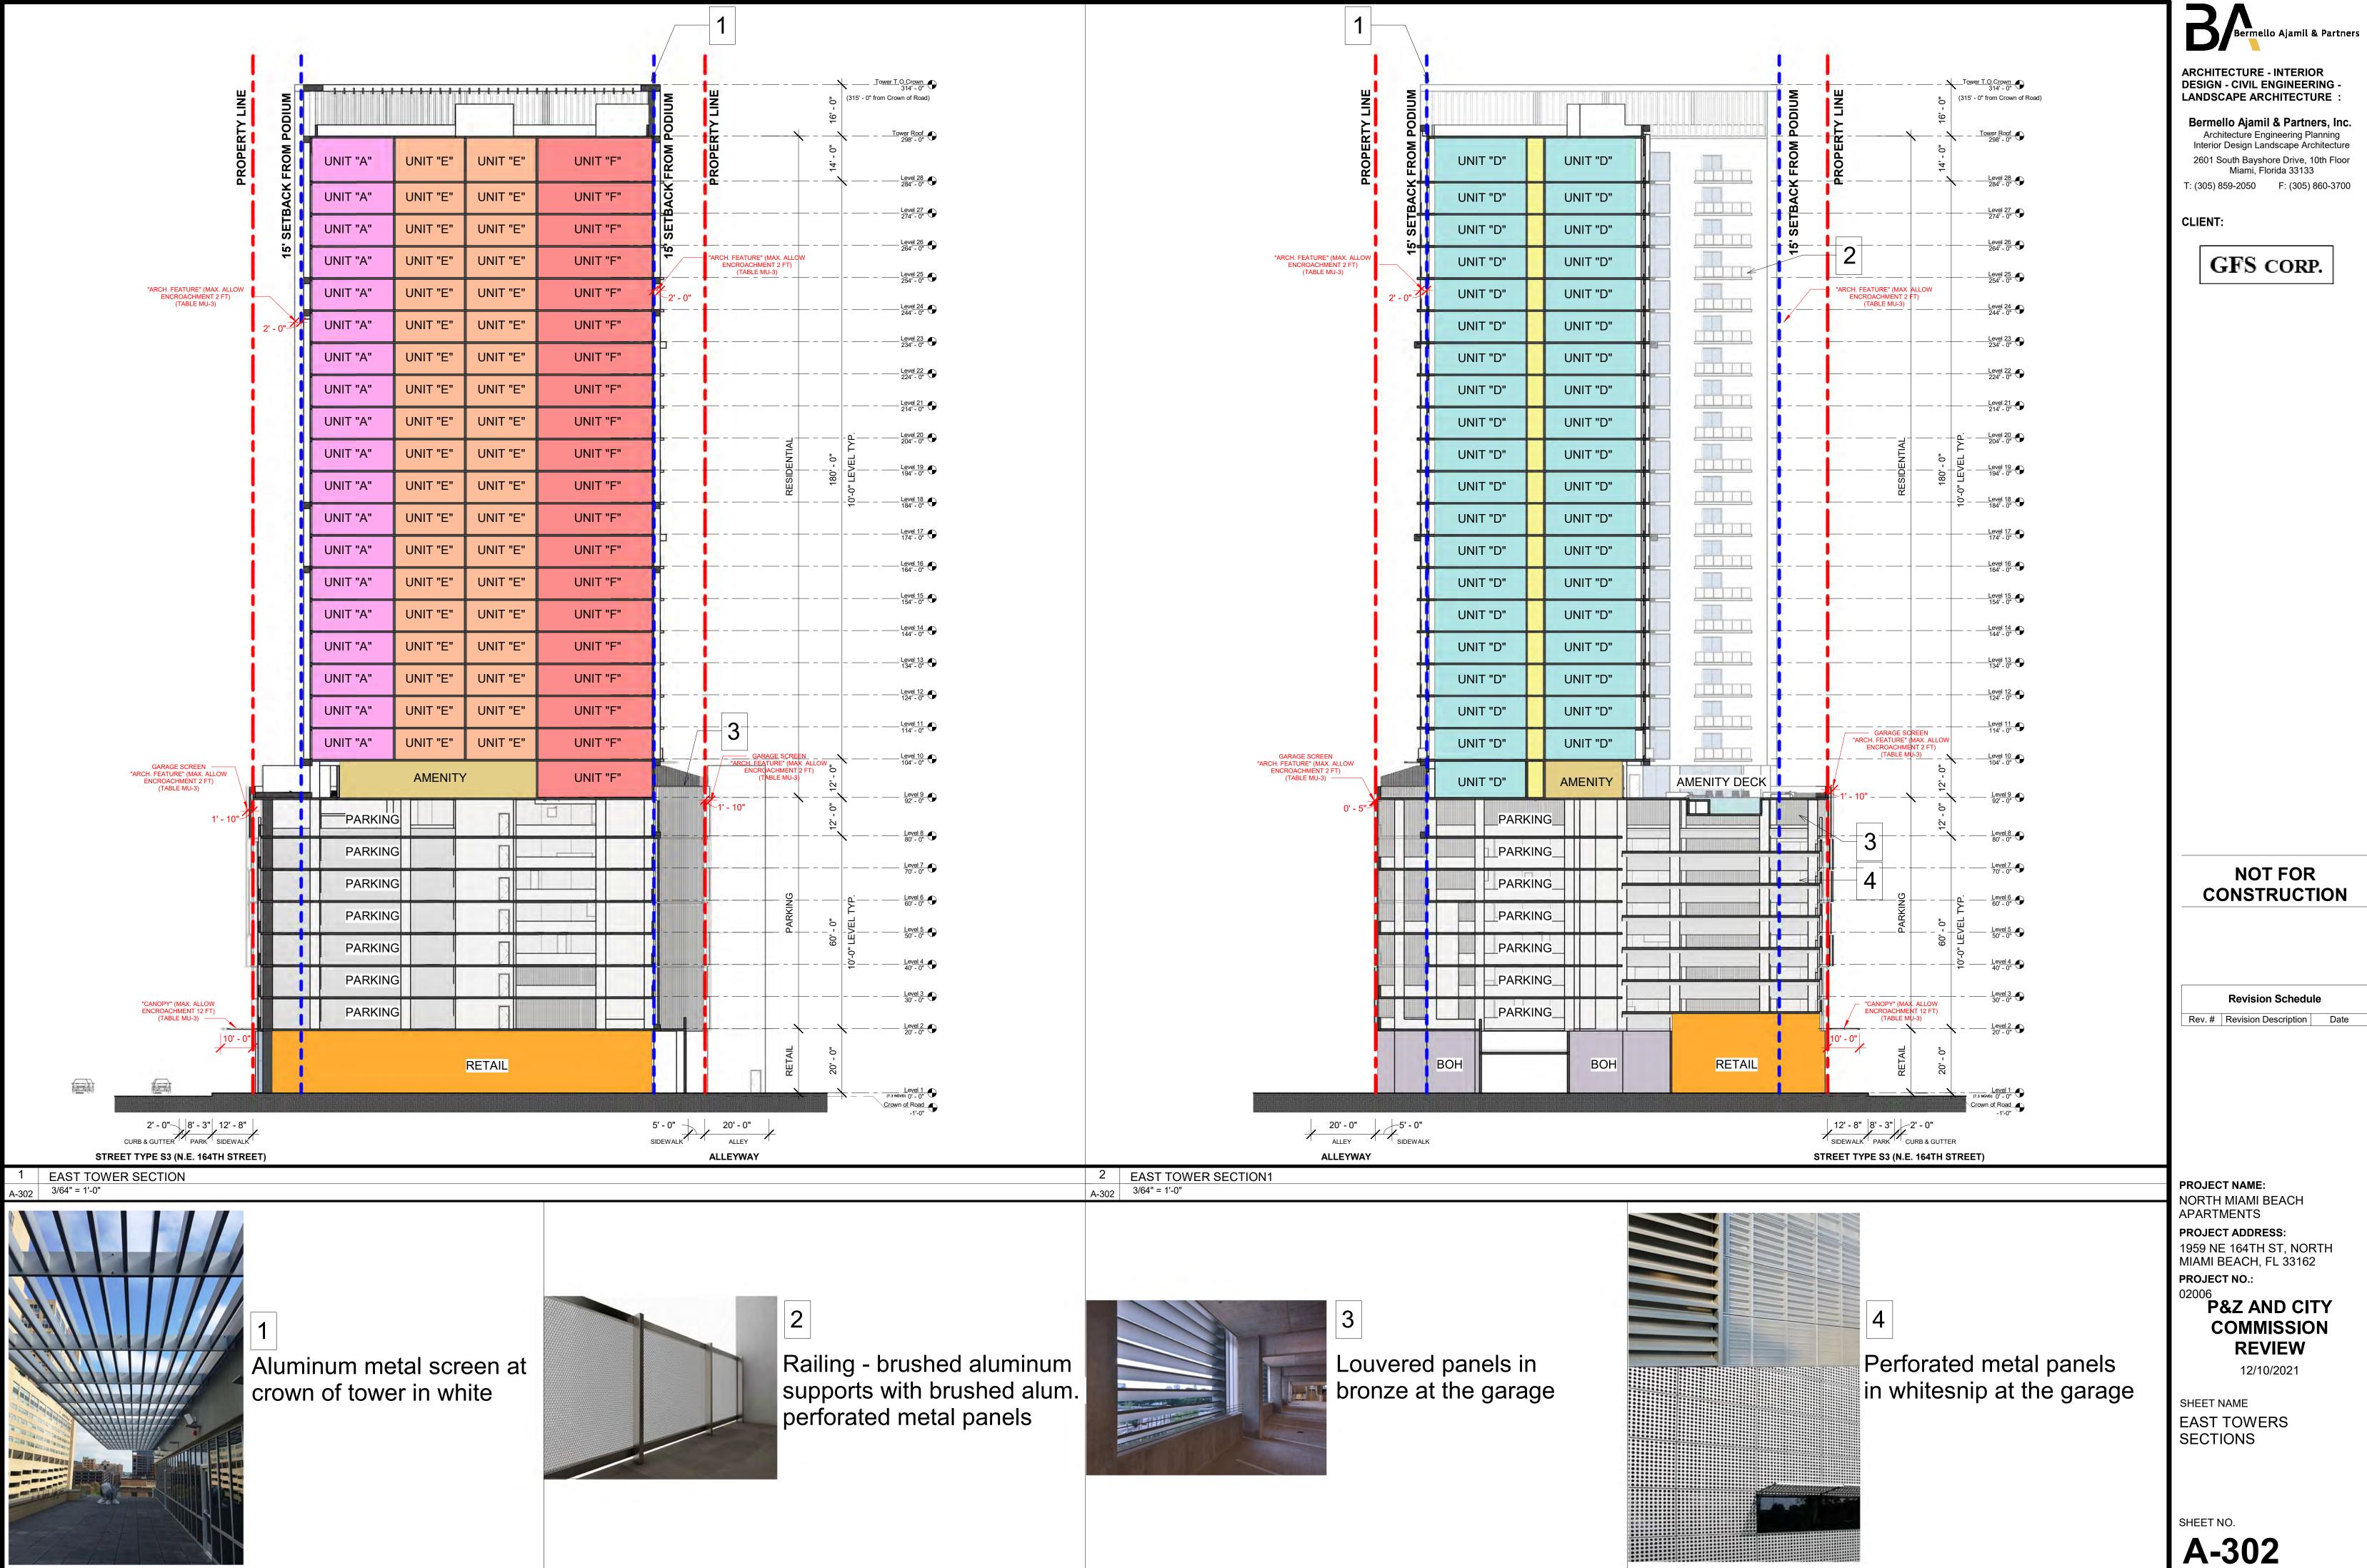





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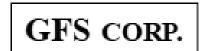


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T: (305) 859-2050 F: (305) 860-3700

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Revision Schedule Rev. # Revision Description Date

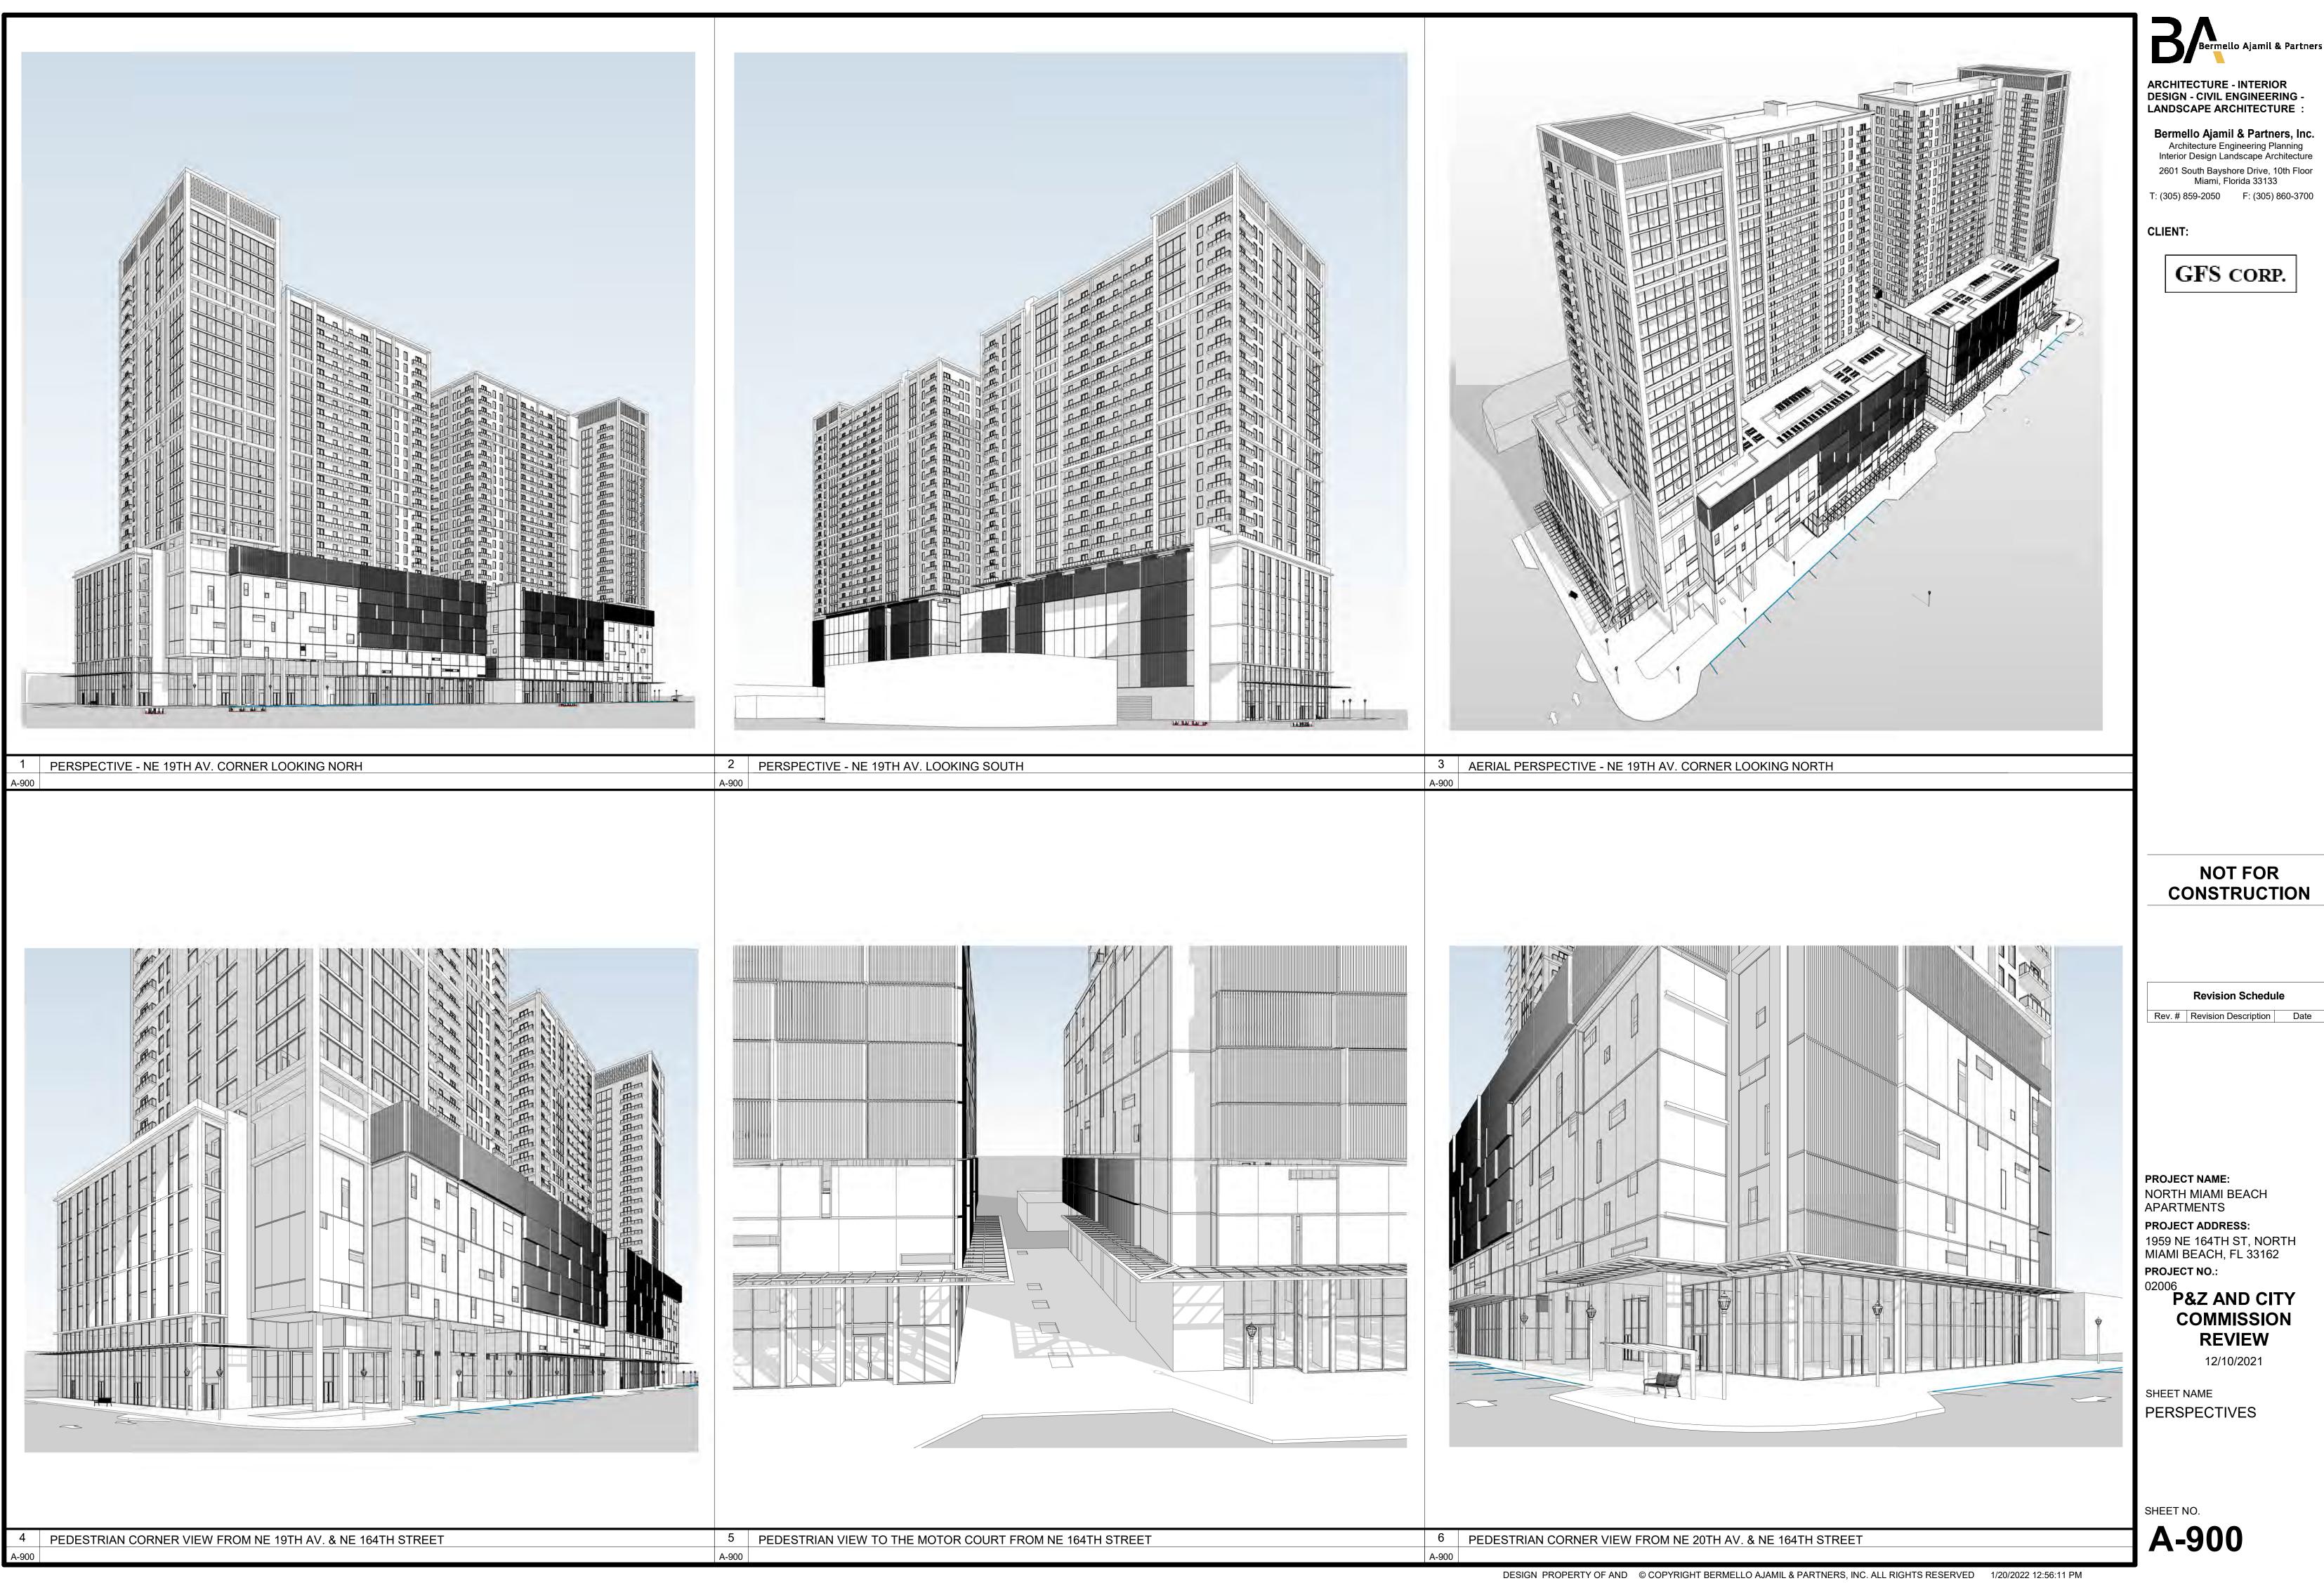PROJECT NAME: NORTH MIAMI BEACH APARTMENTS PROJECT ADDRESS:

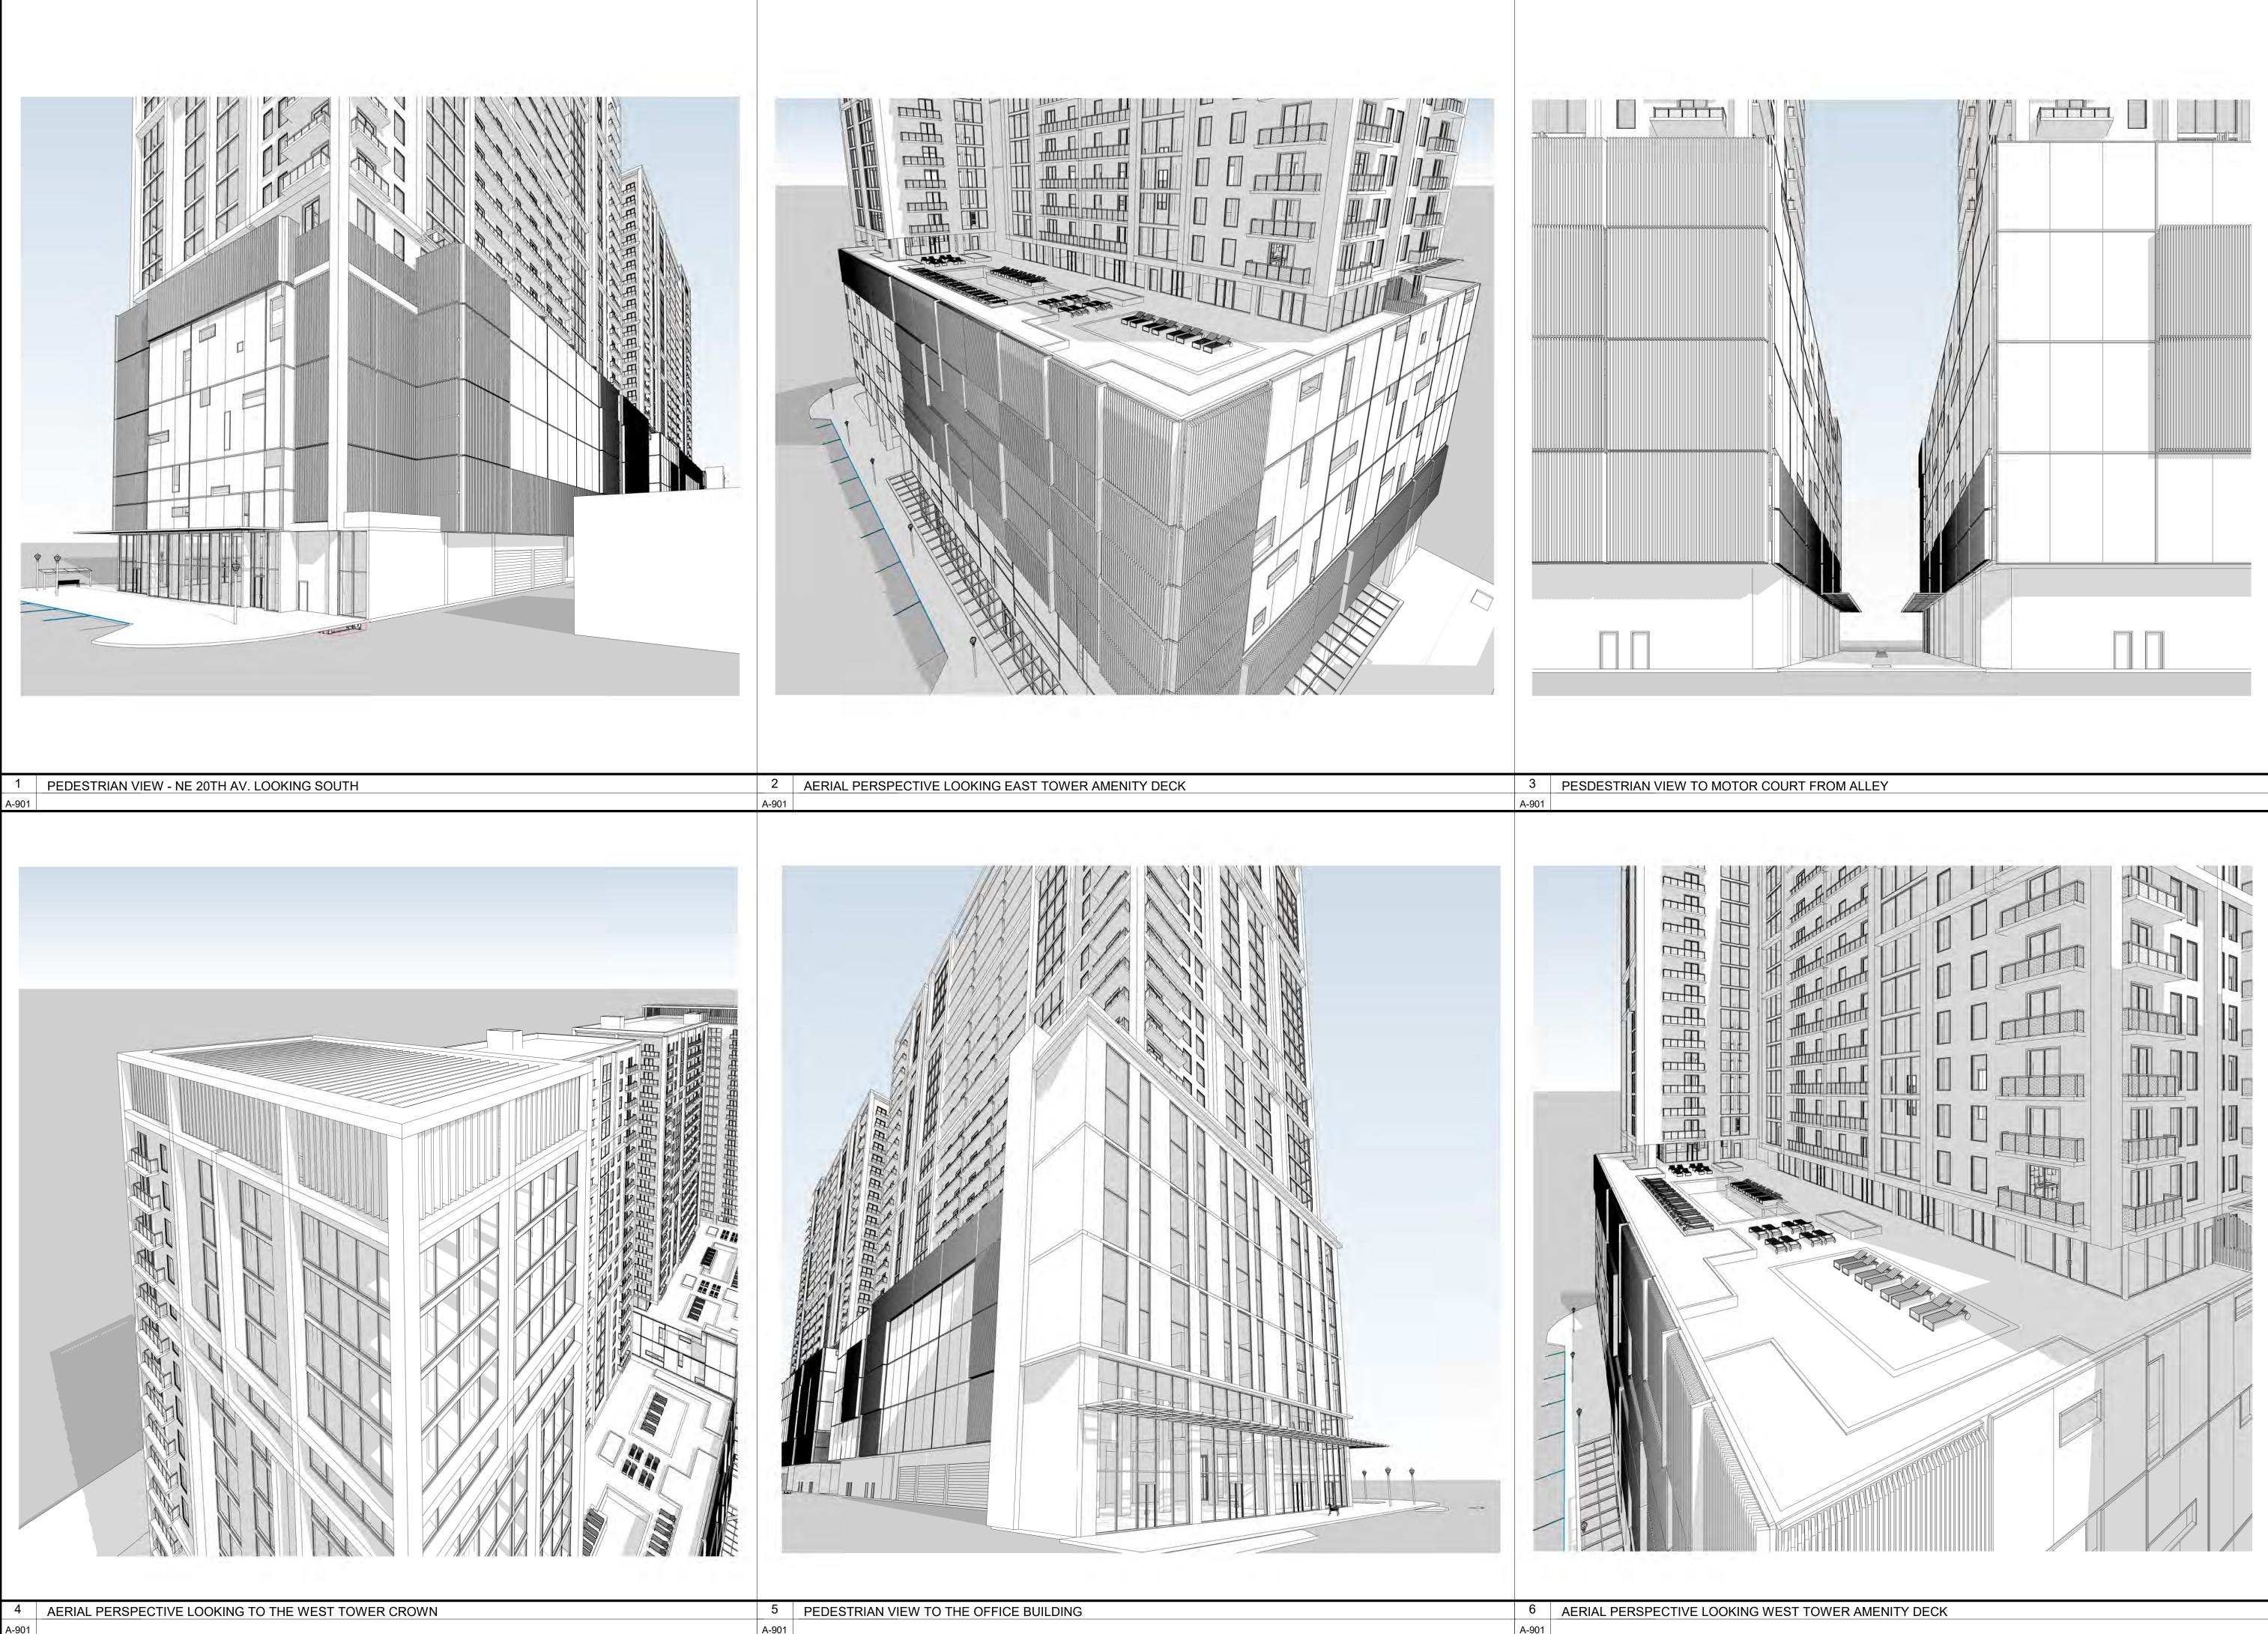1959 NE 164TH ST, NORTH MIAMI BEACH, FL 33162 PROJECT NO.: 02006

P&Z AND CITY COMMISSION REVIEW 12/10/2021

SHEET NAME PERSPECTIVES

SHEET NO. A-901







SHEET NAME **RENDERING - STREET** VIEW PERSPECTIVE

REVIEW 12/10/2021

PROJECT NO.: P&Z AND CITY COMMISSION

PROJECT ADDRESS: 1959 NE 164TH ST, NORTH MIAMI BEACH, FL 33162

PROJECT NAME: NORTH MIAMI BEACH APARTMENTS

Revision Schedule Rev. # Revision Description Date

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Bermello Ajamil & Partners, Inc. Architecture Engineering Planning Interior Design Landscape Architecture

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T: (305) 859-2050 F: (305) 860-3700

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SHEET NO. A-903

SHEET NAME **RENDERING - SOUTH** AERIAL VIEW

COMMISSION REVIEW 12/10/2021

PROJECT ADDRESS: 1959 NE 164TH ST, NORTH MIAMI BEACH, FL 33162 PROJECT NO.: P&Z AND CITY

PROJECT NAME: NORTH MIAMI BEACH APARTMENTS

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Revision Schedule

Rev. # Revision Description Date

ARCHITECTURE - INTERIOR DESIGN - CIVIL ENGINEERING -LANDSCAPE ARCHITECTURE : Bermello Ajamil & Partners, Inc. Architecture Engineering Planning Interior Design Landscape Architecture

2601 South Bayshore Drive, 10th Floor Miami, Florida 33133 T: (305) 859-2050 F: (305) 860-3700

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RENDERING -PEDESTRIAN VIEW PERSPECTIVE

12/10/2021 SHEET NAME

P&Z AND CITY COMMISSION REVIEW

NORTH MIAMI BEACH APARTMENTS PROJECT ADDRESS: 1959 NE 164TH ST, NORTH MIAMI BEACH, FL 33162 PROJECT NO.:

Rev. # Revision Description Date

Revision Schedule

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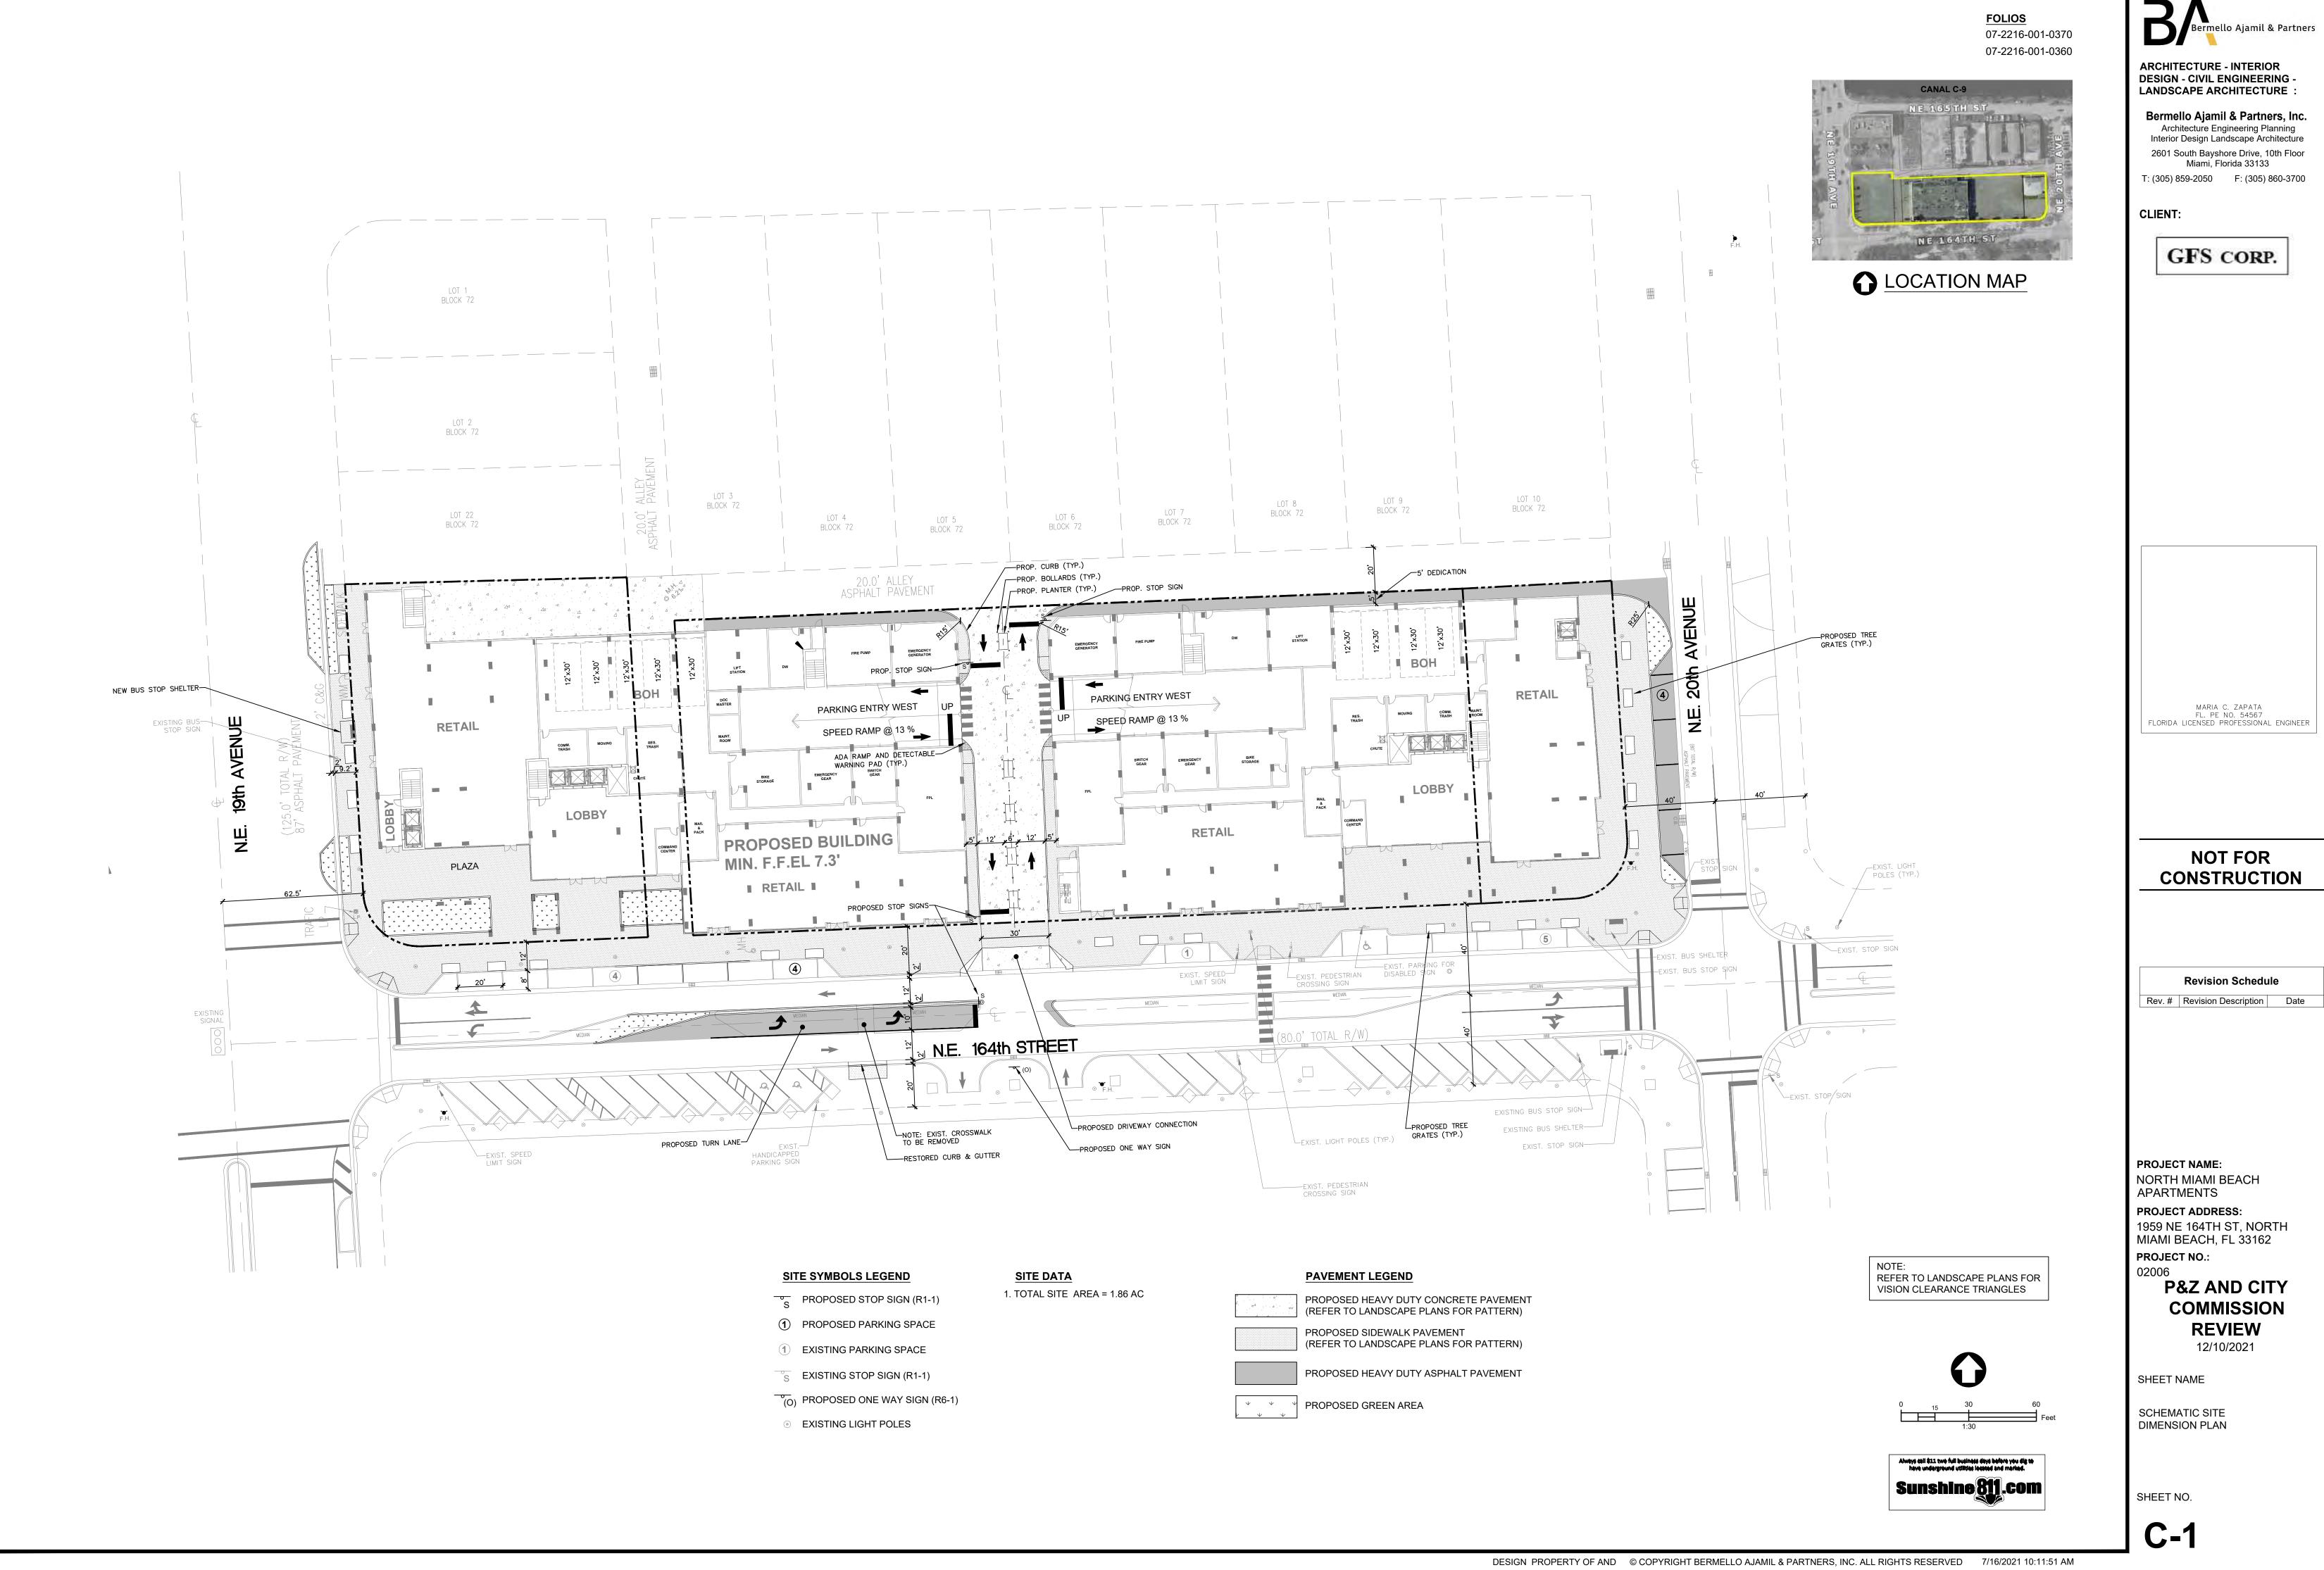
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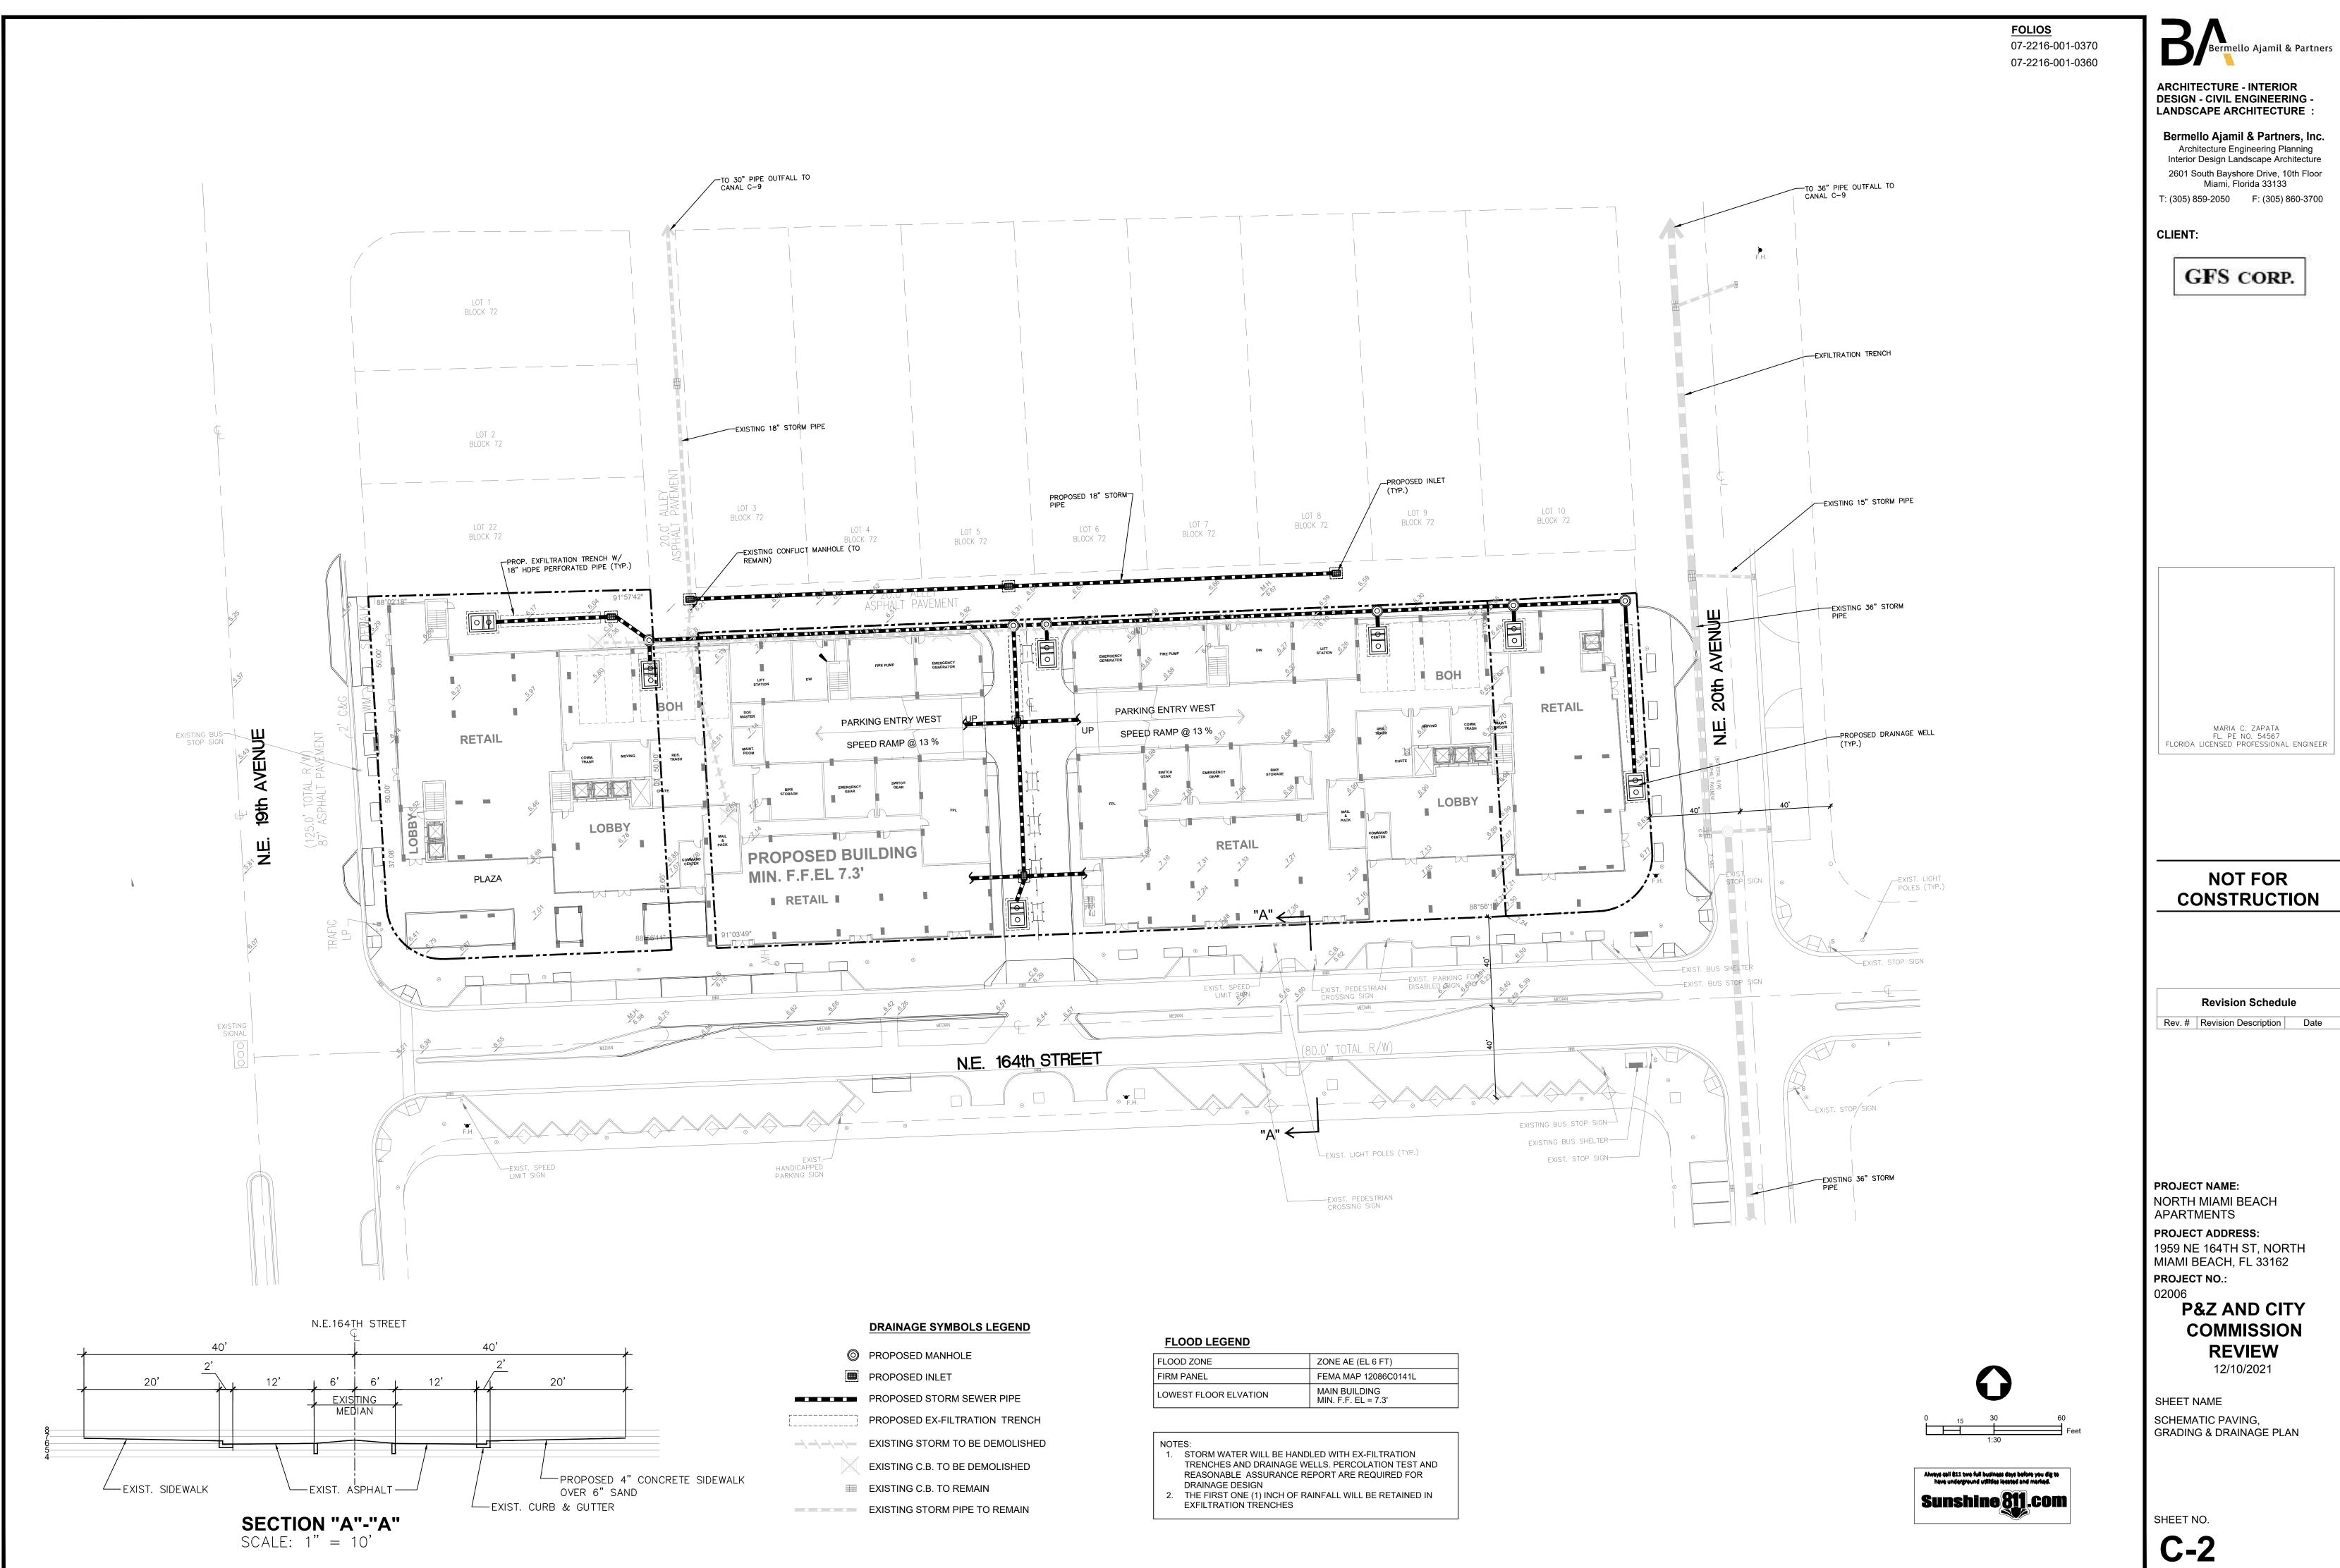
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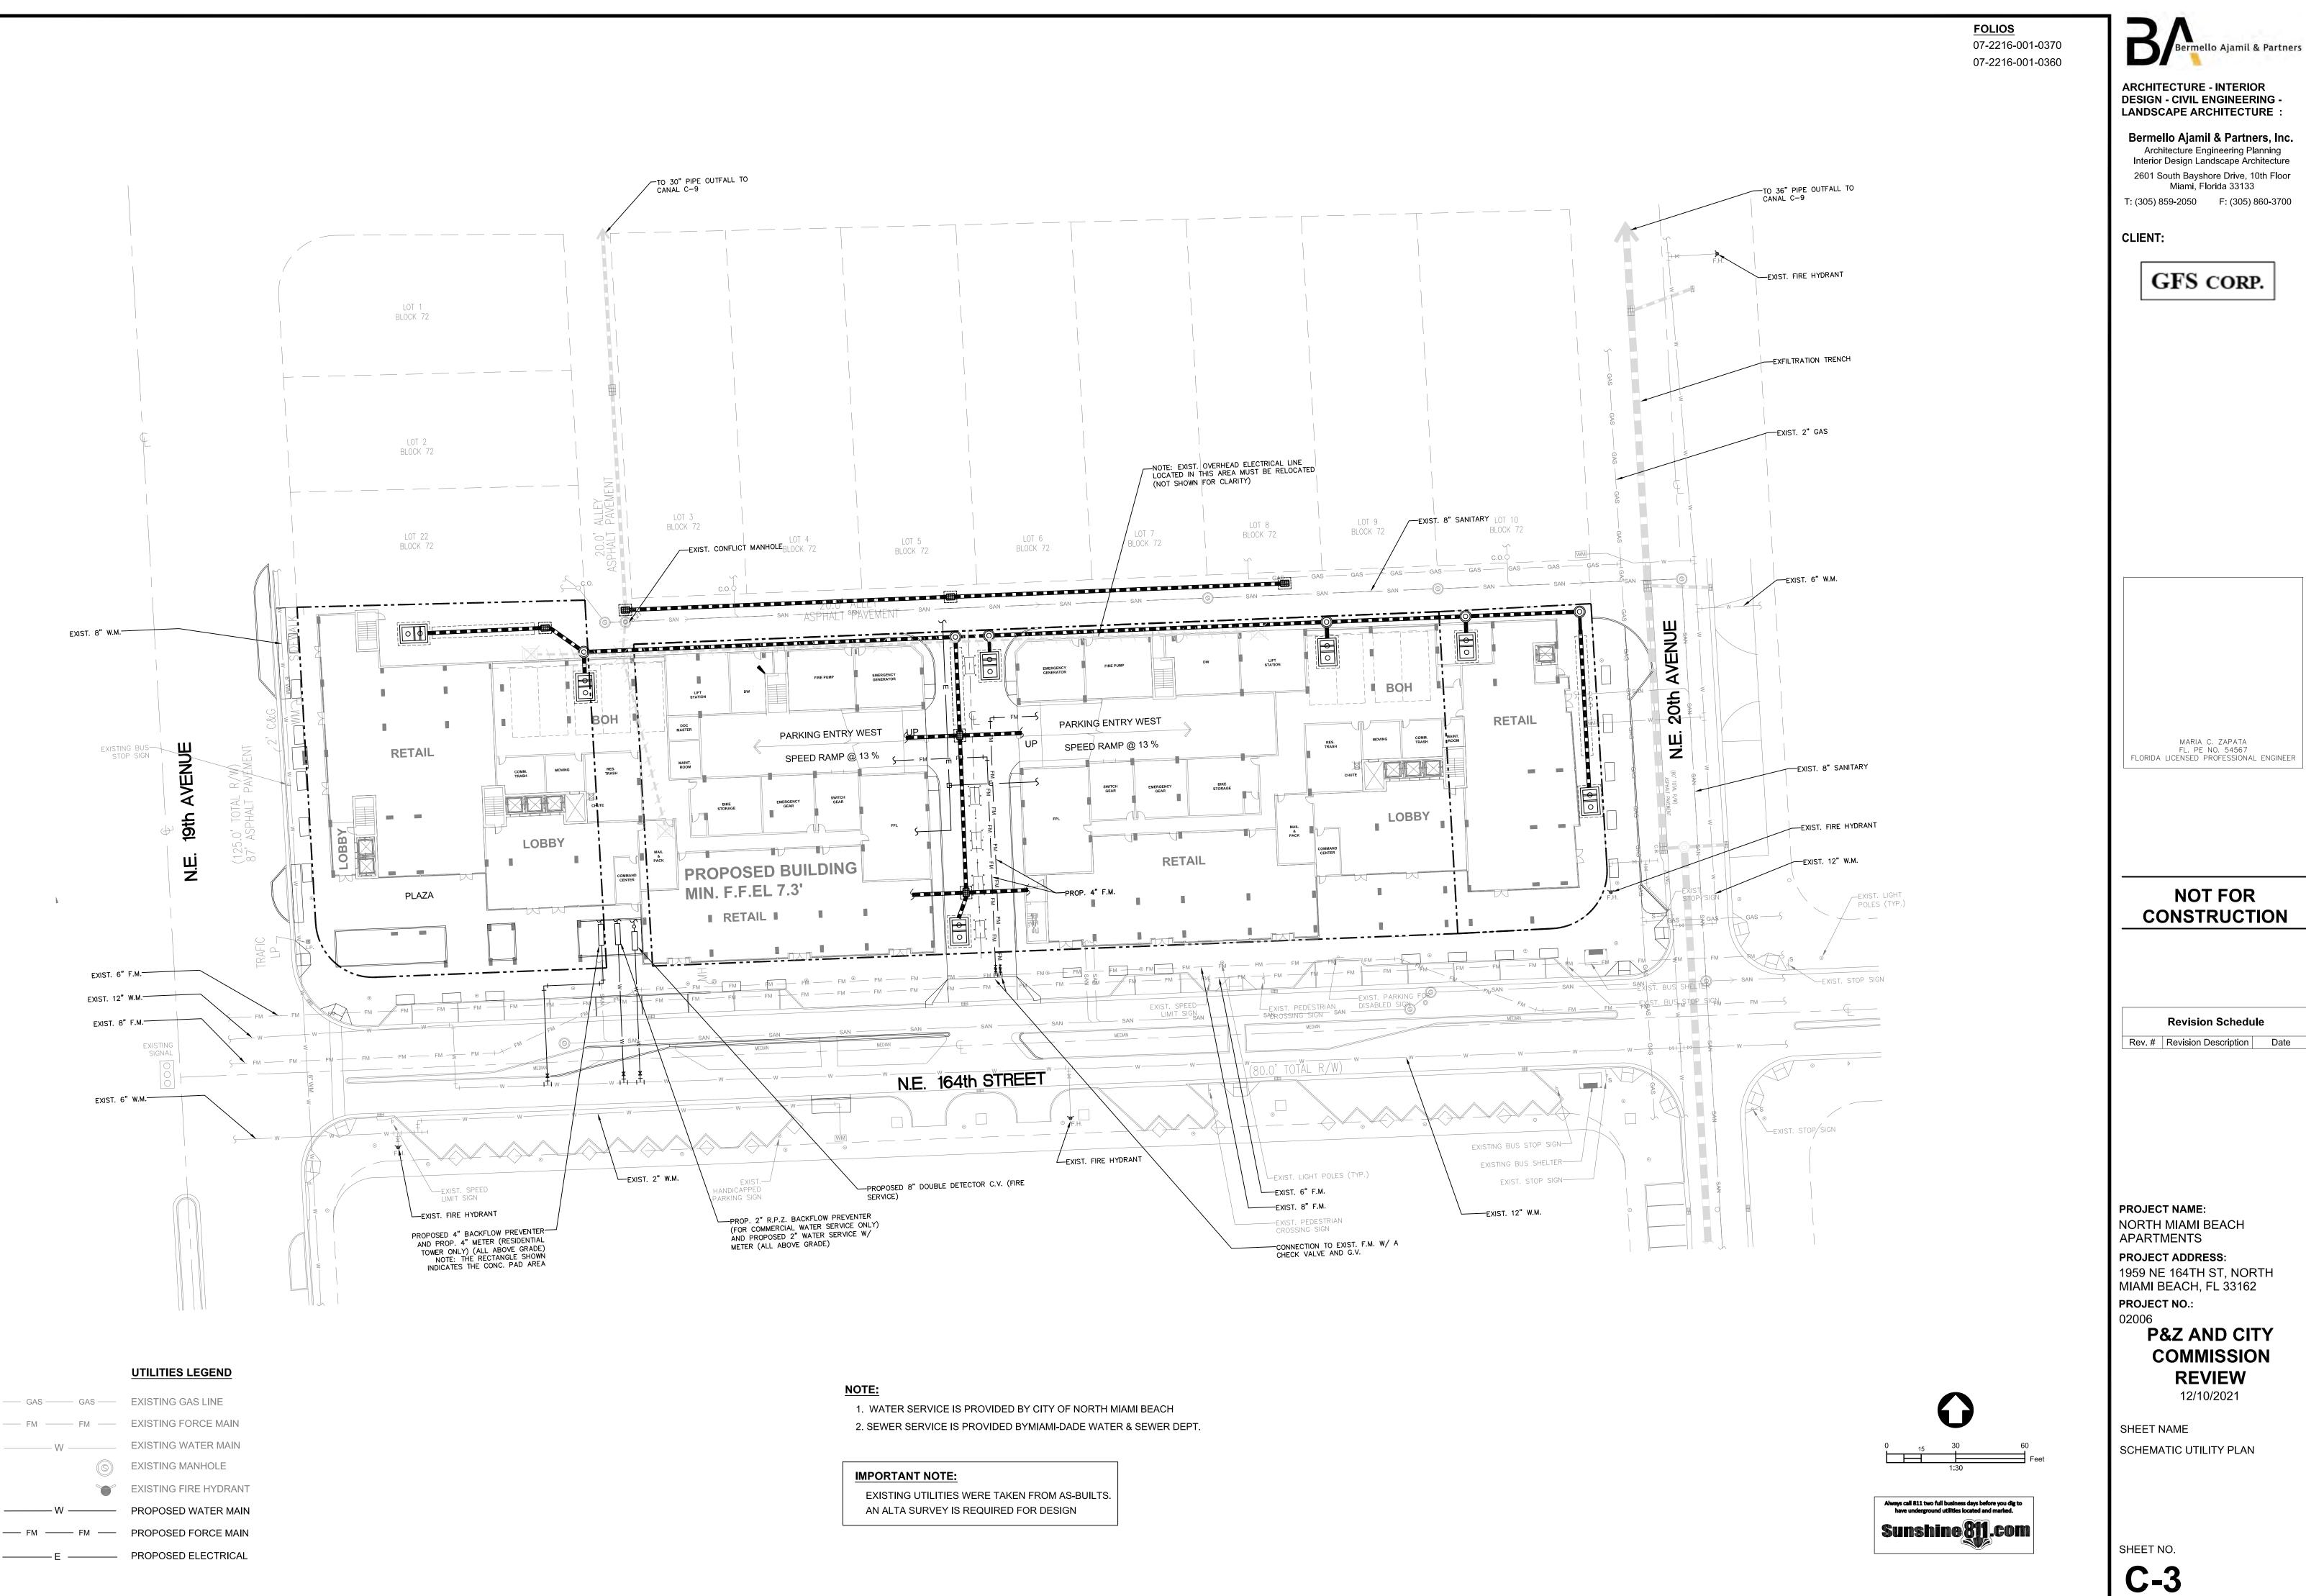
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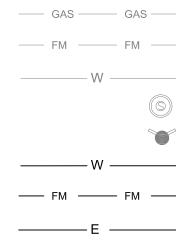


4 ⁴	PROPOSED HEAVY DUTY CONCRETE PAVEMENT (REFER TO LANDSCAPE PLANS FOR PATTERN)
	PROPOSED SIDEWALK PAVEMENT (REFER TO LANDSCAPE PLANS FOR PATTERN)
	PROPOSED HEAVY DUTY ASPHALT PAVEMENT
ψ ψ ψ	PROPOSED GREEN AREA



FLOOD ZONE	ZONE AE (EL 6 FT)
FIRM PANEL	FEMA MAP 12086C0141L
LOWEST FLOOR ELVATION	MAIN BUILDING MIN, F.F., FI, = 7,3'






٩						TRUNK	, , _ , _ , _ , _ , _ , _ , _ , _ , _ ,			AREA OF CANOP
	NUMBER				DISPOSITION	CALIPER (FT.)		SPREAD (FT.)	COMMENTS	REMOVED (SQ. F
	2	Quercus virginiana Quercus virginiana	Live Oak Live Oak	FAIR FAIR	REMOVE REMOVE	1	25 25	25 20	NATIVE NATIVE	490.6
	3	Adonidia merrillii	Christmas Palm Triple	FAIR	REMOVE	0.5	18	12	NON-NATIVE	113.0
	4 5	Quercus virginiana Quercus virginiana	Live Oak Live Oak	POOR FAIR	REMOVE REMOVE	0.9 0.8	20 25	18 20	NATIVE NATIVE	254.3 314.0
	6	Quercus virginiana	Live Oak	FAIR	REMOVE	0.9 0.8	28	20	NATIVE	314.0
	7 8	Quercus virginiana Sabal Palmetto	Live Oak Cabbage Palm	POOR FAIR	REMAIN REMOVE	0.8	20 22	18 12	NATIVE NATIVE	113.0
	9	Sabal Palmetto Sabal Palmetto	Cabbage Palm	FAIR	REMOVE	1	18	12	NATIVE	113.0
	10 11	Ptychosperma elegans	Cabbage Palm Alexander Palm Triple	FAIR POOR	REMOVE REMOVE	0.6	22 14	12 10	NATIVE NON-NATIVE	113.0
	12	Quercus virginiana	Live Oak	FAIR	REMAIN	0.7	20	20	NATIVE	
	13 14	Quercus virginiana Quercus virginiana	Live Oak Live Oak	FAIR POOR	REMAIN REMAIN	0.9	25 25	20 18	NATIVE NATIVE	
	15	Quercus virginiana	Live Oak	FAIR	REMOVE	0.9	25	20	NATIVE	314.0
	16 17	Quercus virginiana Quercus virginiana	Live Oak Live Oak	FAIR FAIR	REMOVE REMOVE	0.8	27 25	20 20	NATIVE NATIVE	<u> </u>
	18	Quercus virginiana	Live Oak	FAIR	REMAIN	0.9	25	20	NATIVE	
	19 20	Quercus virginiana Ptychosperma elegans	Live Oak Alexander Palm	FAIR FAIR	REMAIN REMOVE	0.6	25 27	20 10	NATIVE NON-NATIVE	78.5
	21	Ptychosperma elegans			REMOVE	0.6 0.6	14	8		50.2
	22 23	Quercus virginiana	Alexander Palm Double Live Oak	POOR FAIR	REMOVE REMOVE	1	14 22	8 20	NON-NATIVE NATIVE	50.2 314.0
	24	Quercus virginiana	Live Oak	POOR	REMOVE	0.9	20	20	NATIVE	314.0
	25 26	Quercus virginiana Quercus virginiana	Live Oak Live Oak	POOR FAIR	REMOVE REMOVE	0.7	20 25	18 20	NATIVE NATIVE	254.3 314.0
	27	Adonidia merrillii	Christmas Palm Double	FAIR	REMOVE	0.5	12	10	NON NATIVE	78.5
	28 29	Adonidia merrillii Adonidia merrillii	Christmas Palm Triple Christmas Palm Triple	FAIR FAIR	REMOVE REMOVE	0.5 0.5	10 15	10 10	NON NATIVE NON NATIVE	78.5
	30	Adonidia merrillii	Christmas Palm Double	FAIR	REMOVE	0.5	15	10	NON NATIVE	78.5
								CANOPY BEING	G REMOVED (IN SQUARE FE	EET) 4,848.9
		MIT	TIGATION TREES REQUI	RED: 1 SHADE TF	REE @ 12' HIGH / 5	00 SF OF CANO	PY REMOVED	4,534.95 SF /	· · · · · · · · · · · · · · · · · · ·	10 TREI
									N REQUIREMENTS (SEE LA	-01) * 10 TREI
	★ MITIG	ATION TREES WIL		FF SITE AT A			1 WITH THE	CITY STAFF	1	1
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MEDIAN

SITE LEGEND					
LINE TYPE	DEFINITION				
	EXISTING FEATURES				
	PROPOSED SITE FEATURES				
	PROPOSED BUILDING				

TREE DISPOSITION LEGEND					
SYMBOL	SYMBOL ACTION				
$\bigotimes_{\#}$	TO BE REMOVED				
$\bigotimes_{\#}$	TO BE RELOCATED				
Ç,	TO REMAIN AND BE PROTECTED				



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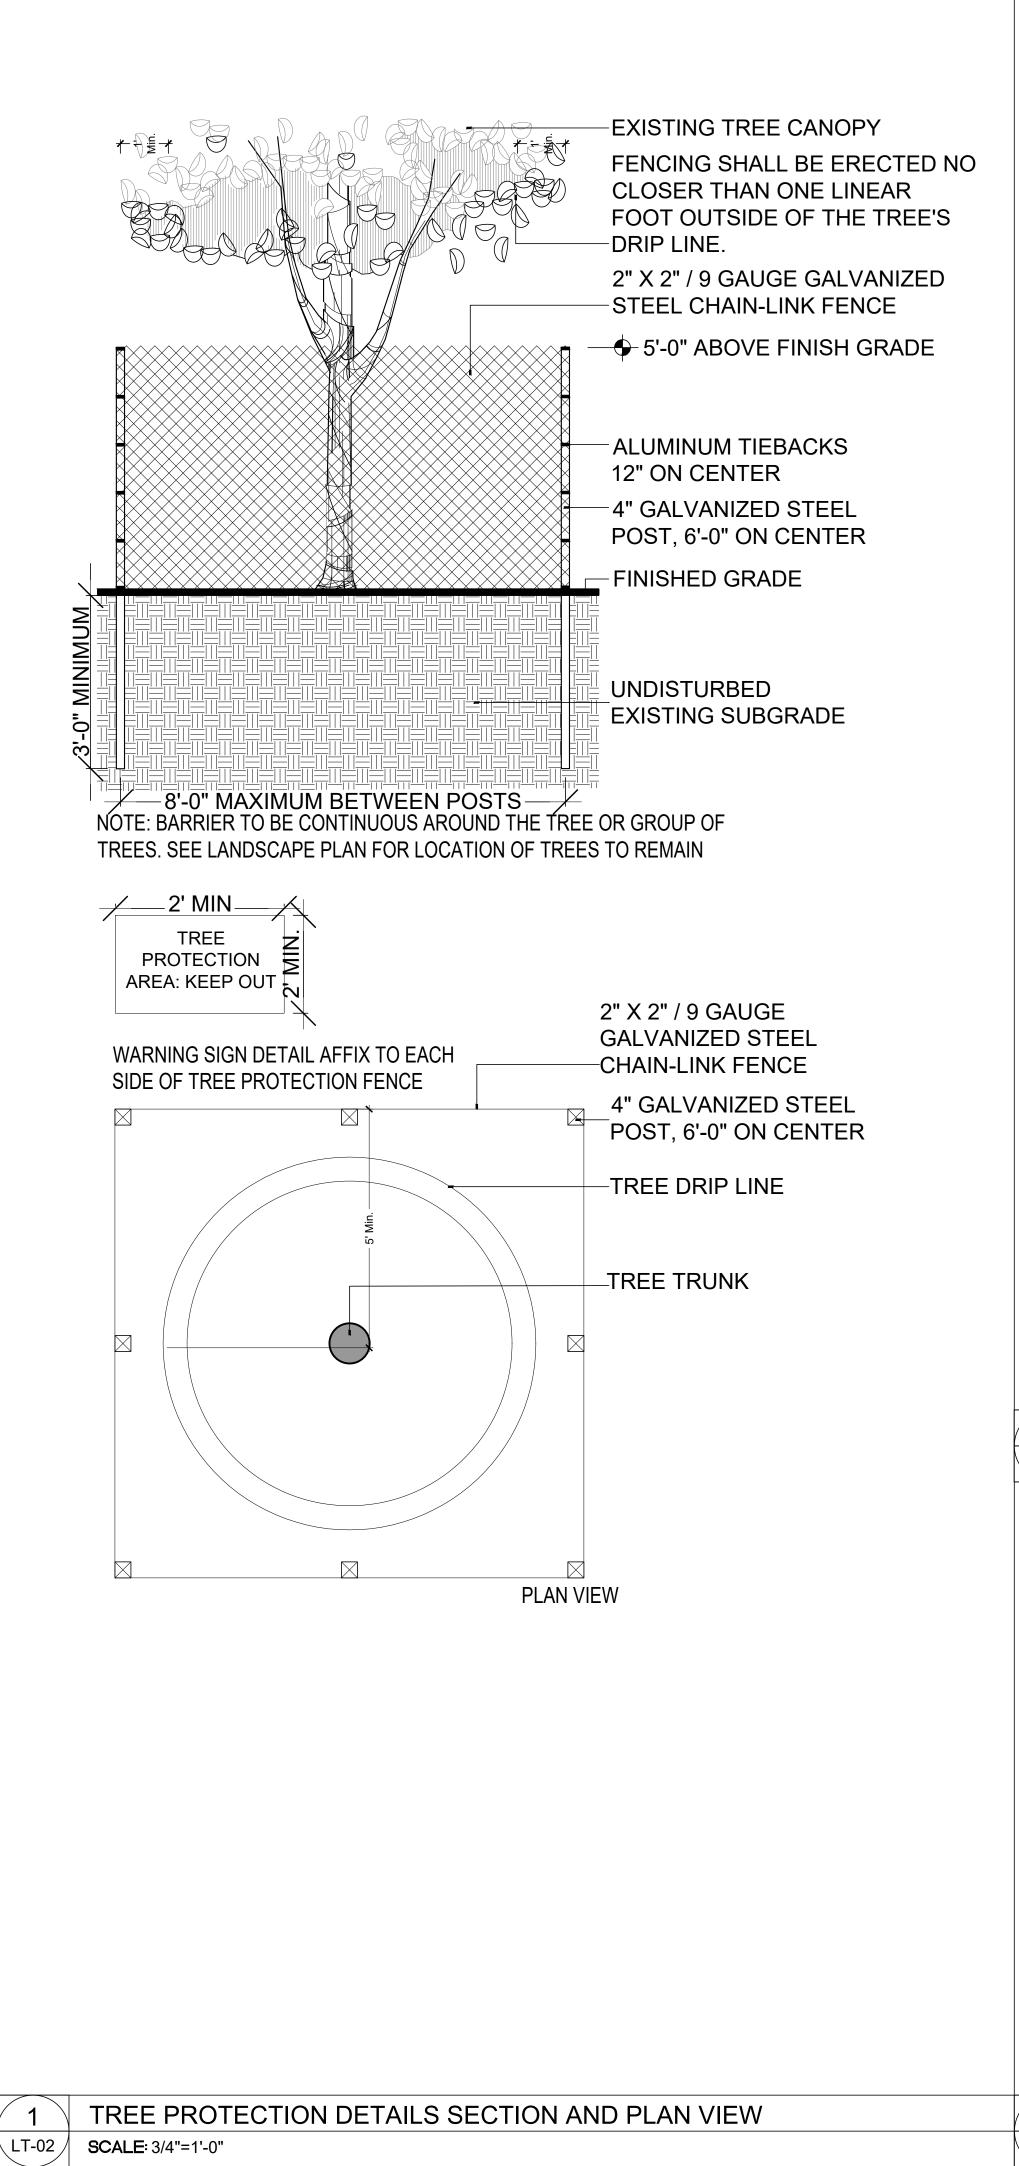

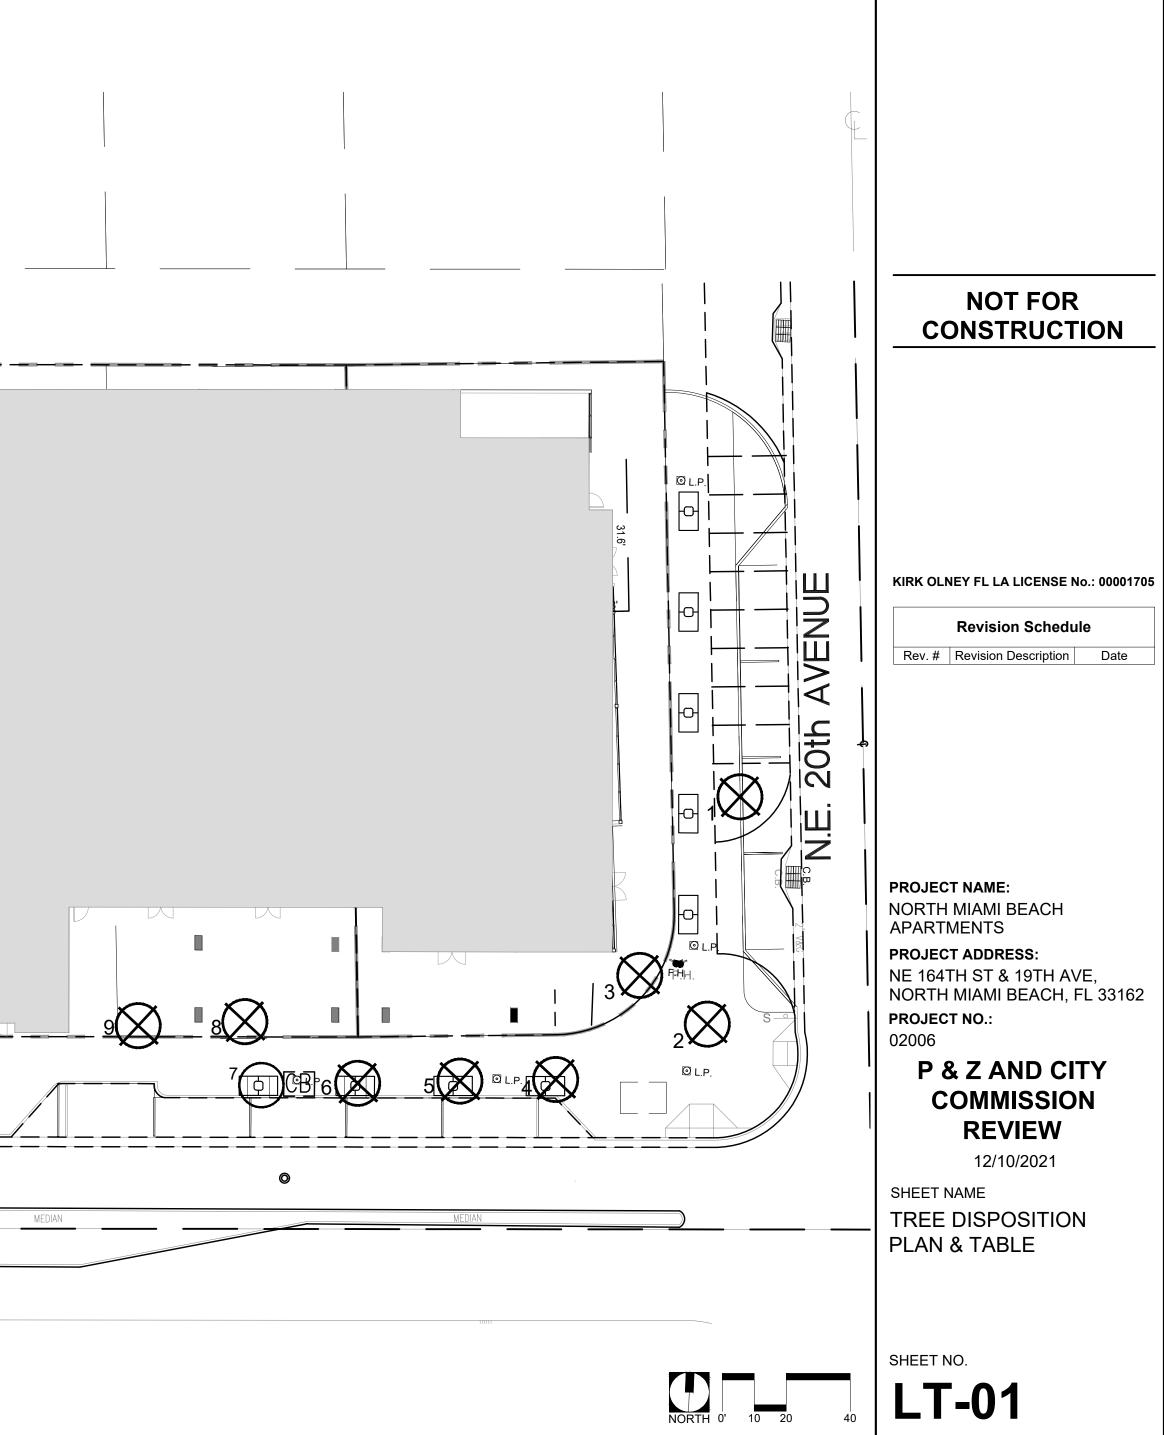
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- 1. IT IS THE CONTRACTOR'S RESPONSIBILITY TO NOTE AND PROTECT THE EXISTING TREES TO REMAIN ON SITE.
- 2. CONTRACTOR SHALL INSTALL A PERMANENT RIGID BARRIER PRIOR TO COMMENCEMENT OF WORK TO PROTECT THE CANOPY, TRUNK AND OR ROOT SYSTEM FROM DAMAGE.
- 3. PROTECTION INCLUDES BUT IS NOT LIMITED TO THE PROHIBITION OF THE FOLLOWING ACTIVITIES UNDER THE CANOPY: STORING OF EQUIPMENT, STOCK PILING OF MATERIALS, TRASH OR DEBRIS AND STORING OF TRAILERS, MACHINERY AND OR VEHICLES.
- 4. PRIOR TO COMMENCEMENT OF ANY WORK, CONTRACTOR SHALL PERFORM ROUTINE MAINTENANCE PER ANSI A300, ON THE EXISTING TREES SHOWN TO REMAIN. THIS INCLUDES REMOVAL OF DEAD/DECAYED WOOD, REMOVAL OF ATTACHED BRANCHES AND STRUCTURALLY UNSOUND LIMBS AS WELL AS REMOVAL OF SUBORDINATED BRANCHES. WHERE INCLUDED BARK IS PRESENT REMOVE BRANCHES AS NEEDED TO INCREASE LIGHT AND AIR PENETRATION WITHIN THE CANOPY. UNDER NO CIRCUMSTANCES SHALL MORE THAT 25% OF ANY CANOPY BE REMOVED IN A TWELVE MONTH PERIOD. REDUCTION OF OVERALL CANOPY SIZE IS PROHIBITED.
- 5. PER ANSI A300, CONTRACTOR SHALL REMOVE DEAD BRANCHES AND SUCKERS FROM PRESERVED TREES.
- 6. PER ANSI A300, CONTRACTOR SHALL REMOVE RIPPED, TORN OR "LION TAILED' BRANCHES FROM PRESERVED TREES.
- 7. PRIOR TO COMMENCEMENT OF WORK, THE CONTRACTOR UNDER THE DIRECTION OF A CERTIFIED ASCA ARBORIST, SHALL PERFORM AN INTERNAL DECAY SURVEY AND INSPECTION AND PROVIDE A WRITTEN REPORT OF FINDINGS TO THE OWNER'S REPRESENTATIVE. IF IT IS DEEMED NECESSARY TO REMOVE ANY EXISTING TREES THAT ARE NOTED AS "REMAIN," THE CONTRACTOR SHALL BE RESPONSIBLE FOR APPLYING FOR THE APPROPRIATE TREE REMOVAL LICENSE REQUIRED BY LOCAL CODES, LAWS AND OR REGULATIONS.
- 8. WHERE CONSTRUCTION ACTIVITIES REQUIRE IMPACT TO EXISTING TREE ROOT SYSTEMS, THE CONTRACTOR, UNDER THE GUIDANCE OF AN ASCA ARBORIST, SHALL ROOT PRUNE TREES IN THE IMPACTED AREAS PER ANSI A300 STANDARDS. THE CONTRACTOR, AS WELL AS HIS/HER APPOINTED REGISTERED ASCA ARBORIST, SHALL TAKE ANY AND ALL CUSTOMARY PRECAUTIONS NECESSARY FOR THE SURVIVAL AND CONTINUED VIGOROUS GROWTH OF SAID TREES TO REMAIN.
- 9. ANY REQUIRED ROOT PRUNING SHALL BE COMPLETED PRIOR TO COMMENCEMENT OF ANY CONSTRUCTION ACTIVITIES. UNDER NO CIRCUMSTANCE SHALL THE ROOT SYSTEM BE SUBJECT TO COMPACTION, TEARING, RIPPING OR ANY OTHER DAMAGE EXCEPT CLEAN CUTS AS DESCRIBED IN ANSI A300.
- 10. TREE SHALL BE ROOT PRUNED IN THIRDS AND RELOCATED 6 MONTHS AFTER INITIAL PRUNING ACTIVITY.
- 11. IF MORE THAN 25% OF AN EXISTING TREE ROOT SYSTEM IS IMPACTED FOR ANY REASON (IMPLIED IN THE DRAWINGS OR INCIDENTAL), THE CONTRACTOR SHALL BRACE THE TREE AS DESCRIBED ON THIS SHEET.
- 12. ANY TREE WITH AN IMPACTED ROOT SYSTEM SHALL BE WATERED DAILY AS DESCRIBED ON THIS SHEET.
- 13. ALL ACTIVITY UNDER DRIP LINES AND IN THE PROXIMITY OF PRESERVED TREES SHALL BE ACCOMPLISHED BY NON-MECHANICAL METHODS.
- 14. CONTRACTOR SHALL PROVIDE 3" MULCH UNDER AND AROUND THE BASE OF ALL PRESERVED TREES.

EXISTING/RELOCATED TREE NOTES	5	PRESERVED
2 SCALE: N/A	LT-02	SCALE: N/A



			CONTROL OF
1.		REATED WOOD BRACES AND STAKES FOR TREES UP TO 6" CALIPER.	
3.		RACE MEMBERS AND ASSOCIATED STAKES PER TREE AS FOLLOWS: <u>NUMBER OF PRESSURE TREATED BRACES AND STAKES</u> THREE FOUR FIVE EIGHT	
4.		ACHED TO STAKE AND BATTENS WITH GALVANIZED WOOD SCREWS.	NOT FOR
	RESERVED AND REL	OCATED TREE BRACING NOTES	CONSTRUCTION KIRK OLNEY FL LA LICENSE No.: 00001705 Revision Schedule Rev. # Revision Description Date
			PROJECT NAME:NORTH MIAMI BEACH APARTMENTSPROJECT ADDRESS:NE 164TH ST & 19TH AVE, NORTH MIAMI BEACH, FL 33162PROJECT NO.:02006P & Z AND CITY DOMMISSION REVIEWJ210/2021SHEET NAMETREE PROTECTION PLAN & NOTES
			SHEET NO.

LT-02

		E
	<u>DESCRIPTION OF WORK</u> VIDE LABOR, MATERIALS, EQUIPMENT AND SERVICES TO COMPLETE THE TREE/PALM RELOCATION WORK, AS INDICATED ON DRAWINGS, AS SPECIFIED HEREIN, OR BOTH. INCLUDE THE FOLLOWING:	
	 PREPARATION OF TREES FOR RELOCATION. PRUNE CANOPIES AS NECESSARY OR AS DIRECTED BY AN ISA APPROVED ARBORIST. ROOT PRUNING AND HARDENING OFF. 	
	 RELOCATE TREES AS SHOWN ON THE PLANS AND BACKFILL HOLES WITH PLANTING SOIL. STAKE OR OTHERWISE BRACE RELOCATED TREES AS SHOWN ON THE DRAWINGS. ERECT PROTECTIVE BARRIERS BEFORE AND AFTER RELOCATION. 	
	 PROVIDE CONTINUOUS IRRIGATION. FERTILIZE, SPRAY, PRUNE, AND MAINTAIN IN HEALTHY CONDITION UNTIL FINAL ACCEPTANCE. FILL TREE PITS AT OLD LOCATIONS OF TREES WITH PLANTING SOIL MIXTURE AND SOD THE AREA. 	
1.03 A.	QUALITY ASSURANCE THE SUPERVISORS USED FOR TRANSPLANTING EXISTING SHRUBS, TREES, AND OR PALMS SHALL HAVE A MINIMUM OF FIVE (5) YEARS EXPERIENCE IN THE FIELD OF RELOCATION OF SIMILAR TYPE PLANT MATERIALS AND SHALL BE A MEMBER OF THE AMERICAN ASSOCIATION OF NURSERYMEN.	E
3.	ENGAGE AND OR RETAIN THE SERVICES OF A CERTIFIED MEMBER OF THE AMERICAN SOCIETY OF CONSULTING ARBORISTS (ISA) TO OBSERVE, MONITOR, AND DIRECT ALL TREE RELOCATION PROCEDURES. INTERNATIONAL SOCIETY OF ARBORICULTURE (ISA) MEMBERSHIP/CREDENTIALS' ONLY, IS NOT SUFFICIENT FOR THE REQUIREMENTS OF THIS PROJECT. ISA MEMBER MUST BE PRESENT FOR ALL RELOCATION PROCEDURES. A WEEKLY INSPECTION MUST BE	
	CONDUCTED BY THE ISA MEMBER AFTER RELOCATION IS COMPLETE TO EVALUATE THE GENERAL HEALTH OF TREES. A WRITTEN SUMMARY OF FINDINGS MUST BE PROVIDED TO THE OWNER'S REPRESENTATIVE WEEKLY DURING RELOCATION AND ESTABLISHMENT PERIOD.	
C.	FOR NAMES AND LOCATIONS OF QUALIFIED ISA MEMBERS VISIT <u>WWW.ISA-ARBOR.COM.</u>	
Э.	 PROTECTION OF EXISTING, TREES, SHRUBS, AND PALMS: 1. PROTECT WITH BARRICADES AS DETAILED ON THE DRAWINGS TO PREVENT ENCROACHMENT BENEATH CANOPIES. 	E
	 REPLACE EXISTING TREES OR SHRUBS THAT ARE DAMAGED, SCARRED, OR DESTROYED BY THE CONTRACTOR WITH SAME SPECIES, SIZE AND QUALITY. 	
۹.	SUBMITALS SUBMIT A LIST OF EQUIPMENT, PROCEDURE, AND LABOR FORCE FOR USE IN TRANSPLANTING WORK.	
3. C.	SUBMIT A DAILY RELOCATION SCHEDULE. SUBMIT MANUFACTURER'S LITERATURE ON WETTING AGENTS, FERTILIZERS, AND CONDITIONERS.	
).).	ARBORIST MUST PROVIDE TO THE OWNER'S REPRESENTATIVE WEEKLY REPORTS WHICH SHALL INCLUDE:	[
	 SUMMARY OF SITE ACTIVITIES AND CONDITIONS RELATING TO ALL TREES ONSITE. EVALUATION OF EACH TREE'S CONDITION. RECOMMENDATIONS ON WHAT SHOULD BE DONE TO IMPROVE SURVIVABILITY OF RELOCATED TREES. 	
.05	EXISTING CONDITIONS NO REPRESENTATIONS ARE MADE AS TO SUBSURFACE CONDITIONS.	
3.	CONTRACTOR MUST FIELD VERIFY THE LOCATION OF ALL EXISTING UTILITIES, STRUCTURES AND PLANT MATERIAL.	
A.	 FERTILIZER MIX: 1. A MIXTURE OF UREAFORM AMMONIUM PHOSPHATE AND SOLUBLE POTASH SUSPENDABLE POWDER TO BE DILUTED IN WATER AT A RATE OF 40 POUNDS OF FERTILIZER PER 100 GALLONS OF WATER. 	
3	 USE FORMULA 30410 WITH 50% NITROGEN IMMEDIATELY AVAILABLE FOR RELEASE AND 50% SLOW RELEASE OVER TWELVE MONTHS. PRODUCT: USE ARBORGREEN AS MANUFACTURED BY LESCO, INC. OR AN APPROVED EQUAL. 	
	OVER TWELVE MONTHS. 3. PRODUCT: USE ARBORGREEN AS MANUFACTURED BY LESCO, INC. OR AN APPROVED EQUAL. WETTING AGENT: 1. LESCO WET AS MANUFACTURED BY LESCO, INC. OR AN APPROVED EQUAL. 2. DILUTE AT A RATE RECOMMENDED BY THE MANUFACTURER.	F
	OVER TWELVE MONTHS. 3. PRODUCT: USE ARBORGREEN AS MANUFACTURED BY LESCO, INC. OR AN APPROVED EQUAL. WETTING AGENT: 1. LESCO WET AS MANUFACTURED BY LESCO, INC. OR AN APPROVED EQUAL.	
C.	OVER TWELVE MONTHS. 3. PRODUCT: USE ARBORGREEN AS MANUFACTURED BY LESCO, INC. OR AN APPROVED EQUAL. WETTING AGENT: 1. LESCO WET AS MANUFACTURED BY LESCO, INC. OR AN APPROVED EQUAL. 2. DILUTE AT A RATE RECOMMENDED BY THE MANUFACTURER. MINOR ELEMENT: 1. MICRO MIX LIQUID AS PRODUCED BY LESCO, INC. OR AN APPROVED EQUAL.	F
C. D.	OVER TWELVE MONTHS. 3. PRODUCT: USE ARBORGREEN AS MANUFACTURED BY LESCO, INC. OR AN APPROVED EQUAL. WETTING AGENT: 1. LESCO WET AS MANUFACTURED BY LESCO, INC. OR AN APPROVED EQUAL. 2. DILUTE AT A RATE RECOMMENDED BY THE MANUFACTURER. MINOR ELEMENT: 1. MICRO MIX LIQUID AS PRODUCED BY LESCO, INC. OR AN APPROVED EQUAL. 2. DILUTE IN WATER AT A RATE RECOMMENDED BY THE MANUFACTURER.	
C. D. E.	OVER TWELVE MONTHS. 3. PRODUCT: USE ARBORGREEN AS MANUFACTURED BY LESCO, INC. OR AN APPROVED EQUAL. WETTING AGENT: 1. LESCO WET AS MANUFACTURED BY LESCO, INC. OR AN APPROVED EQUAL. 2. DILUTE AT A RATE RECOMMENDED BY THE MANUFACTURER. MINOR ELEMENT: 1. MICRO MIX LIQUID AS PRODUCED BY LESCO, INC. OR AN APPROVED EQUAL. 2. DILUTE IN WATER AT A RATE RECOMMENDED BY THE MANUFACTURER. TIME RELEASE FERTILIZER TABLETS: AGRIFORM, 15 GRAM, DESIGNATION 20-10-5, OR APPROVED EQUAL. USE THE FOLLOWING MIXTURE FOR DEEP ROOT FERTILIZER FOR TRANSPLANTED SHRUBS, TREES, AND PALMS: 1/3 LIQUID FERTILIZER MIX 1/3 WETTING AGENT MIX 1/3 MINOR ELEMENT MIX USE INJECTION EQUIPMENT THAT AGITATES THE MIXTURE FOR UNIFORMITY OF APPLICATION.	
C. D. Ξ.	OVER TWELVE MONTHS. 3. PRODUCT: USE ARBORGREEN AS MANUFACTURED BY LESCO, INC. OR AN APPROVED EQUAL. WETTING AGENT: 1. LESCO WET AS MANUFACTURED BY LESCO, INC. OR AN APPROVED EQUAL. 2. DILUTE AT A RATE RECOMMENDED BY THE MANUFACTURER. MINOR ELEMENT: 1. MICRO MIX LIQUID AS PRODUCED BY LESCO, INC. OR AN APPROVED EQUAL. 2. DILUTE IN WATER AT A RATE RECOMMENDED BY THE MANUFACTURER. TIME RELEASE FERTILIZER TABLETS: AGRIFORM, 15 GRAM, DESIGNATION 20-10-5, OR APPROVED EQUAL. USE THE FOLLOWING MIXTURE FOR DEEP ROOT FERTILIZER FOR TRANSPLANTED SHRUBS, TREES, AND PALMS: 1/3 LIQUID FERTILIZER MIX 1/3 WETTING AGENT MIX 1/3 WETTING AGENT MIX 1/3 MINOR ELEMENT MIX	
C. D. E.	OVER TWELVE MONTHS. OVER TWELVE THAT AGITATES THE MIXTURE FOR UNIFORMITY OF APPLICATION. SOIL BACKFILL/PLANTING SOIL MIX OVER TWELVE FOR DELEMENT THAT AGITATES THE MIXTURE FOR UNIFORMITY OF APPLICATION. SOIL BACKFILLPLANTING SOIL MIX OVER THAT A GITATES THE MIXTURE FOR UNIFORMITY OF APPLICATION. SOIL BACKFILLPLANTING SHALL BE FREE FROM STICKS, ROOTS, STONES, OR OTHER EXTRANEOUS MATERIAL DETRIMENTAL OR INJURIOUS TO PLANTS. PARTICULAR CARE SHOULD BE TAKEN TO REMOVE PIECES OF MORTAR, CEMENT, WOOD, AND OTHER SIMILAR REMAINS OF CONSTRUCTION FROM ALL PLANTING AREAS. OVER TWE OVER TWO OVER THAT AGITALE BE SOW. EXISTING/SURROUNDING SOIL AND 50% IMPORTED (CONSISTING)	
C. D. E. 2.02 A. B. C. D. E. F.	OVER TWELVE MONTHS. PRODUCT: USE ARBORGREEN AS MANUFACTURED BY LESCO, INC. OR AN APPROVED EQUAL. WETTING AGENT: LESCO WET AS MANUFACTURED BY LESCO, INC. OR AN APPROVED EQUAL. LISSCO WET AS MANUFACTURED BY LESCO, INC. OR AN APPROVED EQUAL. LISSCO WET AS MANUFACTURED BY LESCO, INC. OR AN APPROVED EQUAL. LISSCO WET AS MANUFACTURED BY LESCO, INC. OR AN APPROVED EQUAL. LISSCO WET AS MANUFACTURED BY LESCO, INC. OR AN APPROVED EQUAL. LISSCO WET AS MANUFACTURE AT A RATE RECOMMENDED BY THE MANUFACTURER. MINOR ELEMENT: I. MICRO MIX LIQUID AS PRODUCED BY LESCO, INC. OR AN APPROVED EQUAL. LISE THE FOLLOWING MIXTURE FOR DEEP ROOT FERTILIZER FOR TRANSPLANTED SHRUBS, TREES, AND PALMS: 1/13 MINOR GUIDTER THIZER MIX 1/3 WETTING AGENT MIX 1/3 MINOR GUIDTER THIZER MIX 1/3 WETTING AGENT MIX 1/3 MINOR ELEMENT MIX USE INJECTION EQUIPMENT THAT AGITATES THE MIXTURE FOR UNIFORMITY OF APPLICATION. SOL BACKFILLPLANTING SOIL MIX I. SOLL USED FOR PLANTING SHALL BE FREE FROM STICKS, ROOTS, STONES, OR OTHER EXTRANEOUS MATERIAL DETRIMENTAL OR INJURIOUS TO PLANTS. PARTICULAR CARE SHOULD BE TAKEN TO REMOVE PIECES OF MORTAR, CEMENT, WOOD, AND OTHER SIMILAR REMAINS OF CONSTRUCTION FROM ALL PLANTING AREAS. SOLL USED FOR PLANTING MIX SHALL BE FREE FROM STICKS, ROOTS, STONES, OR OTHER EXTRANEOUS MATERIAL DETRIMENTAL OR INJURIOUS TO PLANTS. PARTICULAR CARE SHOULD BE TAKEN TO REMOVE PIECES OF MORTAR, CEMENT, WOOD, AND OTHER SIMILAR REMAINS OF CONSTRUCTION FROM ALL PLANTING AREAS. SOLL USED FOR PLANTING MIX SHALL BE FREE FROM STICKS, ROOTS, STONES, OOL AND 50% IMPORTED (CONSISTING OF 13 APPROVED SOLI BACKFILL, 13 FLORIDA PEAT, AND 13 CLEAN D O.T. SAND). A "ACCEPTABLE SOLI BACKFILL, 13 FLORIDA PEAT, AND 13 CLEAN D O.T. SAND). A "ACCEPTABLE SOLI BACKFILL, 13 FLORIDA PEAT, AND 13 CLEAN D O.T. SAND). A "ACCEPTABLE SOLI BACKFILL, 15 FLORIDA PEAT, AND 13 CLEAN D O.T. SAND). A "ACCEPTABLE SOLI BACKFILL, 15 FLORIDA PEAT, AND 13 CLEAN D O.T. SAND). A "ACCEPTABLE SOLI BACKFILL, 15 FLORIDA PEAT, AND 13 CLEAN D O.T. SAND). A "ACCEPTABLE SOLI BACKFILL INFONCENTING	
Α.	OVER TWELVE MONTHS. PRODUCT: USE ARBORGREEN AS MANUFACTURED BY LESCO, INC. OR AN APPROVED EQUAL. WETTING AGENT: LESCO WET AS MANUFACTURED BY LESCO, INC. OR AN APPROVED EQUAL. LESCO WET AS MANUFACTURED BY LESCO, INC. OR AN APPROVED EQUAL. DULTTE AT A RATE RECOMMENDED BY THE MANUFACTURER. MINOR RELEMENT: LMCRO MIX LIQUID AS PRODUCED BY LESCO, INC. OR AN APPROVED EQUAL. DULTTE IN WATER AT A RATE RECOMMENDED BY THE MANUFACTURER. MINOR RELEMENT: LMCRO MIX LIQUID AS PRODUCED BY LESCO, INC. OR AN APPROVED EQUAL. DULTTE IN WATER AT A RATE RECOMMENDED BY THE MANUFACTURER. MINOR MIX LIQUID FRONT SUBJECTION FOR THE PRODUCED BY LESCO, INC. OR AN APPROVED EQUAL. DULTTE IN WATER AT A RATE RECOMMENDED BY THE MANUFACTURER. MINOR MIXTURE FOR DEEP ROOT FERTILIZER FOR TRANSPLANTED SHRUBS, TREES, AND PALMS: 1/3 LIQUID FERTILIZER MIX 1/3 WITING AGENT MIX 1/3 WITING RELEMENT MIX USE INJECTION EQUIPMENT THAT AGITATES THE MIXTURE FOR UNIFORMITY OF APPLICATION. SOLE BACKFILL/PLANTING SOLE MIX PLANTING SOLE MIX PLANTING SOLE MIX PLANTING SOLE MIX PLANTING SOLE MIX SOL USED FOR PLANTING SHALL BE FREE FROM STICKS, ROOTS, STONES, OR OTHER EXTRANEOUS MATERIAL DETRIMENTAL OR INJURIOUS TO PLANTS. PARTICULAR CARE SHOULD BE TAKEN TO REMOVE PIECES OF MORTAR, CEMENT, WOOD, AND OTHER SIMILAR REMAINS OF CONSTUCTION FROM ALL PLANTING AREAS. SOLI USED FOR PLANTING MIX SHALL BE FREE FROM STICKS, ROOTS, STONES, OR OTHER EXTRANEOUS MATERIAL DETRIMENTAL OR INJURIOUS TO PLANTING SHALL BE SOLE OR ON THE PROJECTS OF MORTAR, CEMENT, WOOD, AND OTHER SITTING'S OF CONSTUCTION FROM ALL PLANTING AREAS. SOLI USED FOR PLANTING MIX SHALL BE SOS'E SXISTING'SURROUNDING SOL AND SOS'MPORTED (CONSISTING OF 13 APPROVED SOLE BOCKFILL. 13D FLORIDA PEAT. AND 13 CLEAN DO SOS'MORORTED (CONSISTING OF TIA APPROVED SOLE SOLESSISING CHARACTERRISTICS REPRESENTATIVE OF A WELL-DRAINED AREA IN FLORIDA. SOIL CONTAINING MUCK OR POORLY DRAINED SOLS SHALL NOT BE USED. A. FRIGAE SOLE BORCFILL AND THE MARTING SURADOWN MEDIANED AREA IN FLORIDA. SOIL CONTAINING MUCK OR CONSTRUCTION DEBRIS) SH	

WATER FREE OF SUBSTANCES HARMFUL TO PLANT GROWTH, OBJECTIONABLE ODOR OR STAINING AGENTS.

THE WATER USED FOR ESTABLISHMENT OF PLANT MATERIAL SHALL BE CLEAN AND FREE OF DIRT, DEBRIS, POISONS, PESTICIDES, CONTAMINANTS AND ANY OTHER MATERIAL OR COMPOUND THAT IS DETRIMENTAL OR INHIBITS VIGOROUS PLANT GROWTH

PROVIDED BY THE CONTRACTOR AND OBTAINED FROM ITS SOURCE LEGALLY. WATER DRAWN FROM CANALS AND OR LAKES AND ACCESS THEREOF WILL BE DONE ONLY WITH THE EXPRESS WRITTEN APPROVAL OF THE OWNER OF SAID PROPERTY AND OR APPLICABLE FEDERAL, STATE AND LOCAL LAWS, REGULATIONS, STANDARDS OR OTHER REGULATORY REQUIREMENTS.

CONTRACTOR SHALL ROUTINELY AND REGULARLY PROVIDE SUFFICIENT SUPPLEMENTAL WATER TO RELOCATED AND EXISTING TREES IMPACTED BY CONSTRUCTION ACTIVITIES, AS WELL AS RELOCATED TREES, TO PROVIDE FOR VIGOROUS PLANT HEALTH AND GROWTH.

RT 3 - EXECUTION **GENERAL PREPARATION**

CONTRACTOR TO VERIFY THAT TREES IN THE FIELD MATCH TREES DESIGNATED ON THE DRAWINGS. OBTAIN CONCURRENCE OF THE OWNER'S REPRESENTATIVE PRIOR TO CROWN PRUNING.

REMOVE TREES, SAPLINGS, SHRUBS, BUSHES, VINES AND UNDERGROWTH THAT INTERFERE WITH RELOCATION. HAND-CLEARING ONLY IS PERMITTED WITHIN THE DRIP-LINE OF TREES TO BE RELOCATED.

CLEAR THE ROOT BALL AREA BY HAND ONLY OF FOREIGN MATERIAL AND TRASH TO EXPOSE UNDISTURBED SOIL.

VERIFY PERCOLATION RATES AND SOIL'S ACCEPTABILITY AT LOCATIONS TO WHICH THE TREES ARE TO BE TRANSPLANTED.

ALL TREES SHALL BE PRE-TIED IN OR TIED BACK TO PREVENT BREAKAGE AND SCRAPING OF LIMBS IN ORDER TO FACILITATE MACHINERY MOVEMENT

PREPARATION PRIOR TO RELOCATION

IN THE PRESENCE AND DIRECTION OF ISA MEMBER, PERFORM CROWN PRUNING BETWEEN 30 AND 60 DAYS PRIOR TO TRANSPLANTING.

ALL TREES SHALL BE PRE-PRUNED USING CLASS 4 SPECIFICATIONS

FERTILIZATION AND WATERING:

- 1. INJECT THE FERTILIZER MIXTURE INTO THE SOIL WITHIN 24 HOURS AFTER CROWN PRUNING, AND AT A MINIMUM OF 14 DAYS PRIOR TO RELOCATION.
- 2. INJECT THE DEEP ROOT FERTILIZER MIXTURE AT A RATE RECOMMENDED BY THE MANUFACTURER INTO THE ROOT ZONES OF SHRUBS, TREES, AND PALMS TO BE RELOCATED. 3. ALL TREES SHOULD BE WATERED IN THE FIELD PRIOR TO TRANSPLANTING USING A MINIMUM OF 50
- GALLONS PER TREE.
- 4. WATER IS TO BE PROVIDED BY THE CONTRACTOR AND OBTAINED LEGALLY.

CROWN PRUNING:

- 1. TRIM TREES TO BE RELOCATED BY THINNING THE CROWN ONLY, AND NOT BY REDUCING CROWN DIMENSIONS. TRIM TO CONFORM TO ANSI A300 AND IFAS CIR853 STANDARDS, INCLUDING REMOVAL OF DEAD WOOD. REPAIR INJURIES TO TREES INCLUDING CAVITIES AND MACHINERY MARKS.
- 2. REMOVE SEEDPODS FROM SABAL PALMS, AND ALL BUT TEN OF THE YOUNGEST FRONDS. TRIM BOOTS TO A CLEAN, REGULAR PATTERN.
- 3. REMOVE TRIMMINGS OFF-SITE AND DISPOSE OF IN ACCORDANCE WITH THE CITY CODE. 4. UNDER NO CIRCUMSTANCE SHALL MORE THAN 30% OF THE CANOPY BE REMOVED.

ROOT PRUNING

- 1. PERFORM ROUGH PRUNING AT NO LESS THAN HALF THE DISTANCE BETWEEN THE DRIP LINE AND THE TRUNK.
- 2. PROVIDE TEN INCHES (10") OF ROOT BALL DIAMETER FOR EVERY 1" OF TRUNK CALIPER (MEASURED AT 12"
- ABOVE EXISTING GRADE). 3. MINIMUM BALL DEPTH FOR BROADLEAF TREES: BALL DIAMETER MINIMUM DEPTH 36" - 48" 60% OF
- DIAMETER 48" AND UP 35" MINIMUM
- 4. LEAVE ROOTS WITH A SMOOTH, CLEAN CUT WITHOUT TEARS OR SPLITS. 5. TREES TO BE RELOCATED WITH A CALIPER IN EXCESS OF TWELVE INCHES (12") SHALL BE ROOT PRUNED BY HAND.
- 6. PRIOR TO TRANSPLANTING. PRUNE ROOT SYSTEM IN THIRDS. 8 WEEKS APART.
- 7. BACKFILL TRENCH WITH SUGAR SAND.

IRRIGATION AND WATER

1. PROVIDE A MINIMUM OF THREE TIMES PER WEEK HAND WATERING OF EACH TRANSPLANTED TREE. RATE OF WATER APPLICATION SHALL BE: A MINIMUM OF 20 GALLONS OF WATER PER INCH OF CALIPER PER APPLICATION.

PROTECTION:

1. ERECT TREE PROTECTION MEASURES AS SHOWN ON THE DRAWINGS TO PROTECT INDIVIDUAL OR GROUPS OF TREES TO BE TRANSPLANTED.

RELOCATION

- GENERAL
 - VERIFY THE PRESENCE OF VIGOROUS FEEDER ROOTS PRIOR TO RELOCATION OPERATIONS. 2. INJECT DEEP-ROOT FERTILIZER MIXTURE INTO THE SOIL14 DAYS PRIOR TO TRANSPLANTING. APPLY AT A
 - RATE RECOMMENDED BY THE MANUFACTURER INTO ROOT ZONES OF TREES AND PALMS. 3. SOAK TREE BALLS TO THE FULL DEPTH DAILY FOR SEVEN CONSECUTIVE DAYS PRIOR TO RELOCATING.
 - 4. LOCATE POSITION AND ELEVATION WHERE TREES ARE INTENDED TO BE PLANTED FOR VERIFICATION BY
 - OWNER'S REPRESENTATIVE.
 - 5. SELECT A MOVING ROUTE WHERE OVERHEAD AND UNDERGROUND UTILITIES, EXISTING OR PROPOSED, DO NOT CONFLICT WITH THE TRANSPLANTING PROCESS. COORDINATE THE ROUTE AND MOVING SCHEDULE WITH THE OWNER'S REPRESENTATIVE AND OTHER TRADES.
 - 6. NOTIFY THE OWNER'S REPRESENTATIVE 24 HOURS IN ADVANCE OF EACH RELOCATION TO ALLOW FOR OBSERVATION OF PROCEDURES.

EQUIPMENT

- 1. A 65" TRANSPLANTING MACHINE WILL BE SUFFICIENT FOR TREES UP TO 4" CALIPER BUT NO LARGER.
- 2. A BIG JOHN MODEL 90 MACHINE WILL BE SUFFICIENT FOR TREES UP TO 8" IN CALIPER 3. A 102" MACHINE WILL BE SUFFICIENT FOR TREES 9" - 12" IN CALIPER
- 4. HAND DIGGING (BALL AND BURLAP) IS ACCEPTABLE AND MAY BE USED AT THE DISCRETION OF THE ISA MEMBER.
- 5. ALL CALIPERS ARE MEASURED AT 1 FT. ABOVE EXISTING GRADE.
- 6. ALL TRANSPLANTING MACHINES WILL HAVE CLEAN, TIGHT-FITTING SHARP BLADES.
- 7. ANY MACHINE DEEMED "LOOSE" BY THE ISA MEMBERS WILL BE REJECTED AS UNSATISFACTORY. 8. TREES TO BE RELOCATED WITH A CALIPER IN EXCESS OF TWELVE INCHES (12") SHALL BE RELOCATED VIA TREE BOX OR OTHER APPROVED METHOD.

DIGGING AND MOVING

- 1. DIG PITS A MINIMUM OF 42" DEEP WITH VERTICAL SIDES AND NET BOTTOM.
- 2. HANDLE TREES TO AVOID DAMAGE TO BARK AND LIMBS. ATTACH SUPPORT STRAPS, CABLES, OR CHAINS AT MULTIPLE POINTS FOR WEIGHT DISTRIBUTION.
- 3. DO NOT FORCE TREE FROM GROUND PRIOR TO UNDERCUTTING ROOT BALLS. DETERMINE FINAL BALL DEPTH UPON ASSESSING CONDITIONS AT TIME OF TRENCHING. NOTIFY OWNER'S REPRESENTATIVE IF BALL DEPTH VARIES FROM SPECIFIED DEPTH.
- 4. SABAL PALMS MAY BE RELOCATED BY MEANS OF TREE SPADE AT THE DISCRETION OF THE CONTRACTOR. OTHERWISE, LIFT SIMILARLY TO CANOPY TREES.
- 5. TREES ARE TO BE PLACED IN HEAVY GRADE BASKETS LINED WITH TWO LAYERS OF BURLAP FOR RELOCATION PROCEDURES OR PRIOR TO PLACEMENT IN HOLDING AREA (IF APPLICABLE).
- 6. PLANT TOP OF ROOT BALLS THREE-INCHES (3") ABOVE FINISH GRADE.
- 7. ALL TREES TRANSPLANTED IN ANY GIVEN DAY WILL BE WATERED IN. SANDED, MULCHED, AND UNTIED THAT SAME DAY.

	 ALL TREES SHAL INSURE CLEARIN IMMEDIATELY BA SOIL HEIGHT TO ROOT BALL. PROVIDE HOLE IN
E.	TREE SUPPORTS 1. SUPPORT TREE V 2. BUTTRESSES MA
<u>3.04</u> A.	IRRIGATION THE CONTRACTOR IS RESI
В.	DAILY WATERING AND MON UNTIL FINAL ACCEPTANCE
C.	THE CONTRACTOR IS RESI
D.	A TENSIOMETER SHALL BE OBSERVATION SHALL BE R
3.05	PLANTING
	 A. PLANTING AND BAG 1. DIG PITS TO REC BALL, AND AT LEG 2. ALL PLANTING SC APPROVED EQUA RECOMMENDED 3. PLACE TREE IN P TREES AND VIEW 4. ALL PLANT PITS A DIAMETER. 5. INSTALL TREE SC 6. FLOOD BOTTOM SC 7. CONTINUE TO FL MECHANICAL CO
	 B. SOIL ADDITIVES 1. AGRODIAMONDS ALL RELOCATED RATES. 2. AGRODIAMONDS
<u>3.06</u> A.	POST-RELOCATION GROUT THE CONTRACTOR SHALL ACCEPTANCE.
В.	THE CONTRACTOR SHALL VIGOROUS, AND UNDAMAC
<u>3.07</u> A.	ACCEPTANCE FOR THE PURPOSE OF EST EVIDENCE OF ESTABLISHIN 1. PERFORM OPERA HEALTHY, VIGOR 2. PERFORM ALL MA
В.	WHEN THE CONTRACTOR I COMPLETION INSPECTION A PUNCH LIST OF ITEMS TO HAVE BEEN COMPLETED A
C.	AT THE CONCLUSION OF T WARRANTED PLANT MATE 1. REMOVE ALL MAT 2. AT NO ADDITION ACCORDANCE W 3. WARRANTY PERI 4. THE CONTRACTO DATE OF INSTALL
3.08	
A. B.	THE MINIMUM ALLOWABLE RELOCATED PLANT MATER SURVIVABILITY SHALL BE M RELOCATED PLANT MATER ONE (1) YEAR FROM THE D

D. TREES IN HOLDING AREA (IF APPLICABLE) 1. LOCATE ROOT BALLS AS CLOSE TOGETHER WITHOUT DAMAGING THE CROWN OF THE TREE 2. ALL TREES SHALL BE SET IN HOLES 3"-6" ABOVE EXISTING GRADE IN THE TREE HOLDING AREA. NG AND GRUBBING IS COMPLETE IN HOLDING AREA ACKFILL VOIDS BETWEEN ROOT BALLS AND WATER IN TO REMOVE AIR POCKETS.

BE AT THE TOP OF THE ROOT BALL. NO ADDITIONAL FILL OR SOIL SHALL BE PLACED ON IN HOLDING AREA THAT IS THE SAME SIZE AS THE TREE ROOT BALL.

WITH MACHINERY UNTIL BRACING IS COMPLETE. IAY SUPPORT SEPARATE TRUNKS ON MULTIPLE TRUNK TREES

SPONSIBLE FOR HAND WATERING ALL RELOCATED PLANT MATERIAL

INITORING SHALL BE PERFORMED DURING THE TERM OF THE CONSTRUCTION CONTRACT AND

SPONSIBLE FOR PROVIDING WATER AT HIS/HER OWN EXPENSE.

E UTILIZED TO MEASURE AND MONITOR AVAILABLE MOISTURE IN THE GROUND. WEEKLY REPORTED IN ISA MEMBER'S REPORT.

ACKFILLING:

CEIVE TRANSPLANTS WITH VERTICAL SIDES, FLAT BOTTOMS, SAME DEPTH AS THE TREE ROOT EAST THREE TIMES LARGER THAN THE SIZE OF THE ROOT BALL SOIL/SOIL BACKFILL TO BE USED IN PLANTING PITS SHALL BE AMENDED WITH AGRODIAMONDS, JAL, NA (SODIUM) BASE SOIL POLYMER OR APPROVED EQUAL AT THE MANUFACTURERS

D APPLICATION METHODS AND RATES. PIT AND ROTATE PRIOR TO SETTING TO ACHIEVE BEST POSITIONING RELATIVE TO ADJACENT

WING ANGLES. AND BACK FILL MATERIAL MUST BE FREE OF ALL DEBRIS AND ROCKS IN EXCESS IF 1/2" IN

SO TOP OF ROOT BALL IS THREE-INCHES (3") WITH PROPOSED GRADE.

I SOIL LAYER TO SETTLE TREE INTO BEST POSITION AND TO REMOVE AIR POCKETS. LOOD ROOT BALL AS PLANTING SOIL MIX IS DEPOSITED TO REMOVE AIR POCKETS.

OMPACTION OF SOIL BACKFILL IS STRICTLY PROHIBITED.

" HIGH BERM AROUND THE OUTSIDE OF THE TREE PIT AFTER BACKFILLING TO RETAIN WATER.

NA (SODIUM) OR APPROVED EQUAL BASE SOIL POLYMER SUPER ABSORBENT TO BE USED IN PLANT MATERIAL AT THE MANUFACTURERS RECOMMENDED APPLICATION METHODS AND

WITH A PARTICLE SIZE RANGE OF .5MM TO 2.8MM.

W-IN PERIOD

. MAINTAIN ALL TRANSPLANTED MATERIAL IN A HEALTHY CONDITION UNTIL FINAL

PREPARE ALL OPERATIONS NECESSARY TO ENSURE THAT PLANTS ARE HEALTHY, GED.

STABLISHING AN "ACCEPTANCE" STANDARD, PLANTS SHALL BE HEALTHY AND EXHIBIT ING NEW ROOTS.

RATIONS AS NECESSARY TO COMPLETE MAINTENANCE AND ENSURE THAT PLANTS ARE ROUS, VISUALLY PLEASING, AND UNDAMAGED. AINTENANCE TASKS AS SPECIFIED HERE IN.

HAS MET THE OBLIGATIONS OF THE POST-TRANSPLANTING SCHEDULE, A SUBSTANTIAL I SHALL BE CONDUCTED WITH ALL DEFICIENCIES NOTED AND GIVEN TO THE CONTRACTOR AS TO BE CORRECTED. FINAL ACCEPTANCE WILL NOT BE ISSUED UNTIL ALL PUNCH LIST ITEMS AND A RE-INSPECTION BY THE OWNER'S REPRESENTATIVE IS COMPLETED.

THE WARRANTY PERIOD, AN INSPECTION SHALL BE MADE TO DETERMINE THE CONDITION OF -RIAI

ATERIAL NOTED AS NOT BEING IN A HEALTHY-GROWING CONDITION. NAL COST, REPLACE REJECTED MATERIAL WITH MATERIAL OF LIKE KIND AND SIZE, IN WITH THE SPECIFICATIONS.

RIOD APPLIES ALSO TO REPLACED MATERIAL.

OR SHALL WARRANT ALL REPLACEMENT TREES FOR A PERIOD OF ONE (1) YEAR FROM THE LATION.

RATE OF SURVIVAL OF ALL TRANSPLANTED MATERIAL SHALL BE 100%. DEATH OF ANY RIAL SHALL BE REPLACED WITH THE SAME SIZE AND SPECIES. DETERMINATION OF MADE AT THE END OF THE WARRANTY PERIOD.

RIAL INSTALLED BY THE CONTRACTOR SHALL BE WARRANTED IN WRITING FOR A PERIOD OF DATE OF FINAL ACCEPTANCE.



ARCHITECTURE - INTERIOR DESIGN - CIVIL ENGINEERING -LANDSCAPE ARCHITECTURE :

Bermello Ajamil & Partners, Inc. Architecture Engineering Planning Interior Design Landscape Architecture 2601 South Bayshore Drive, 10th Floor Miami, Florida 33133 T: (305) 859-2050 F: (305) 860-3700

CLIENT:



NOT FOR CONSTRUCTION

KIRK OLNEY FL LA LICENSE No.: 00001705

Revision Schedule Rev. # Revision Description Date

PROJECT NAME: NORTH MIAMI BEACH APARTMENTS **PROJECT ADDRESS:** NE 164TH ST & 19TH AVE. NORTH MIAMI BEACH, FL 33162 **PROJECT NO.:** 02006


P & Z AND CITY COMMISSION REVIEW

12/10/2021


SHEET NAME TREE / PALM **PROTECTION AND** RELOCATION **SPECIFICATIONS**

SHEET NO.


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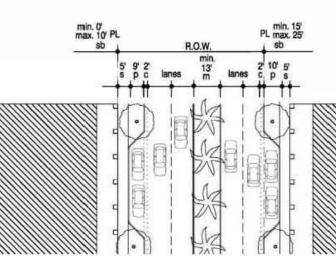


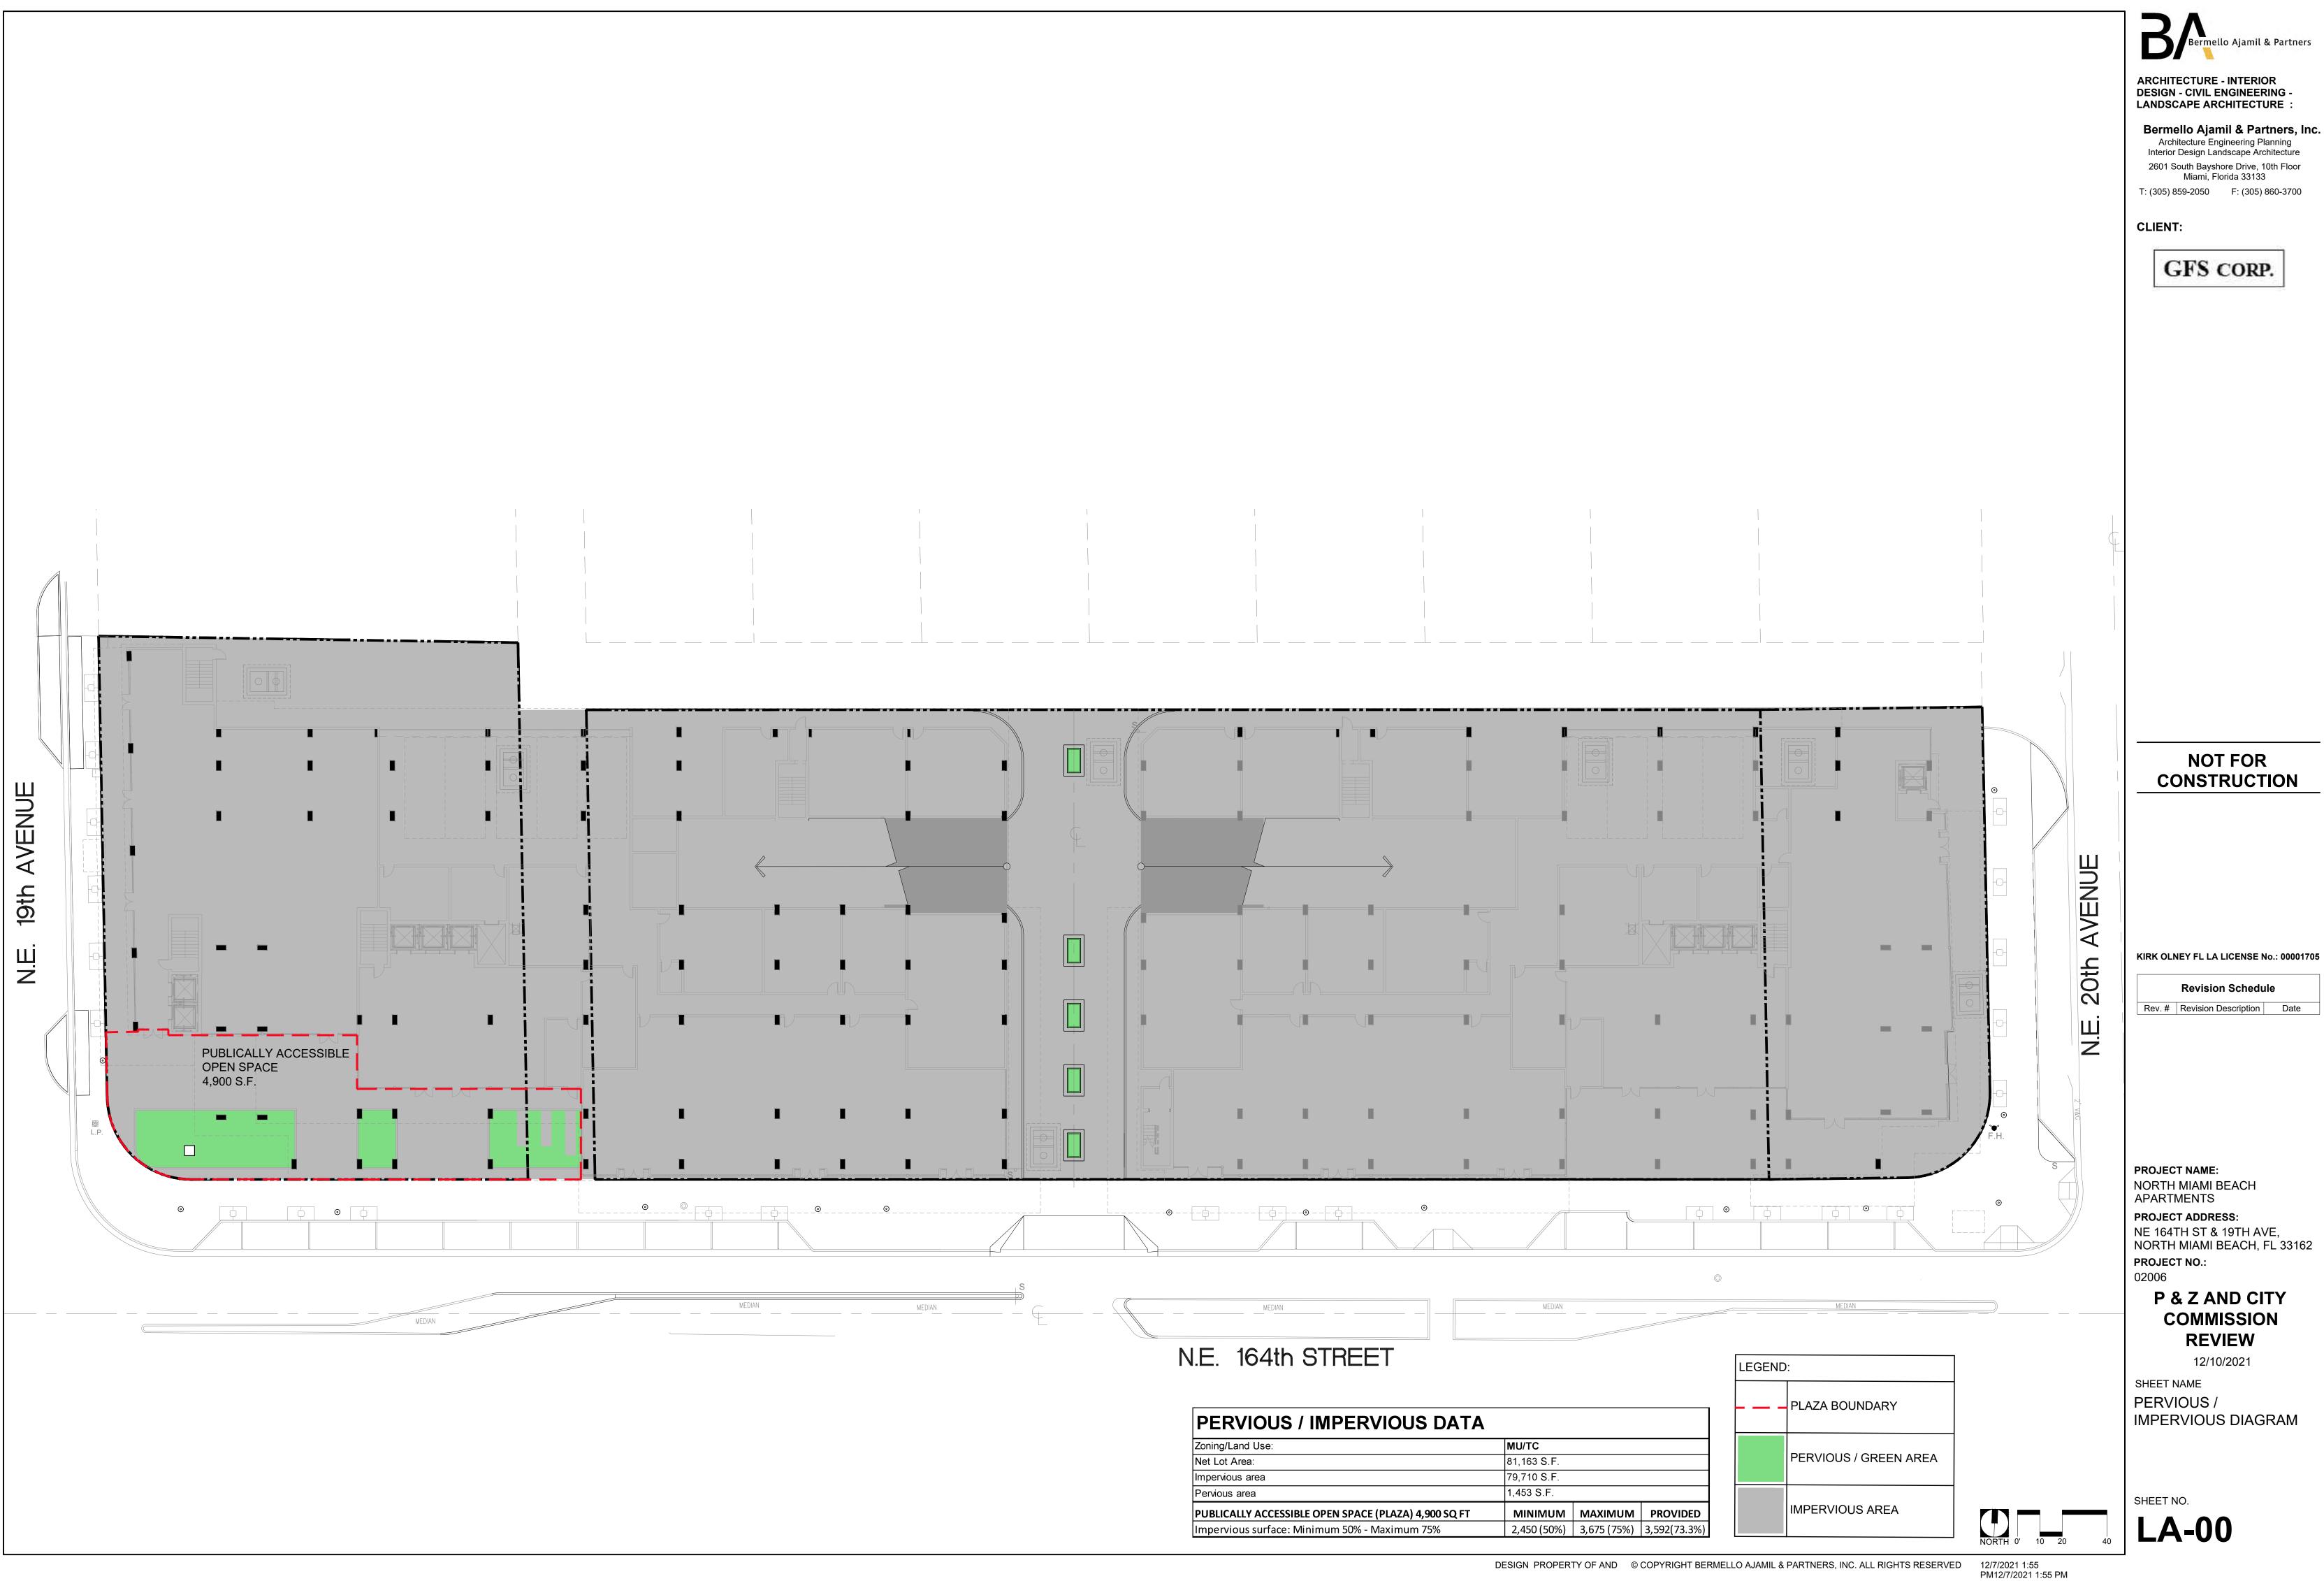MU/TC	
81,163 S.F.	
79,710 S.F.	
1,453 S.F.	
MINIMUM	MA
2,450 (50%)	3,6
•	81,163 S.F. 79,710 S.F. 1,453 S.F. MINIMUM

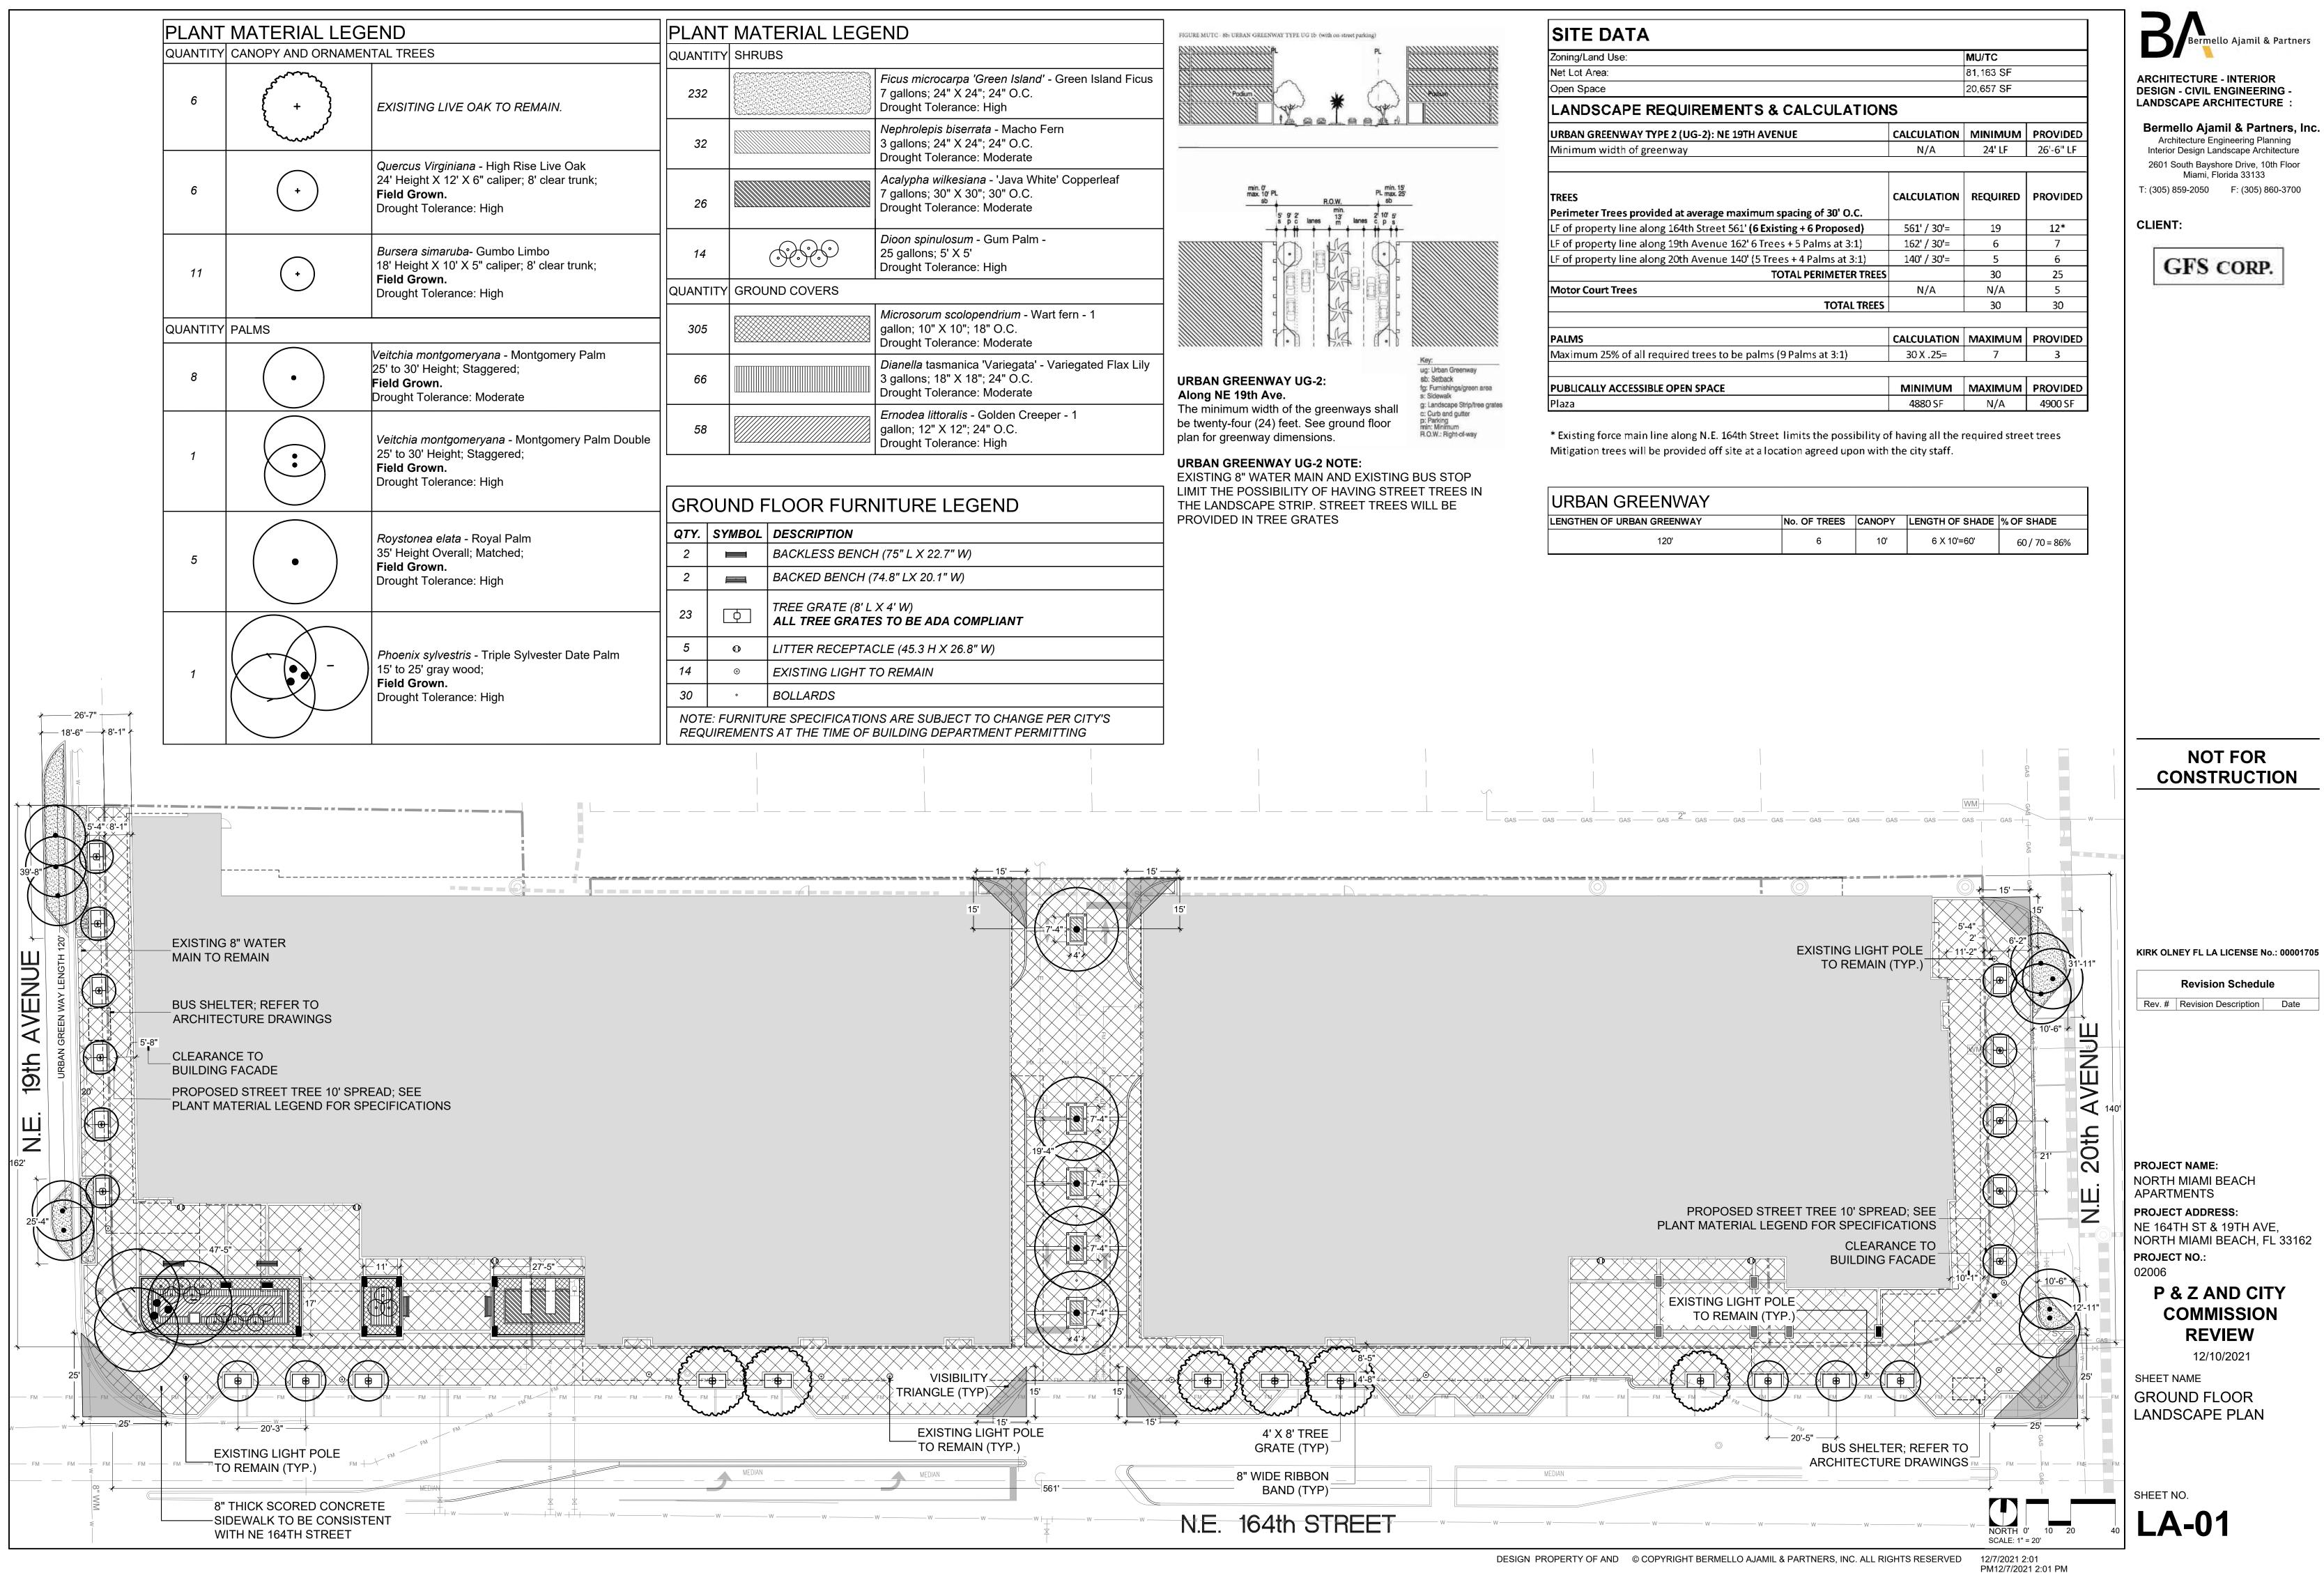

ATERIAL LEGEND			
IRUBS			
	<i>Ficus microcarpa 'Green Island'</i> - Green Island Ficus 7 gallons; 24" X 24"; 24" O.C. Drought Tolerance: High		
	<i>Nephrolepis biserrata</i> - Macho Fern 3 gallons; 24" X 24"; 24" O.C. Drought Tolerance: Moderate		
	<i>Acalypha wilkesiana</i> - 'Java White' Copperleaf 7 gallons; 30" X 30"; 30" O.C. Drought Tolerance: Moderate		
<u></u>	<i>Dioon spinulosum</i> - Gum Palm - 25 gallons; 5' X 5' Drought Tolerance: High		
ROUND COVERS			
	<i>Microsorum scolopendrium</i> - Wart fern - 1 gallon; 10" X 10"; 18" O.C. Drought Tolerance: Moderate		
	<i>Dianella</i> tasmanica 'Variegata' - Variegated Flax Lily 3 gallons; 18" X 18"; 24" O.C. Drought Tolerance: Moderate		
	<i>Ernodea littoralis</i> - Golden Creeper - 1 gallon; 12" X 12"; 24" O.C. Drought Tolerance: High		




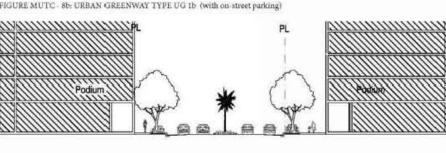



ng/Land Use:		MU/TC	
Lot Area:		81,163 SF	
n Space		20,657 SF	
NDSCAPE REQUIREMENTS & CALCULATION	S		
AN GREENWAY TYPE 2 (UG-2): NE 19TH AVENUE	CALCULATION	MINIMUM	PROVIDED
imum width of greenway	N/A	24' LF	26'-6" LF
ES	CALCULATION	REQUIRED	PROVIDED
meter Trees provided at average maximum spacing of 30' O.C.			
f property line along 164th Street 561' (6 Existing + 6 Proposed)	561' / 30'=	19	12*
f property line along 19th Avenue 162' 6 Trees + 5 Palms at 3:1)	162' / 30'=	6	7
f property line along 20th Avenue 140' (5 Trees + 4 Palms at 3:1)	140' / 30'=	5	6
TOTAL PERIMETER TREES		30	25
or Court Trees	N/A	N/A	5
TOTAL TREES		30	30
MS	CALCULATION	MAXIMUM	PROVIDED
imum 25% of all required trees to be palms (9 Palms at 3:1)	30 X .25=	7	3
	1	1	
LICALLY ACCESSIBLE OPEN SPACE	MINIMUM	MAXIMUM	PROVIDED
а	4880 SF	N/A	4900 SF

AN GREENWAY				
EN OF URBAN GREENWAY	No. OF TREES	CANOPY	LENGTH OF SHADE	% OF SHADE
120'	6	10'	6 X 10'=60'	60 / 70 = 86%

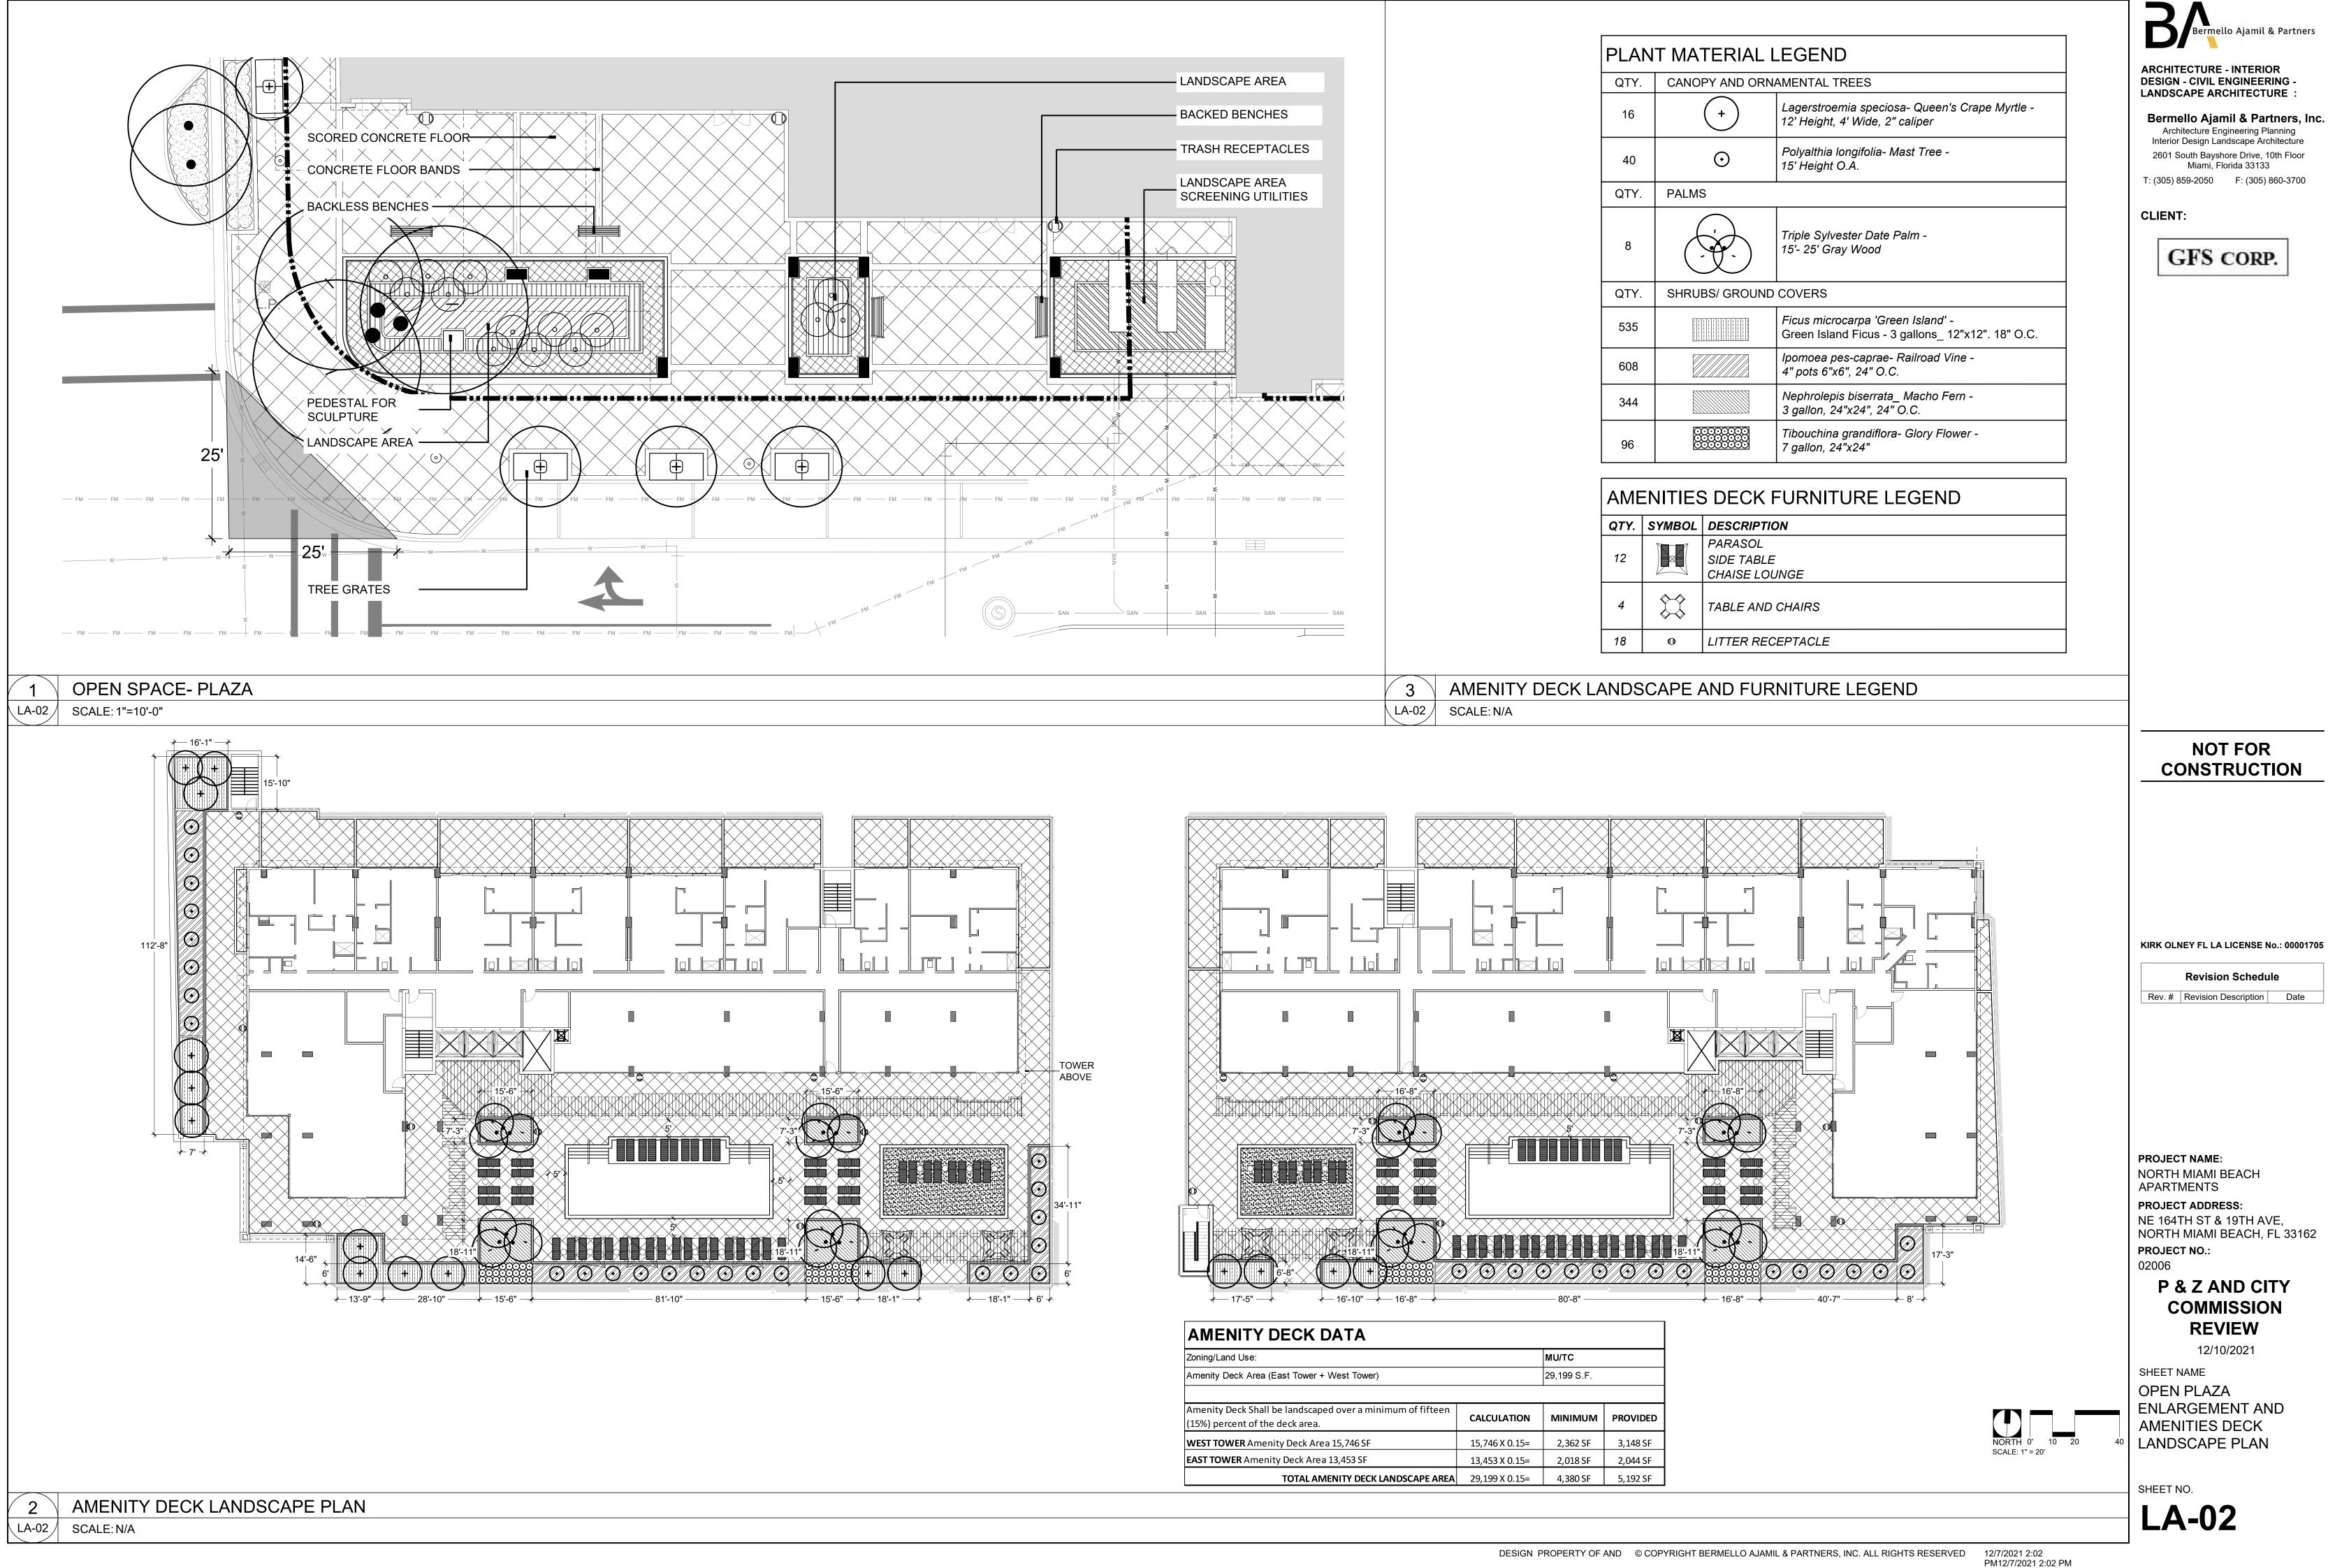




PLANT MATERIAL LEGEND				
QTY.	CANOPY AND ORNAMENTAL TREES			
16	+ Lagerstroemia speciosa- Queen's Crape Myrtle - 12' Height, 4' Wide, 2" caliper			
40	\odot	Polyalthia longifolia- Mast Tree - 15' Height O.A.		
QTY.	PALMS			
8		Triple Sylvester Date Palm - 15'- 25' Gray Wood		
QTY.	SHRUBS/ GROUND COVERS			
535		<i>Ficus microcarpa 'Green Island' -</i> Green Island Ficus - 3 gallons_ 12"x12". 18" O.C.		
608		Ipomoea pes-caprae- Railroad Vine - 4" pots 6"x6", 24" O.C.		
344		Nephrolepis biserrata_ Macho Fern - 3 gallon, 24"x24", 24" O.C.		
96		Tibouchina grandiflora- Glory Flower - 7 gallon, 24"x24"		

	AMENITIES DECK FURNITURE LEGEND		
QT	Y. SYMBOL	DESCRIPTION	
		PARASOL	
12		SIDE TABLE	
		CHAISE LOUNGE	
4		TABLE AND CHAIRS	
18	O	LITTER RECEPTACLE	





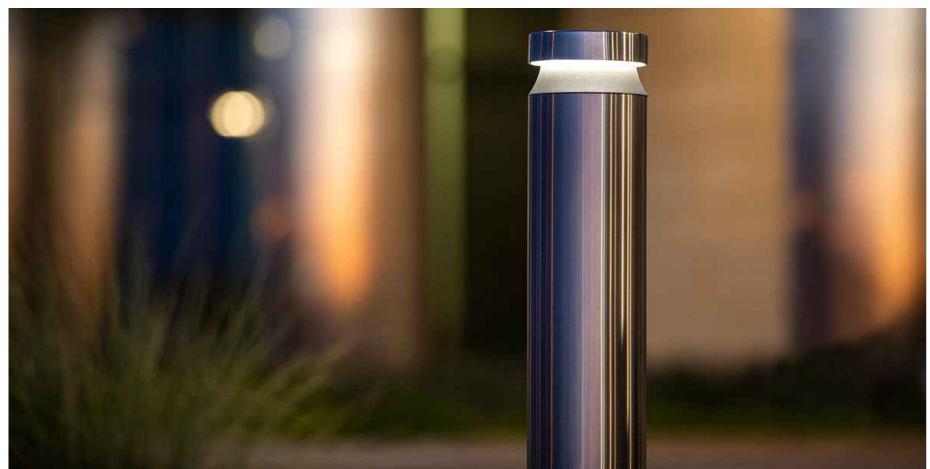

LA-03 /








AMENITY DECK FURNITURE IMAGES SCALE: N/A





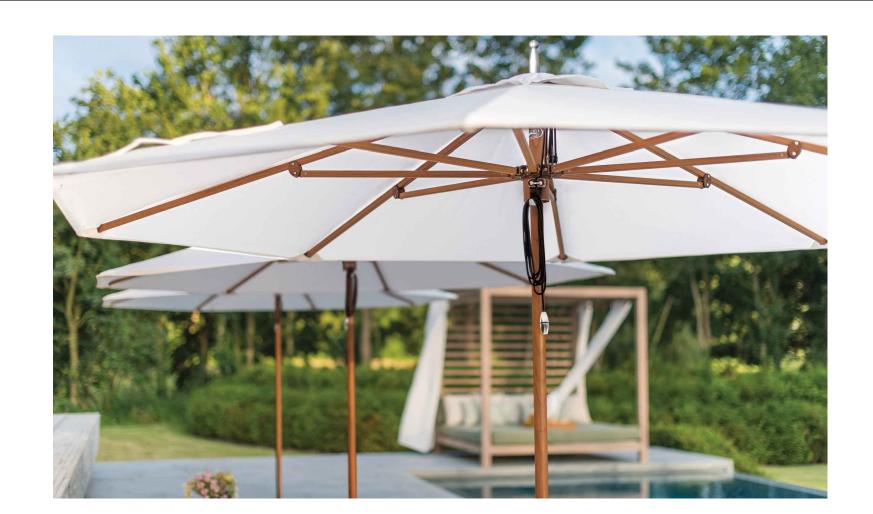







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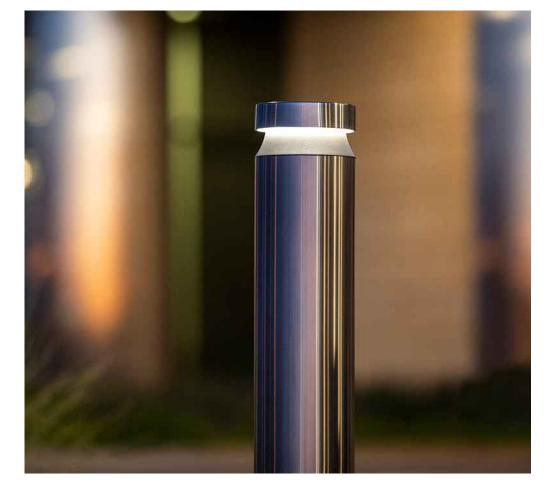


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SHEET NAME FURNISHING AND MATERIALS PALETTE

SHEET NO. LA-03