PROFESSIONAL MEDICAL OFFICE BUILDING

@ 11 NW 168th STREET, NORTH MIAMI BEACH, FLORIDA



PLANA INTERNATIONA

ARCHITECT

1053 SW 12th STREET

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EDICAL OFFICE BUILDII
11 NW 168 STREET
NORTH MIAMI BEACH, FLORIDA 33169
Client Name
FV GOLDEN GROUP, LLC

PROJECT No.

DRAWN BY:

FOLIO #: 07-2113-007-0480

CAD FILE: 12-10-2020

.B. AS-BUILT
A.P. REVISION AFTER PERMIT
D.C. BUILDING DEPT. COMMEN
.C. COORDINATION CHANGES
.S. PERMIT SET
.D. DESIGN DEVELOPMENT
.H. PUBLIC HEARING

olot date: 12-10-2

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SHEET TITLE





PLANA INTERNATIONAL

JAIME PLANA ARCHITECT FLORIDA LICENSE AR 9769

1053 SW 12th STREET

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11 NW 168 STREET

ORTH MIAMI BEACH, FLORIDA 3316

Client Name

FV GOLDEN GROUP, LLC

PROJECT No.

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P.H. PUBLIC HEARING

JAIME PLANA

plot date:

12-10-2020
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RENDERINGS

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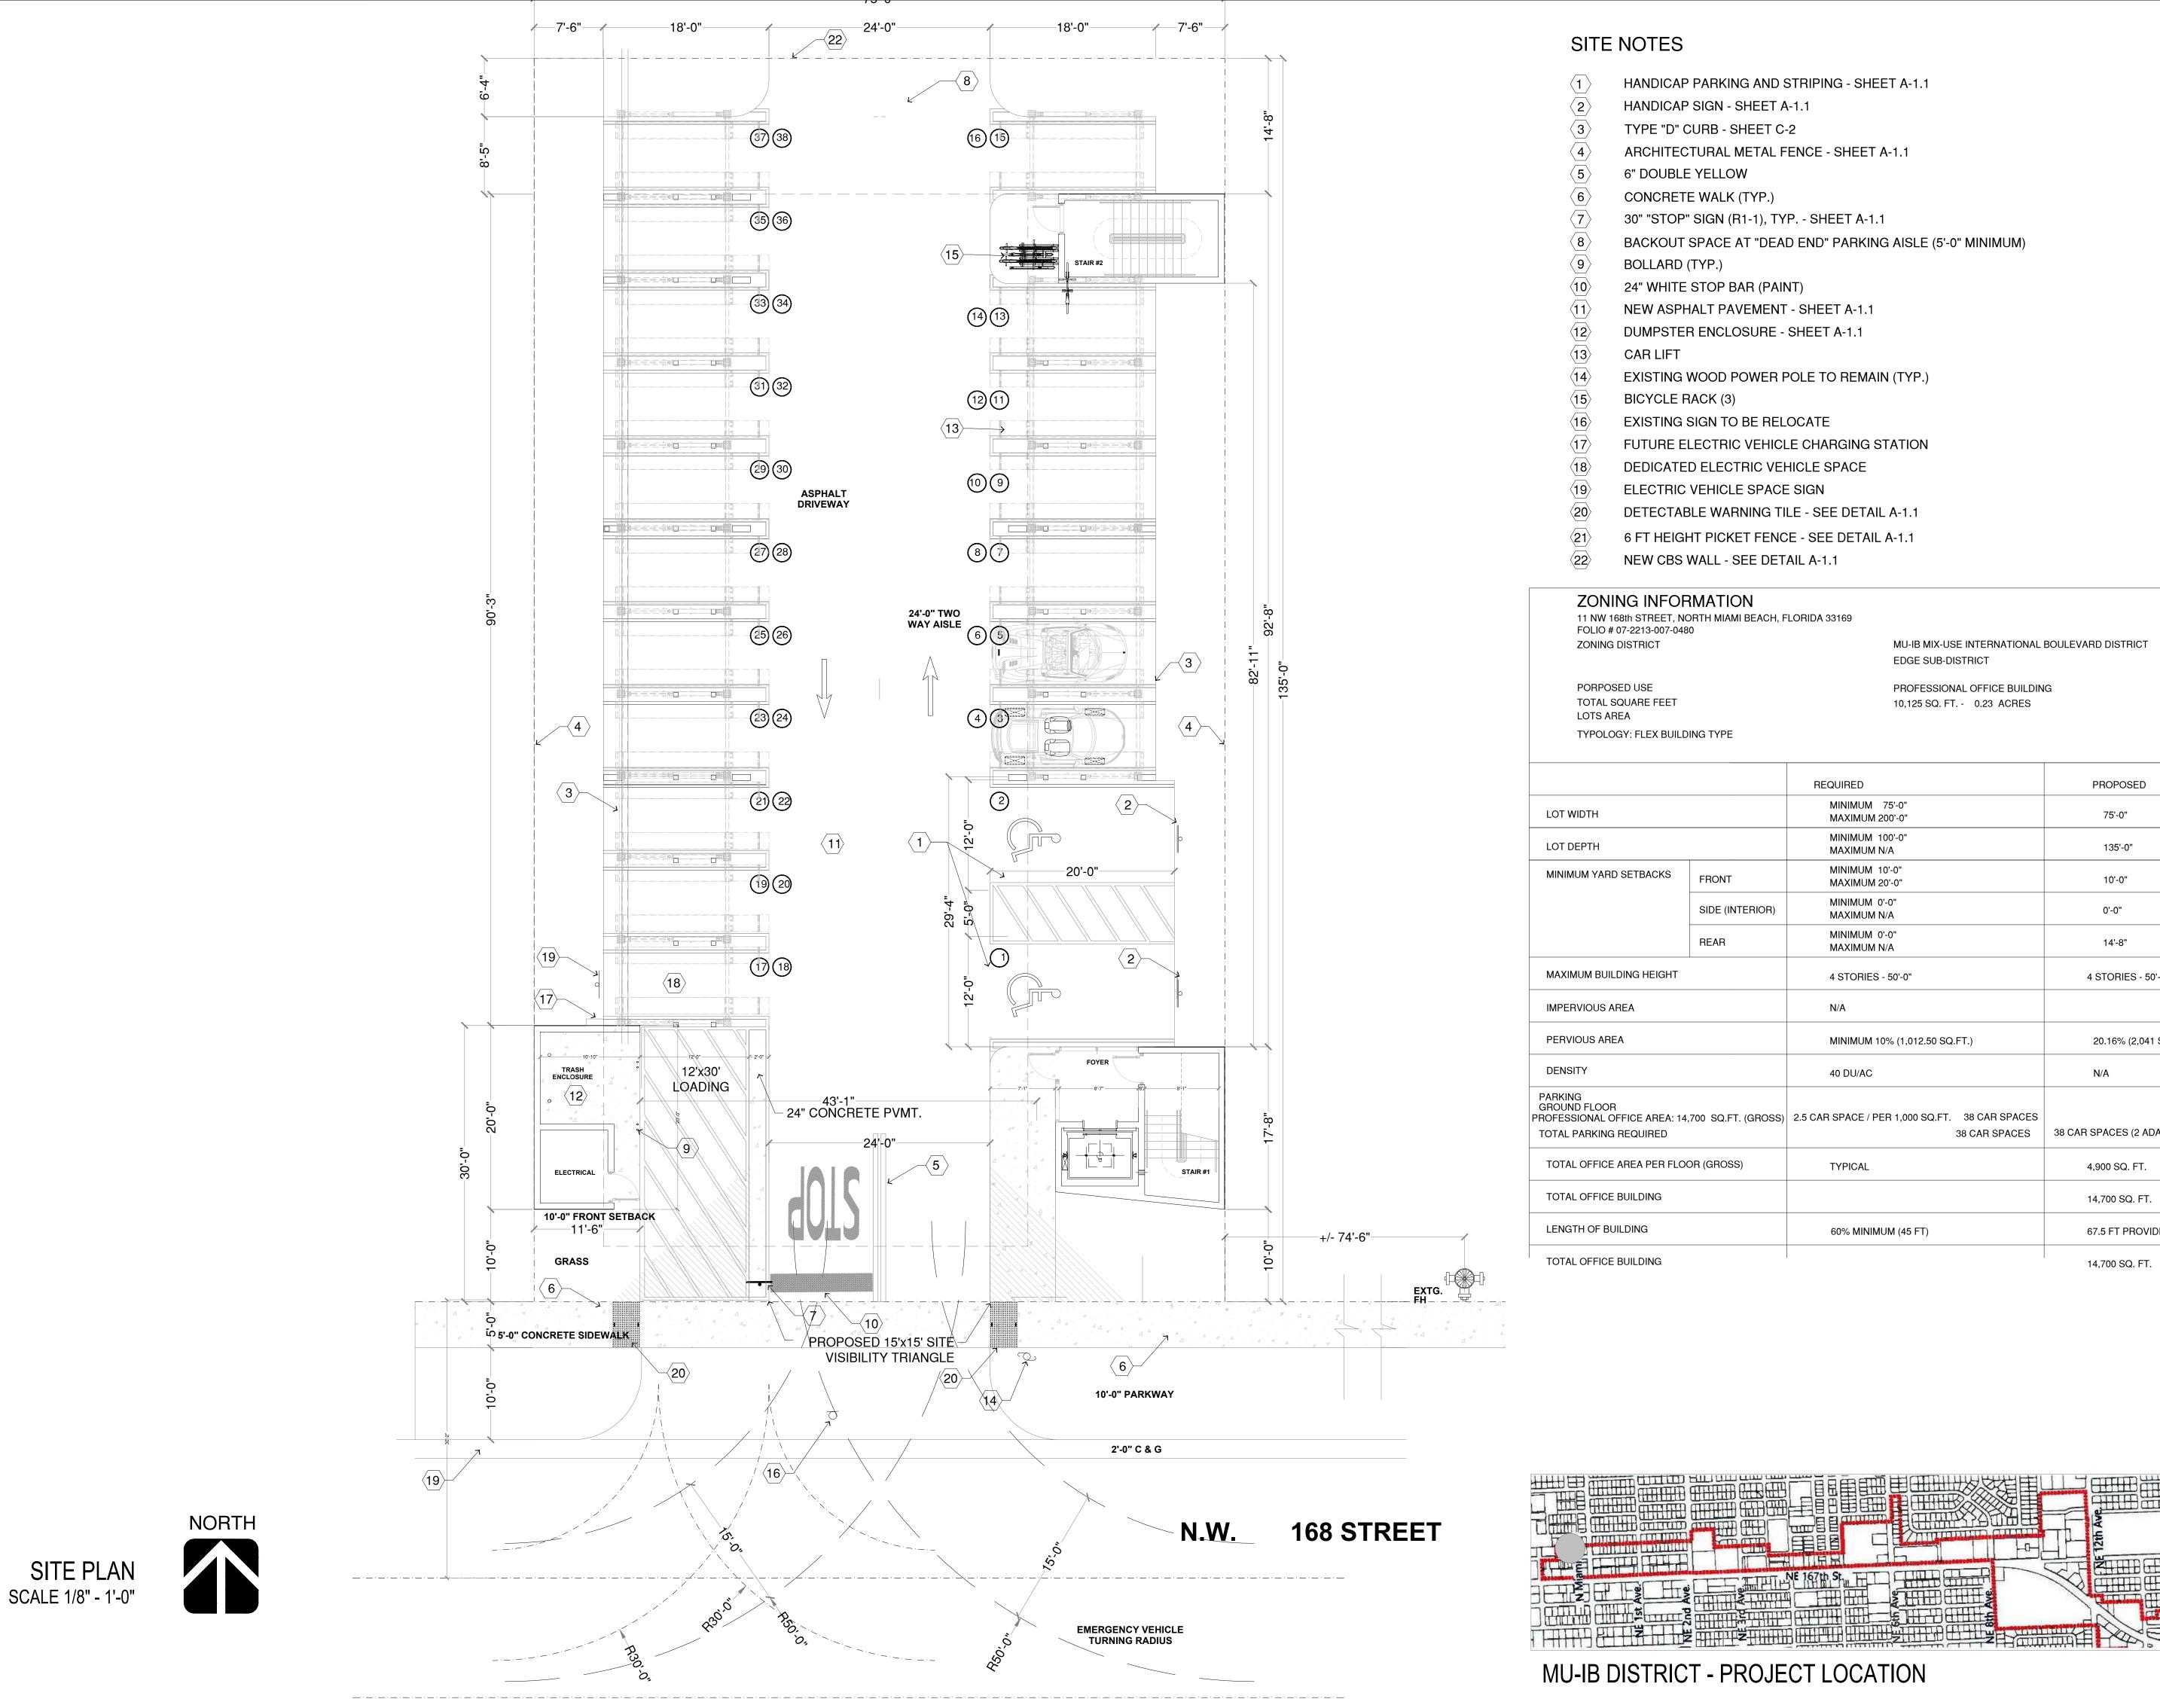
P.H. PUBLIC HEARING

lot date: 12-10-2020

SHEET TITLE

RENDERINGS

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		REQUIRED	PROPOSED	
LOT WIDTH		MINIMUM 75'-0" MAXIMUM 200'-0"	75'-0"	
LOT DEPTH		MINIMUM 100'-0" MAXIMUM N/A	135'-0"	
MINIMUM YARD SETBACKS	FRONT	MINIMUM 10'-0" MAXIMUM 20'-0"	10'-0"	
	SIDE (INTERIOR)	MINIMUM 0'-0" MAXIMUM N/A	0'-0"	
	REAR	MINIMUM 0'-0" MAXIMUM N/A	14'-8"	
MAXIMUM BUILDING HEIGHT		4 STORIES - 50'-0"	4 STORIES - 50'-0"	
IMPERVIOUS AREA		N/A		
PERVIOUS AREA		MINIMUM 10% (1,012.50 SQ.FT.)	20.16% (2,041 SQ.FT.)	
DENSITY		40 DU/AC	N/A	
PARKING GROUND FLOOR PROFESSIONAL OFFICE AREA: 14,700 SQ.FT. (GROSS) TOTAL PARKING REQUIRED		2.5 CAR SPACE / PER 1,000 SQ.FT. 38 CAR SPACES 38 CAR SPACES	38 CAR SPACES (2 ADA SPACES INCLUDE	
TOTAL OFFICE AREA PER FLOOR (GROSS)		TYPICAL	4,900 SQ. FT.	
TOTAL OFFICE BUILDING			14,700 SQ. FT.	
LENGTH OF BUILDING		60% MINIMUM (45 FT)	67.5 FT PROVIDED	

SHEET TITLE SITE PLAN

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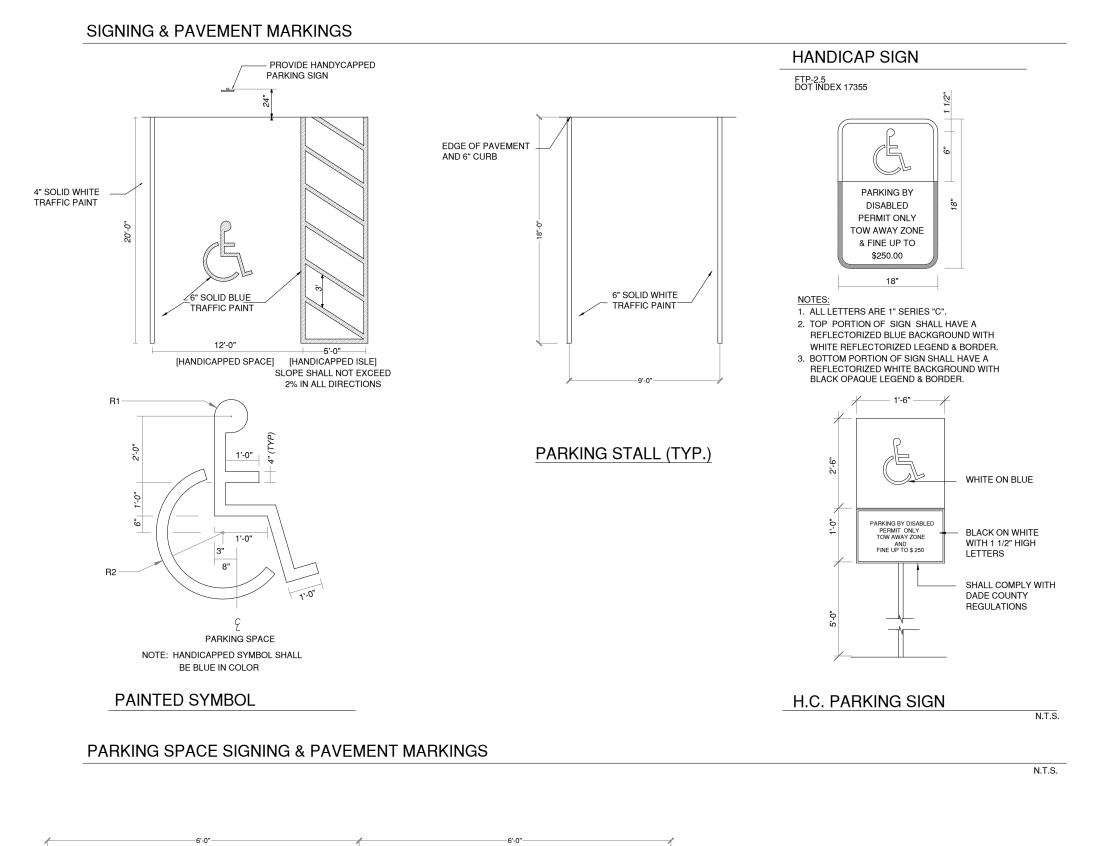
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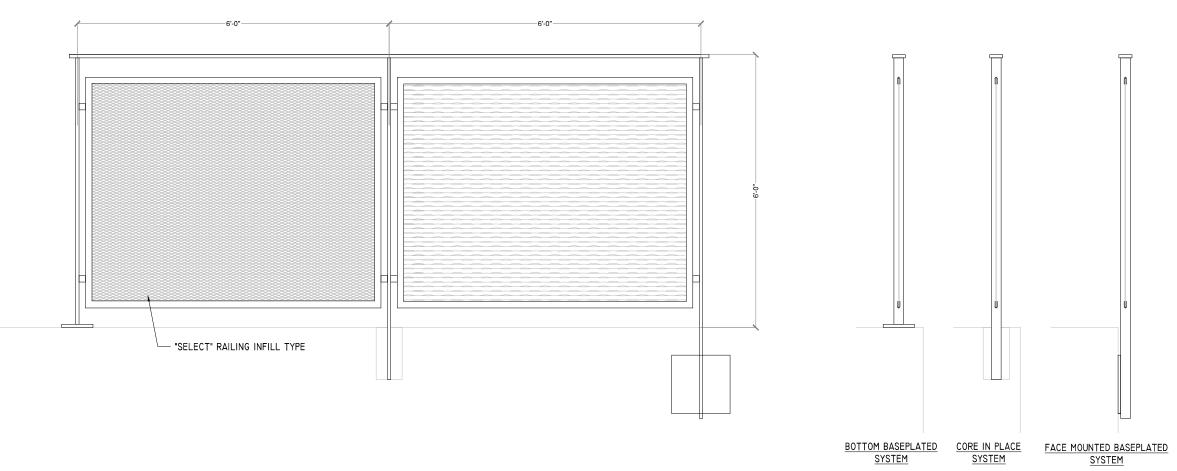
COORDINATION CHANGES

DESIGN DEVELOPMENT PUBLIC HEARING


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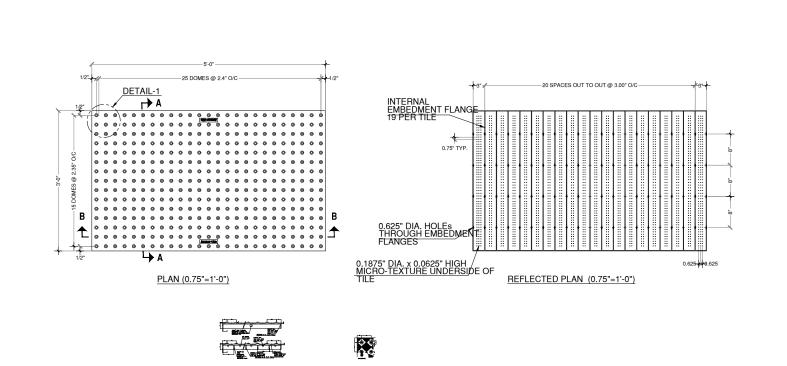
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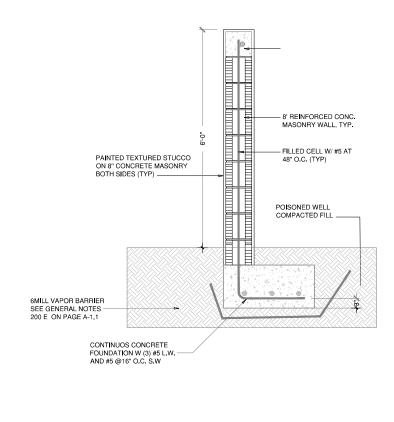











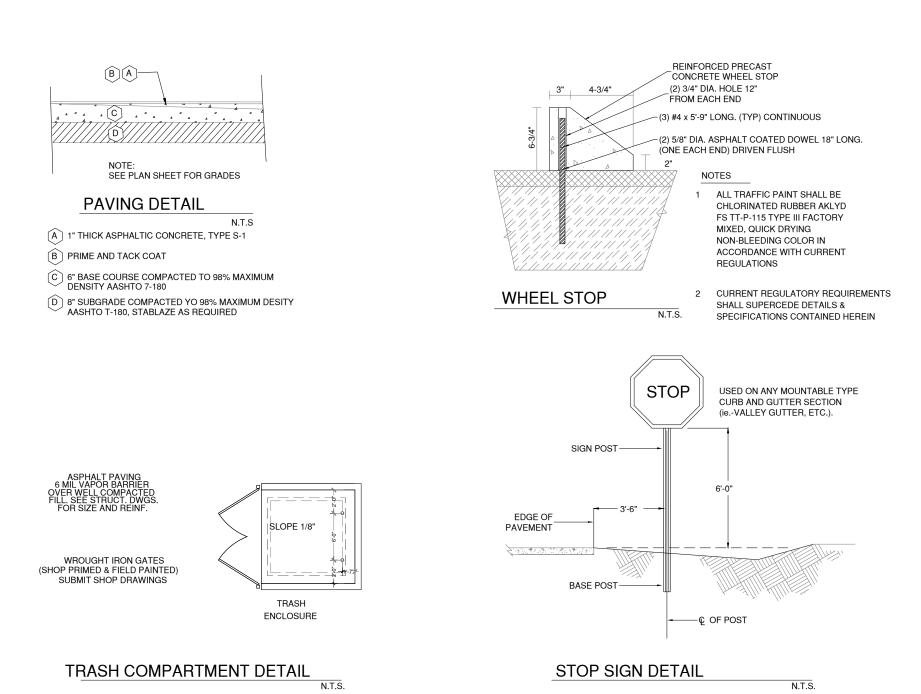




SIGN AND POST DETAILS

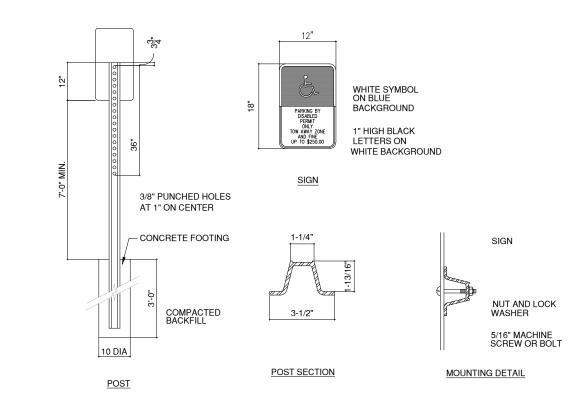

NOTE: (PAINT OPTION)

POST SHALL BE CAREFULLY CLEANED AND PHOSPHATED IMMEDIATELY AFTER PHOSPHATING POST SHALL BE COATED WITH A MODIEFIED POLYESTER PAINT BY ELECTRODEPOSITION AND THEN THROUGHLY BAKED, COLOR PERMA-GREEN PER FEDERAL STANDARD 595-A COLOR NUMBER 14109 (DARK LIMIT V)

NOTE:
HANDICAP SIGN SHALL COMPLY WITH FLORIDA ACCESSIBILY CODE FOR BUILDING CONSTRUCTION, 1994 EDITION AND
WITH THE LATEST REQUIREMENTS OF GOVERNMENT BODIES HAVING JUIRISDICTION. STROLLER AND BICYCLE PARKING
SHALL BE AS PER DADE COUNTY ORDINANCES.

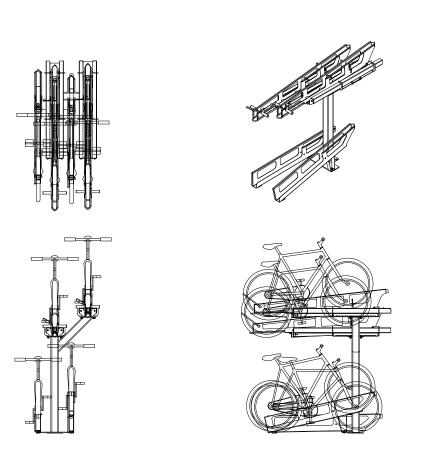

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Project Name and Address:
PROPOSED SITE PLAN FOR
MEDICAL OFFICE BUILDING
11 NW 168 STREET
NORTH MIAMI BEACH, FLORIDA 33169
Client Name
FV GOLDEN GROUP, LLC

PROJECT No.

DRAWN BY:

FOLIO #: 07-2113-007-0480


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P.H. PUBLIC HEARING

JAIME PLANA SEAL





SITE NOTES

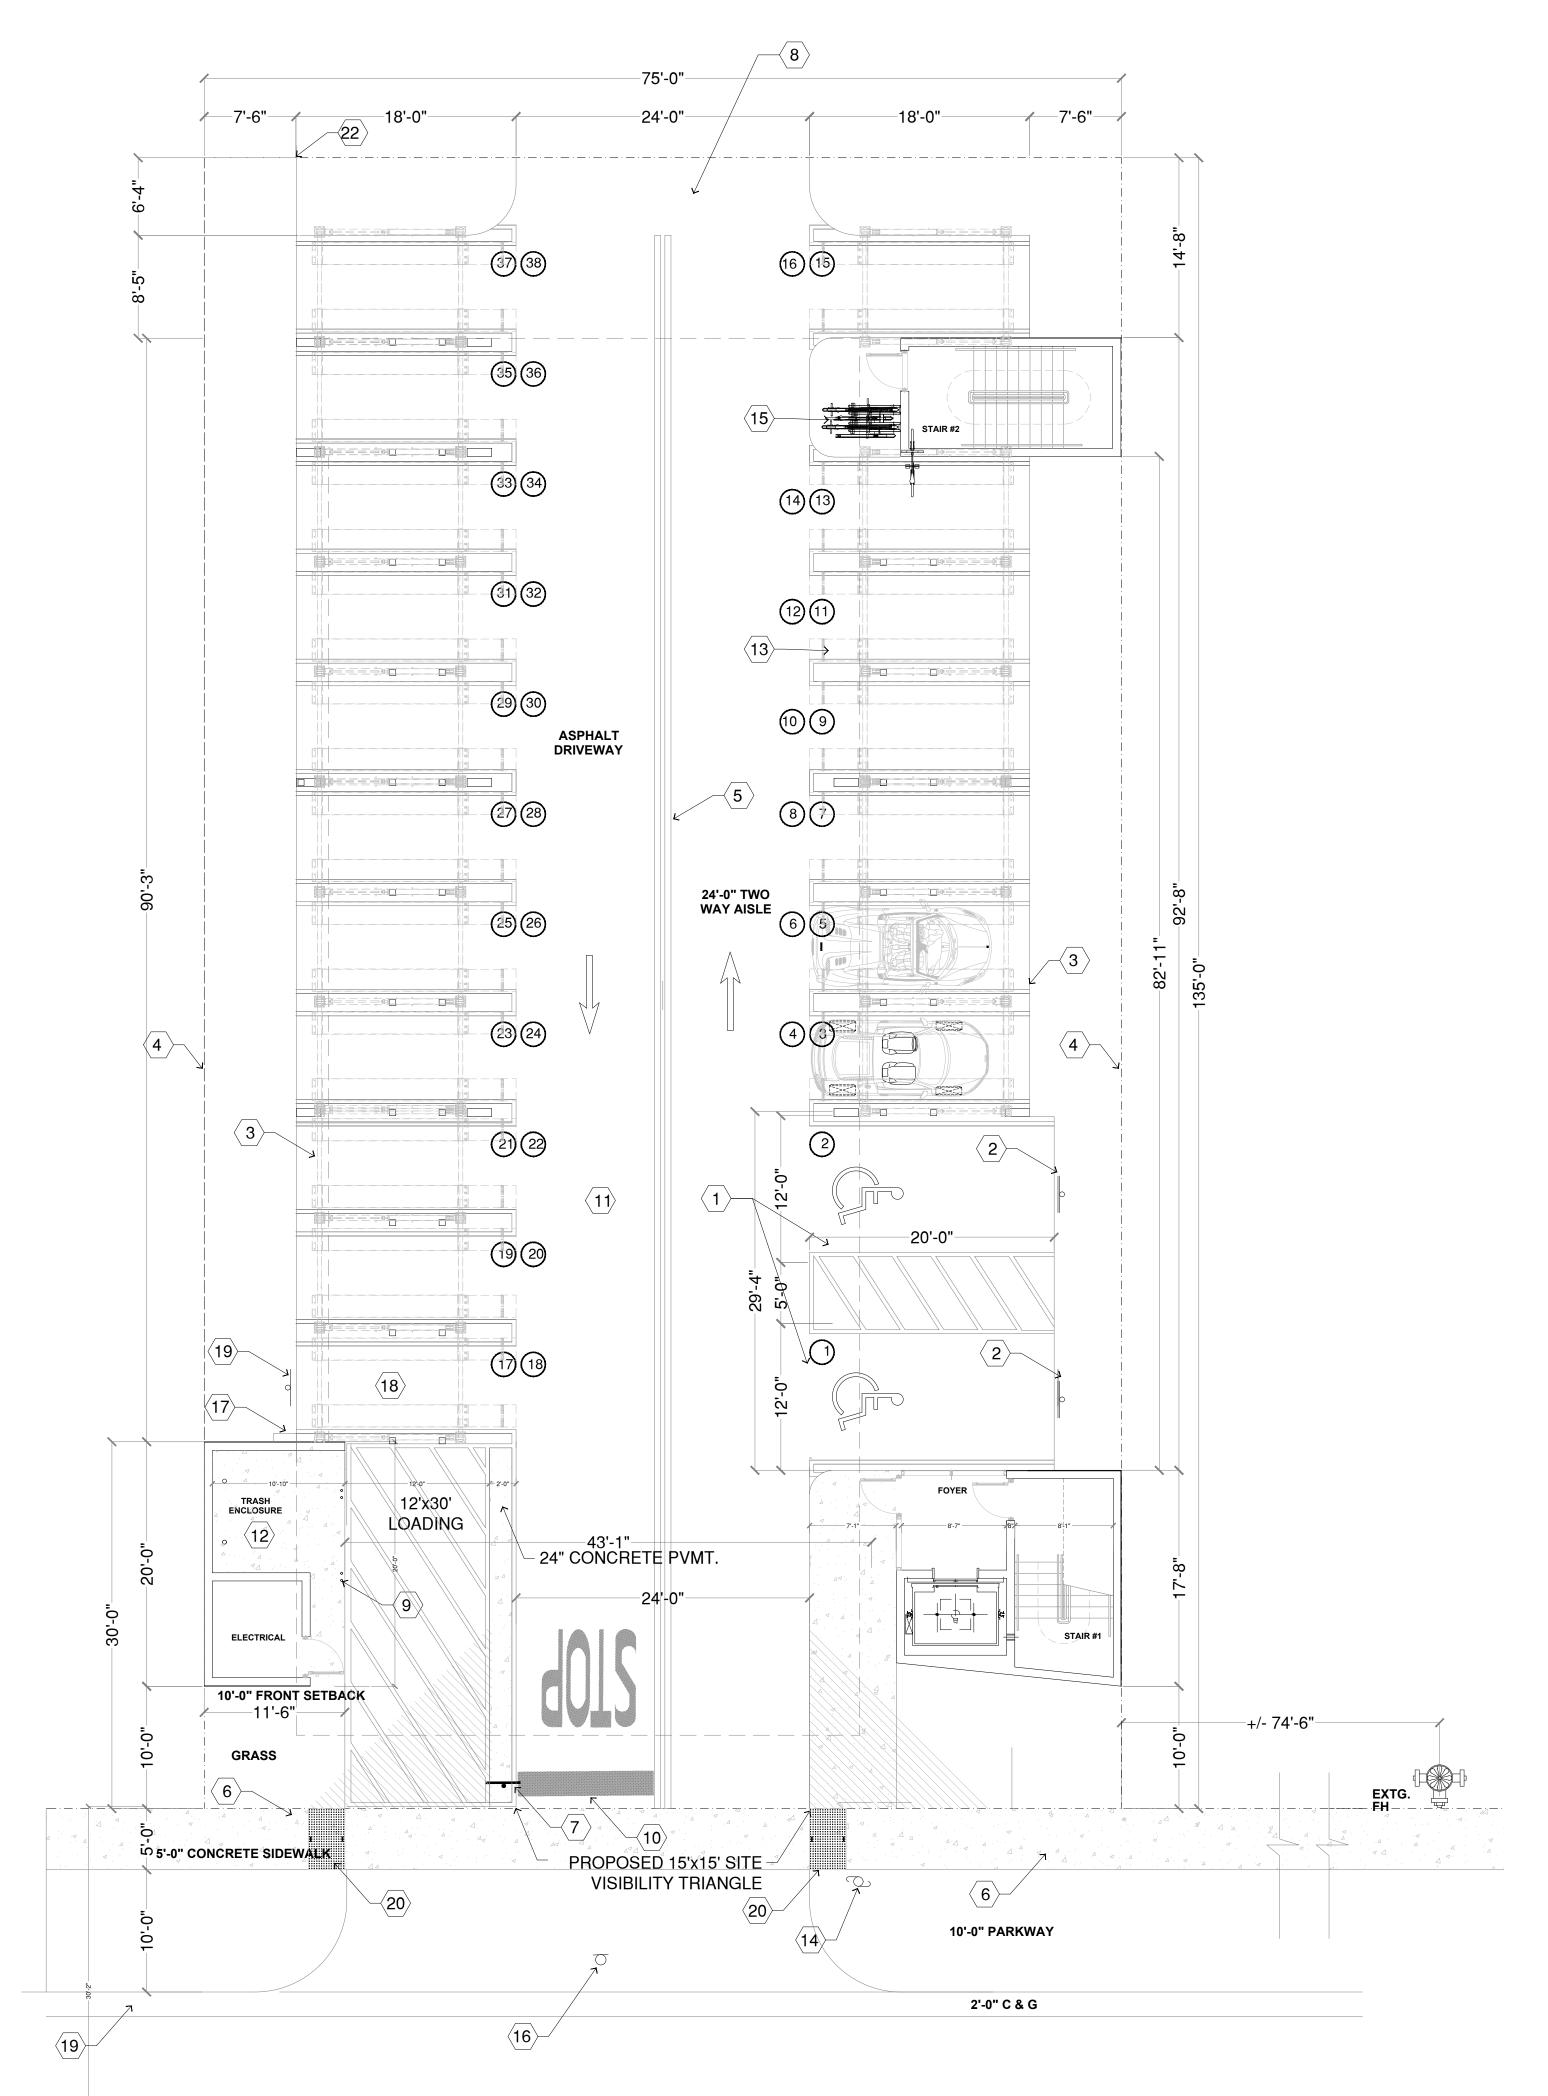- 1 HANDICAP PARKING AND STRIPING SHEET A-1.1
- (2) HANDICAP SIGN SHEET A-1.1
- D CURB DETAIL "A" SHEET C-2
- 4 ARCHITECTURAL METAL FENCE SHEET A-1.1
- 6" DOUBLE YELLOW
- 6 CONCRETE WALK (TYP.)
- 30" "STOP" SIGN (R1-1), TYP. SHEET A-1.1
- BACKOUT SPACE AT "DEAD END" PARKING AISLE (5'-0" MINIMUM)
- 9 BOLLARD (TYP.)
- 0 24" WHITE STOP BAR (PAINT)
- NEW ASPHALT PAVEMENT SHEET A-1.1
- DUMPSTER ENCLOSURE SHEET A-1.1
- (13) CAR LIFT
- EXISTING WOOD POWER POLE TO REMAIN (TYP.)
- EXISTING CONCRETE POWER & LIGHTING POLE TO BE RELOCATE
- EXISTING SIGN TO BE RELOCATE
- FUTURE ELECTRIC VEHICLE CHARGING STATTION
- 18 DEDICATED ELECTRIC VEHICLE SPACE
- (19) ELECTRIC VEHICLE SPACE SIGN
- 20 DETECTABLE WARNING TILE SEE DETAIL A-1.1
- 6 FT HEIGHT PICKET FENCE SEE DETAIL A-1.1

RAHIMI, RAHIMUDDIN CIVIL ENGINEER FLORIDA LICENSE 51484

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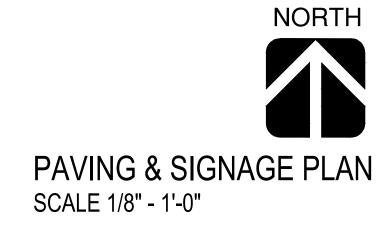
Architect:

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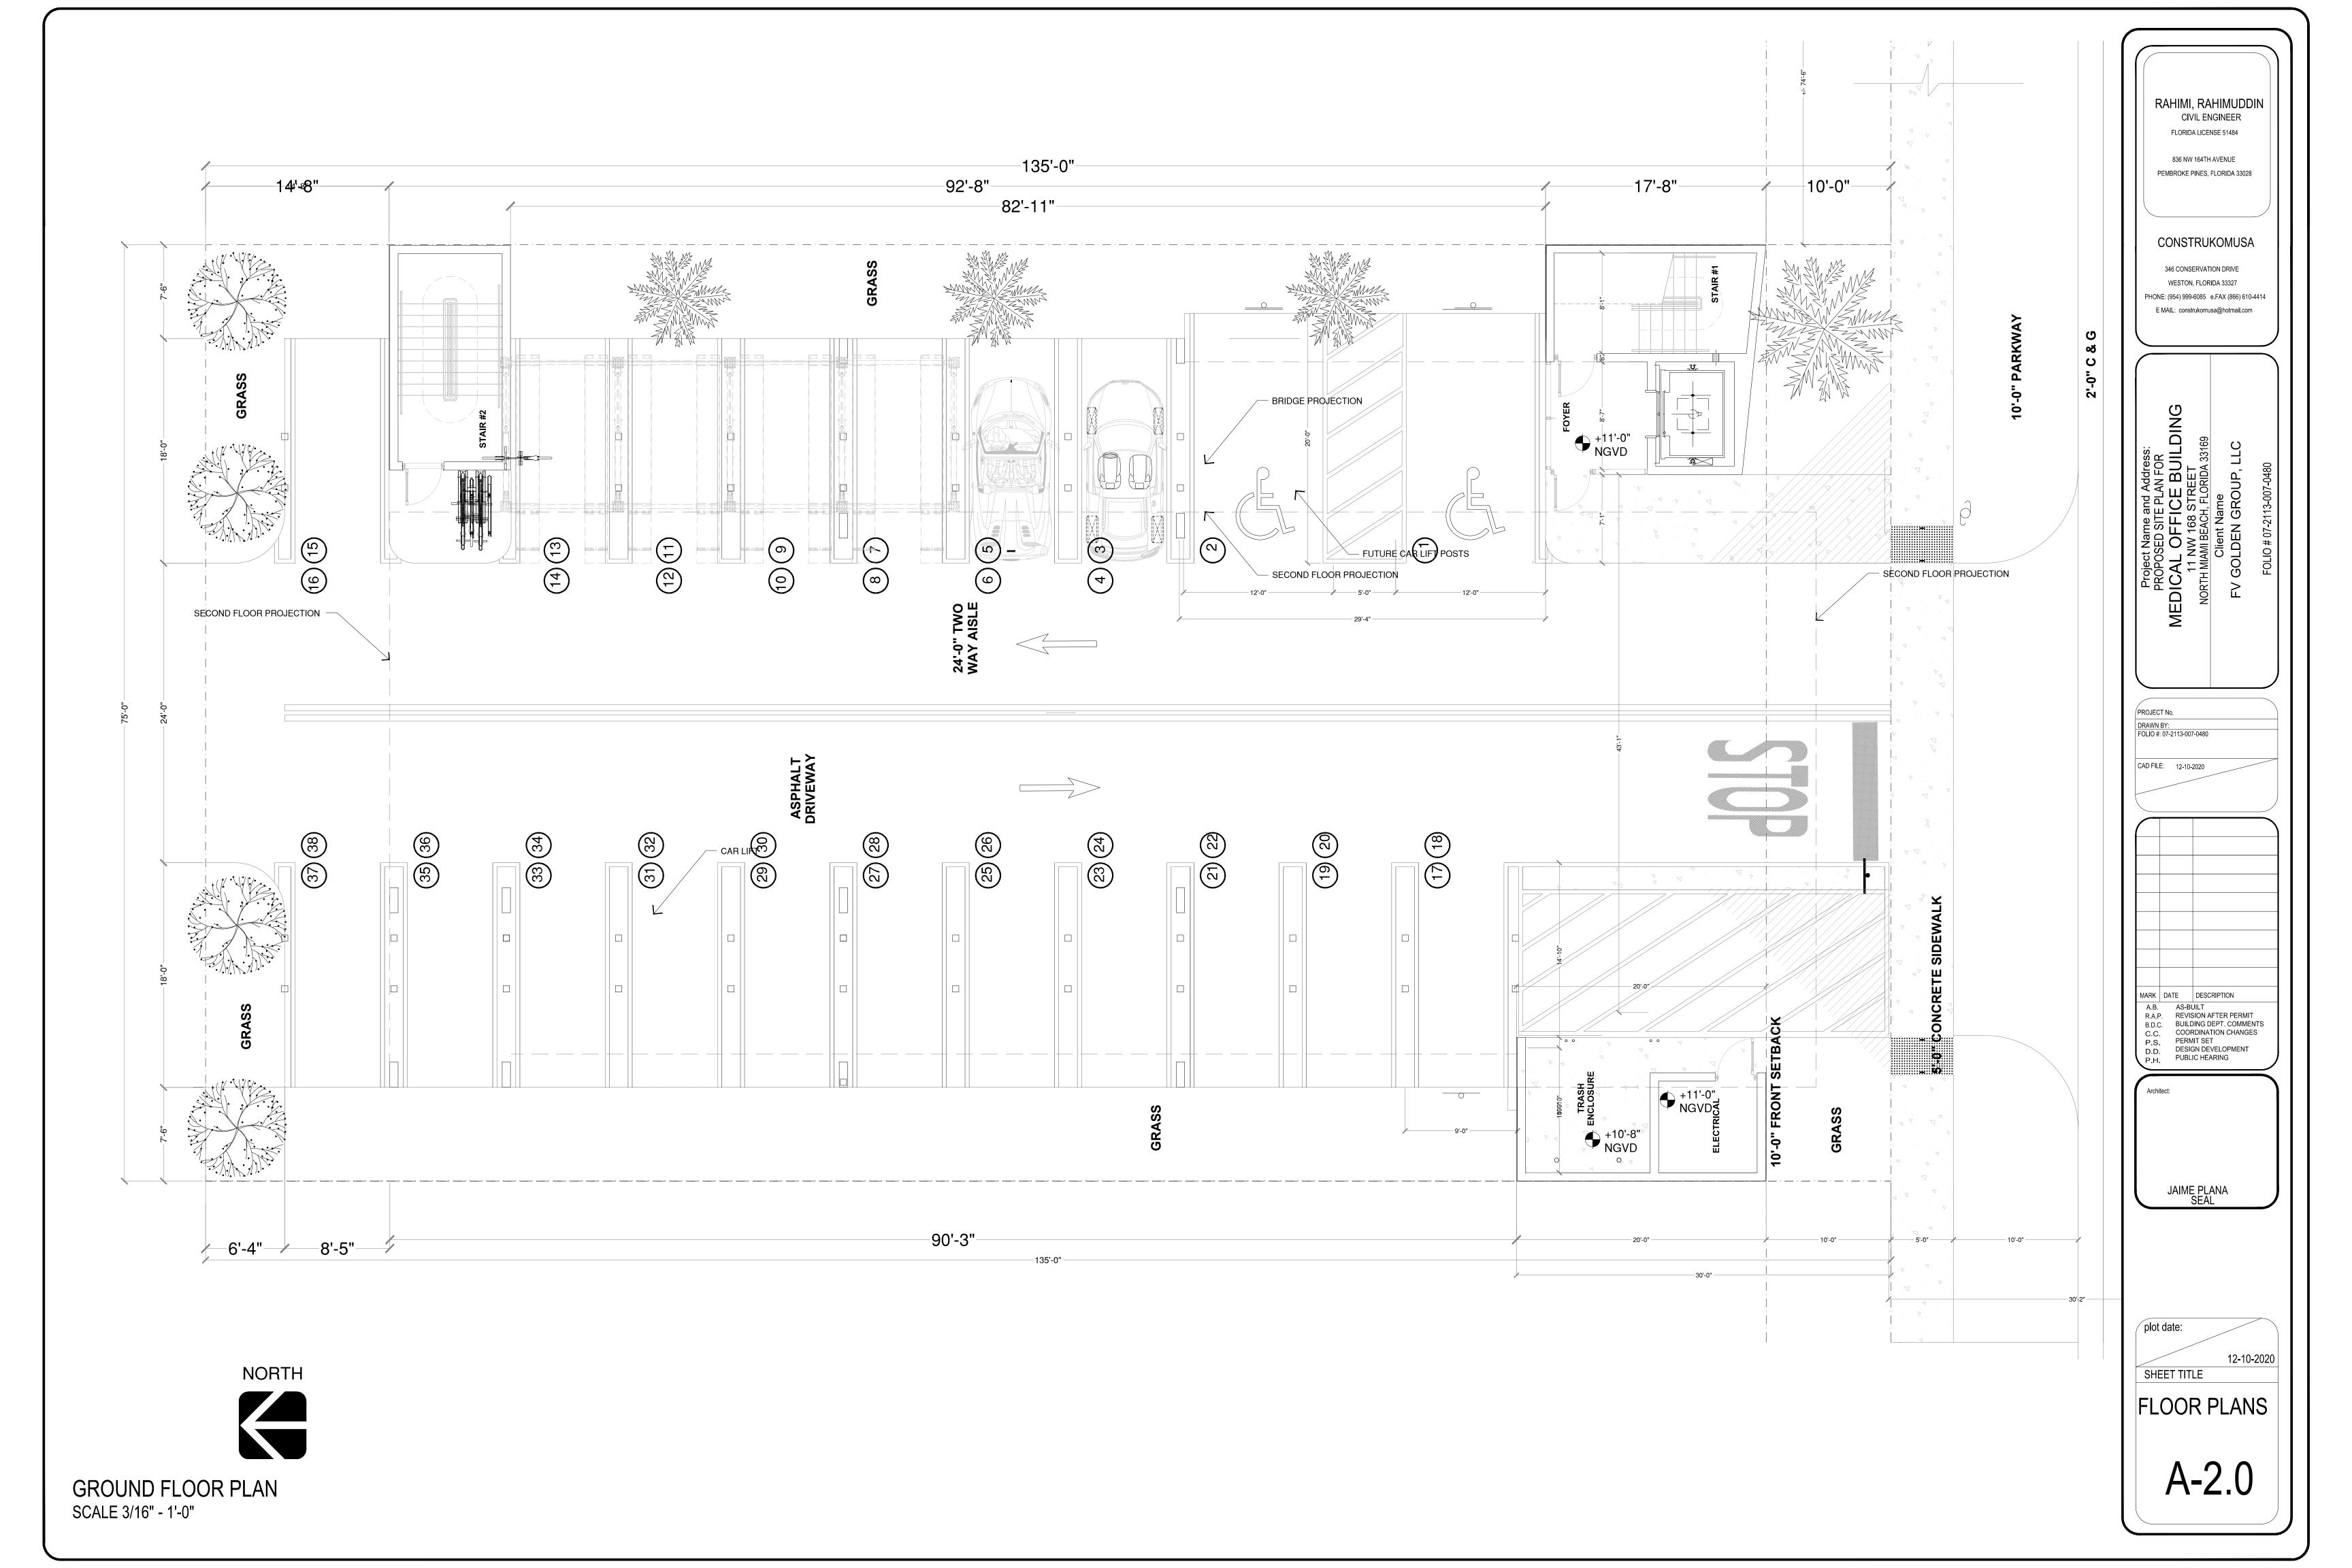
plot date:
12-10-2020
SHEET TITLE


PAVING & SIGNAGE PLAN

A-1.2



N.W. 168 STREET



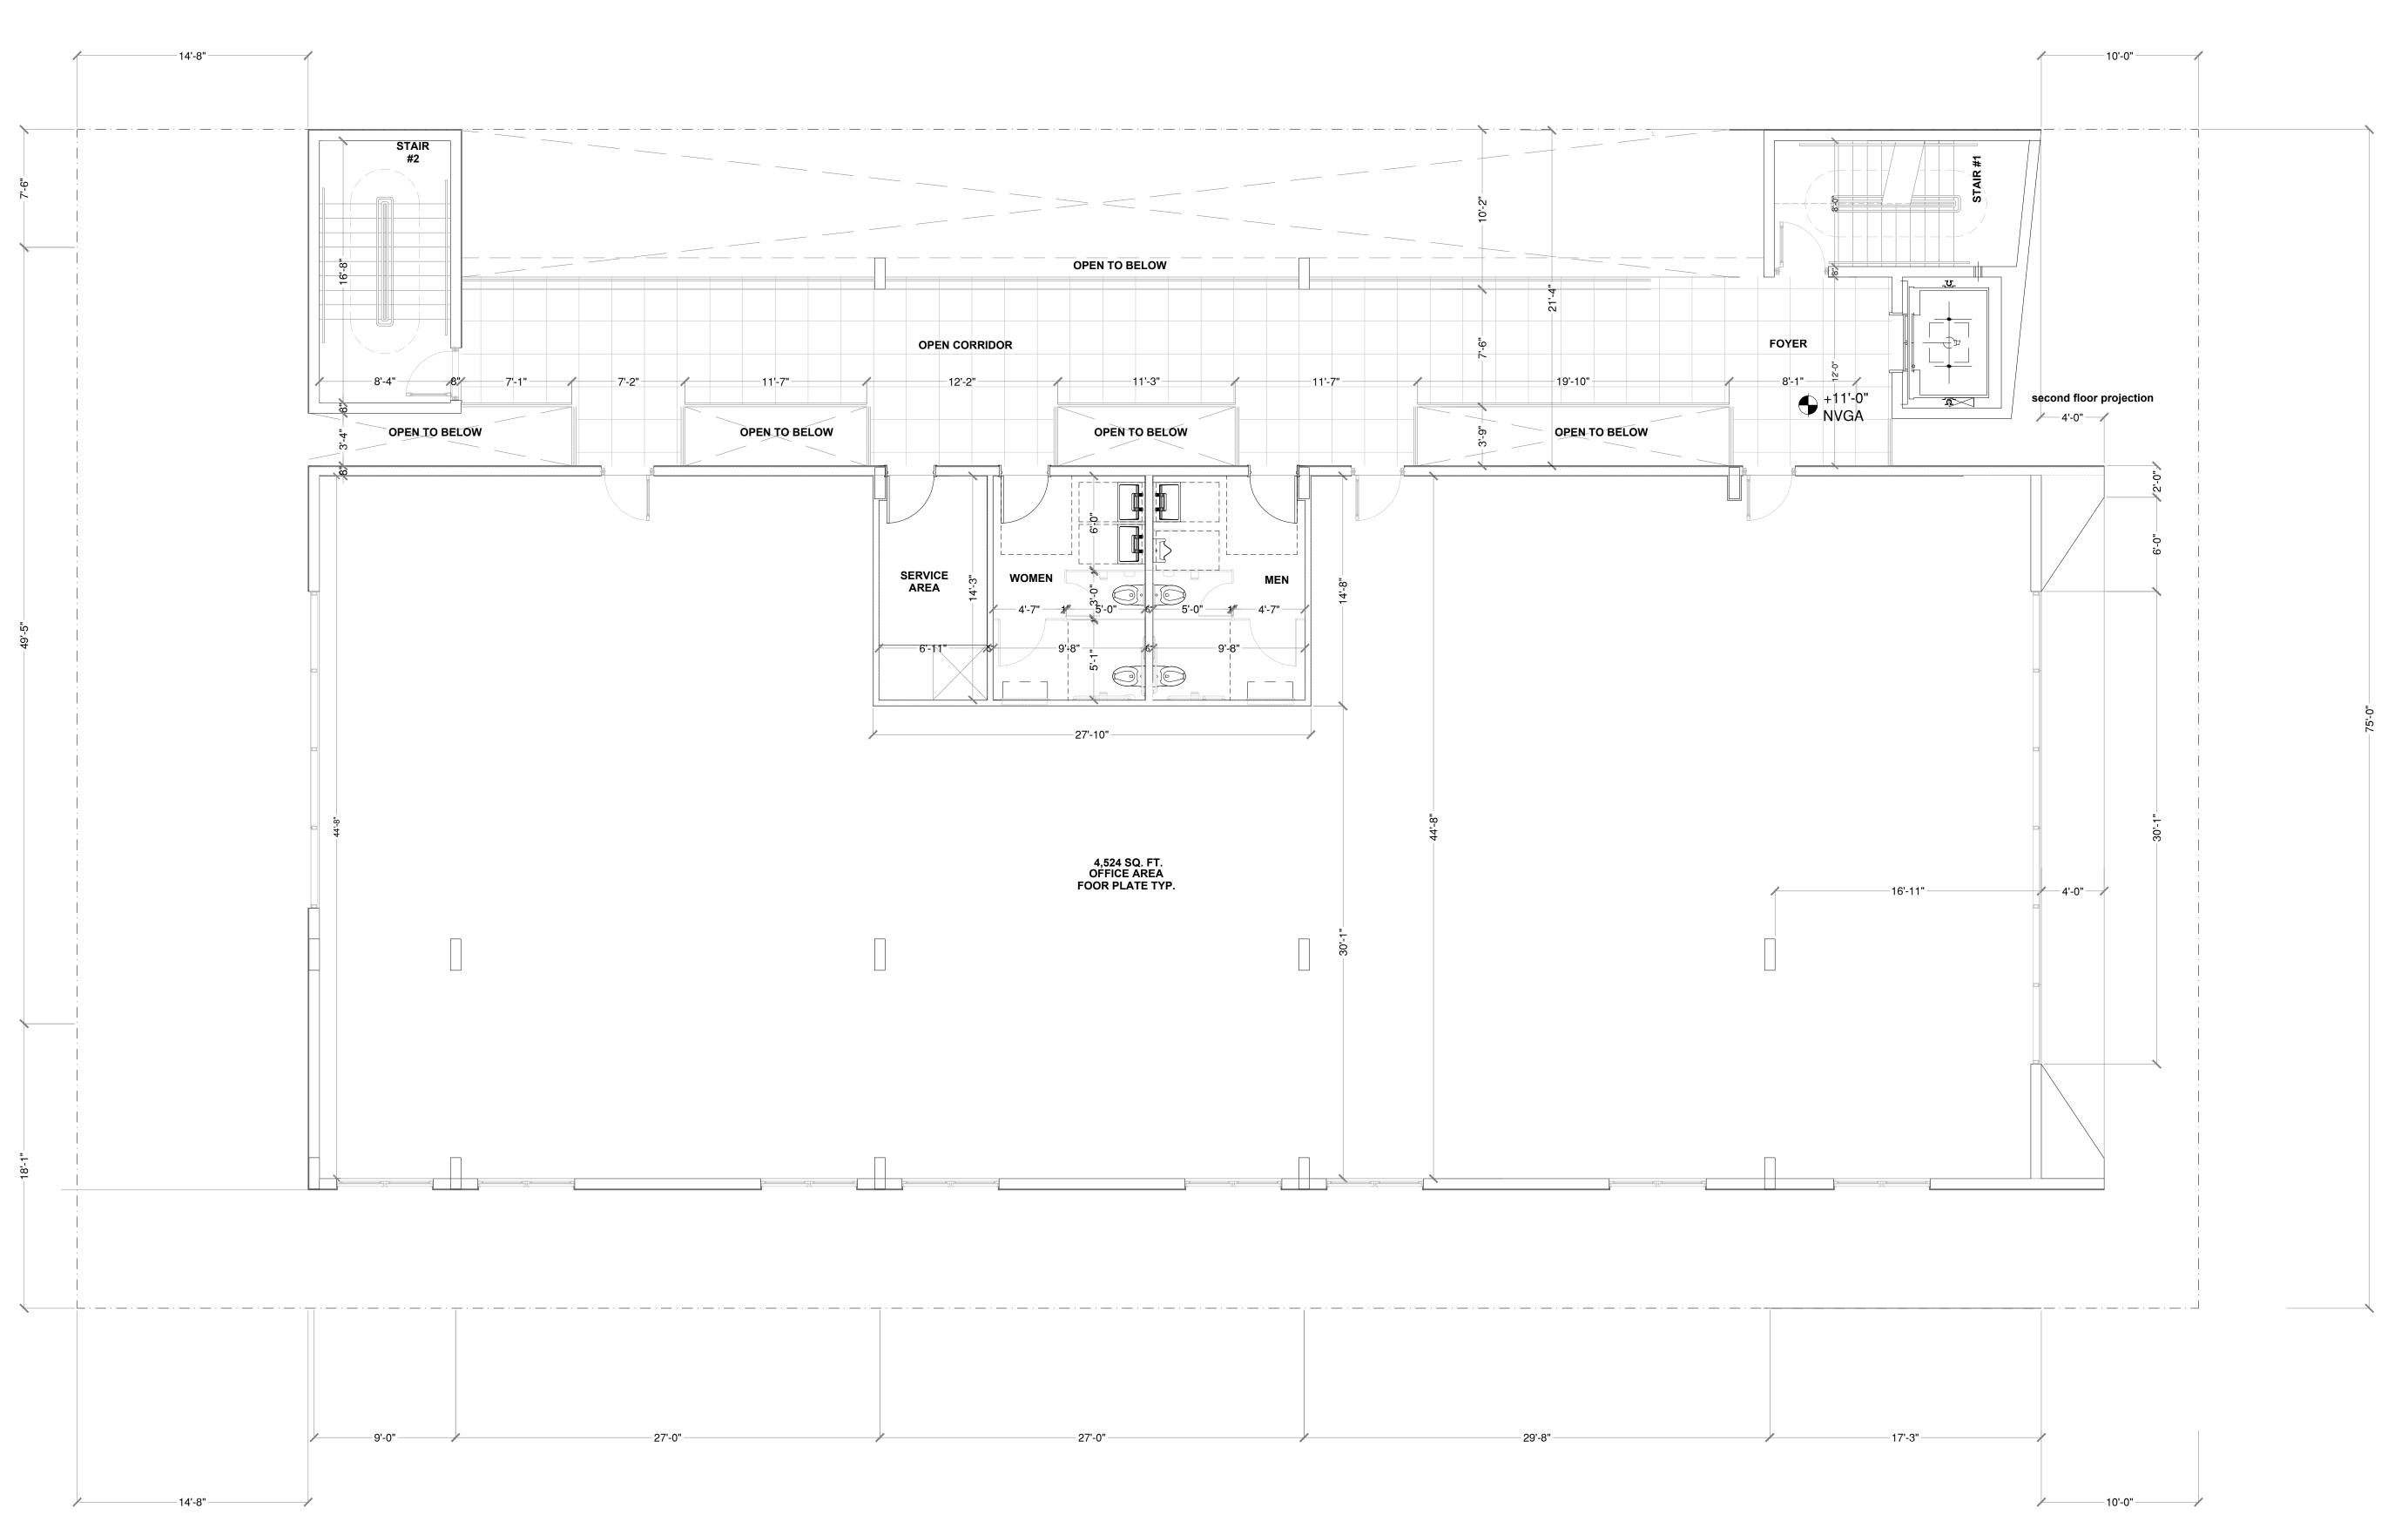

SECOND FLOOR PLAN
SCALE 3/16" - 1'-0"

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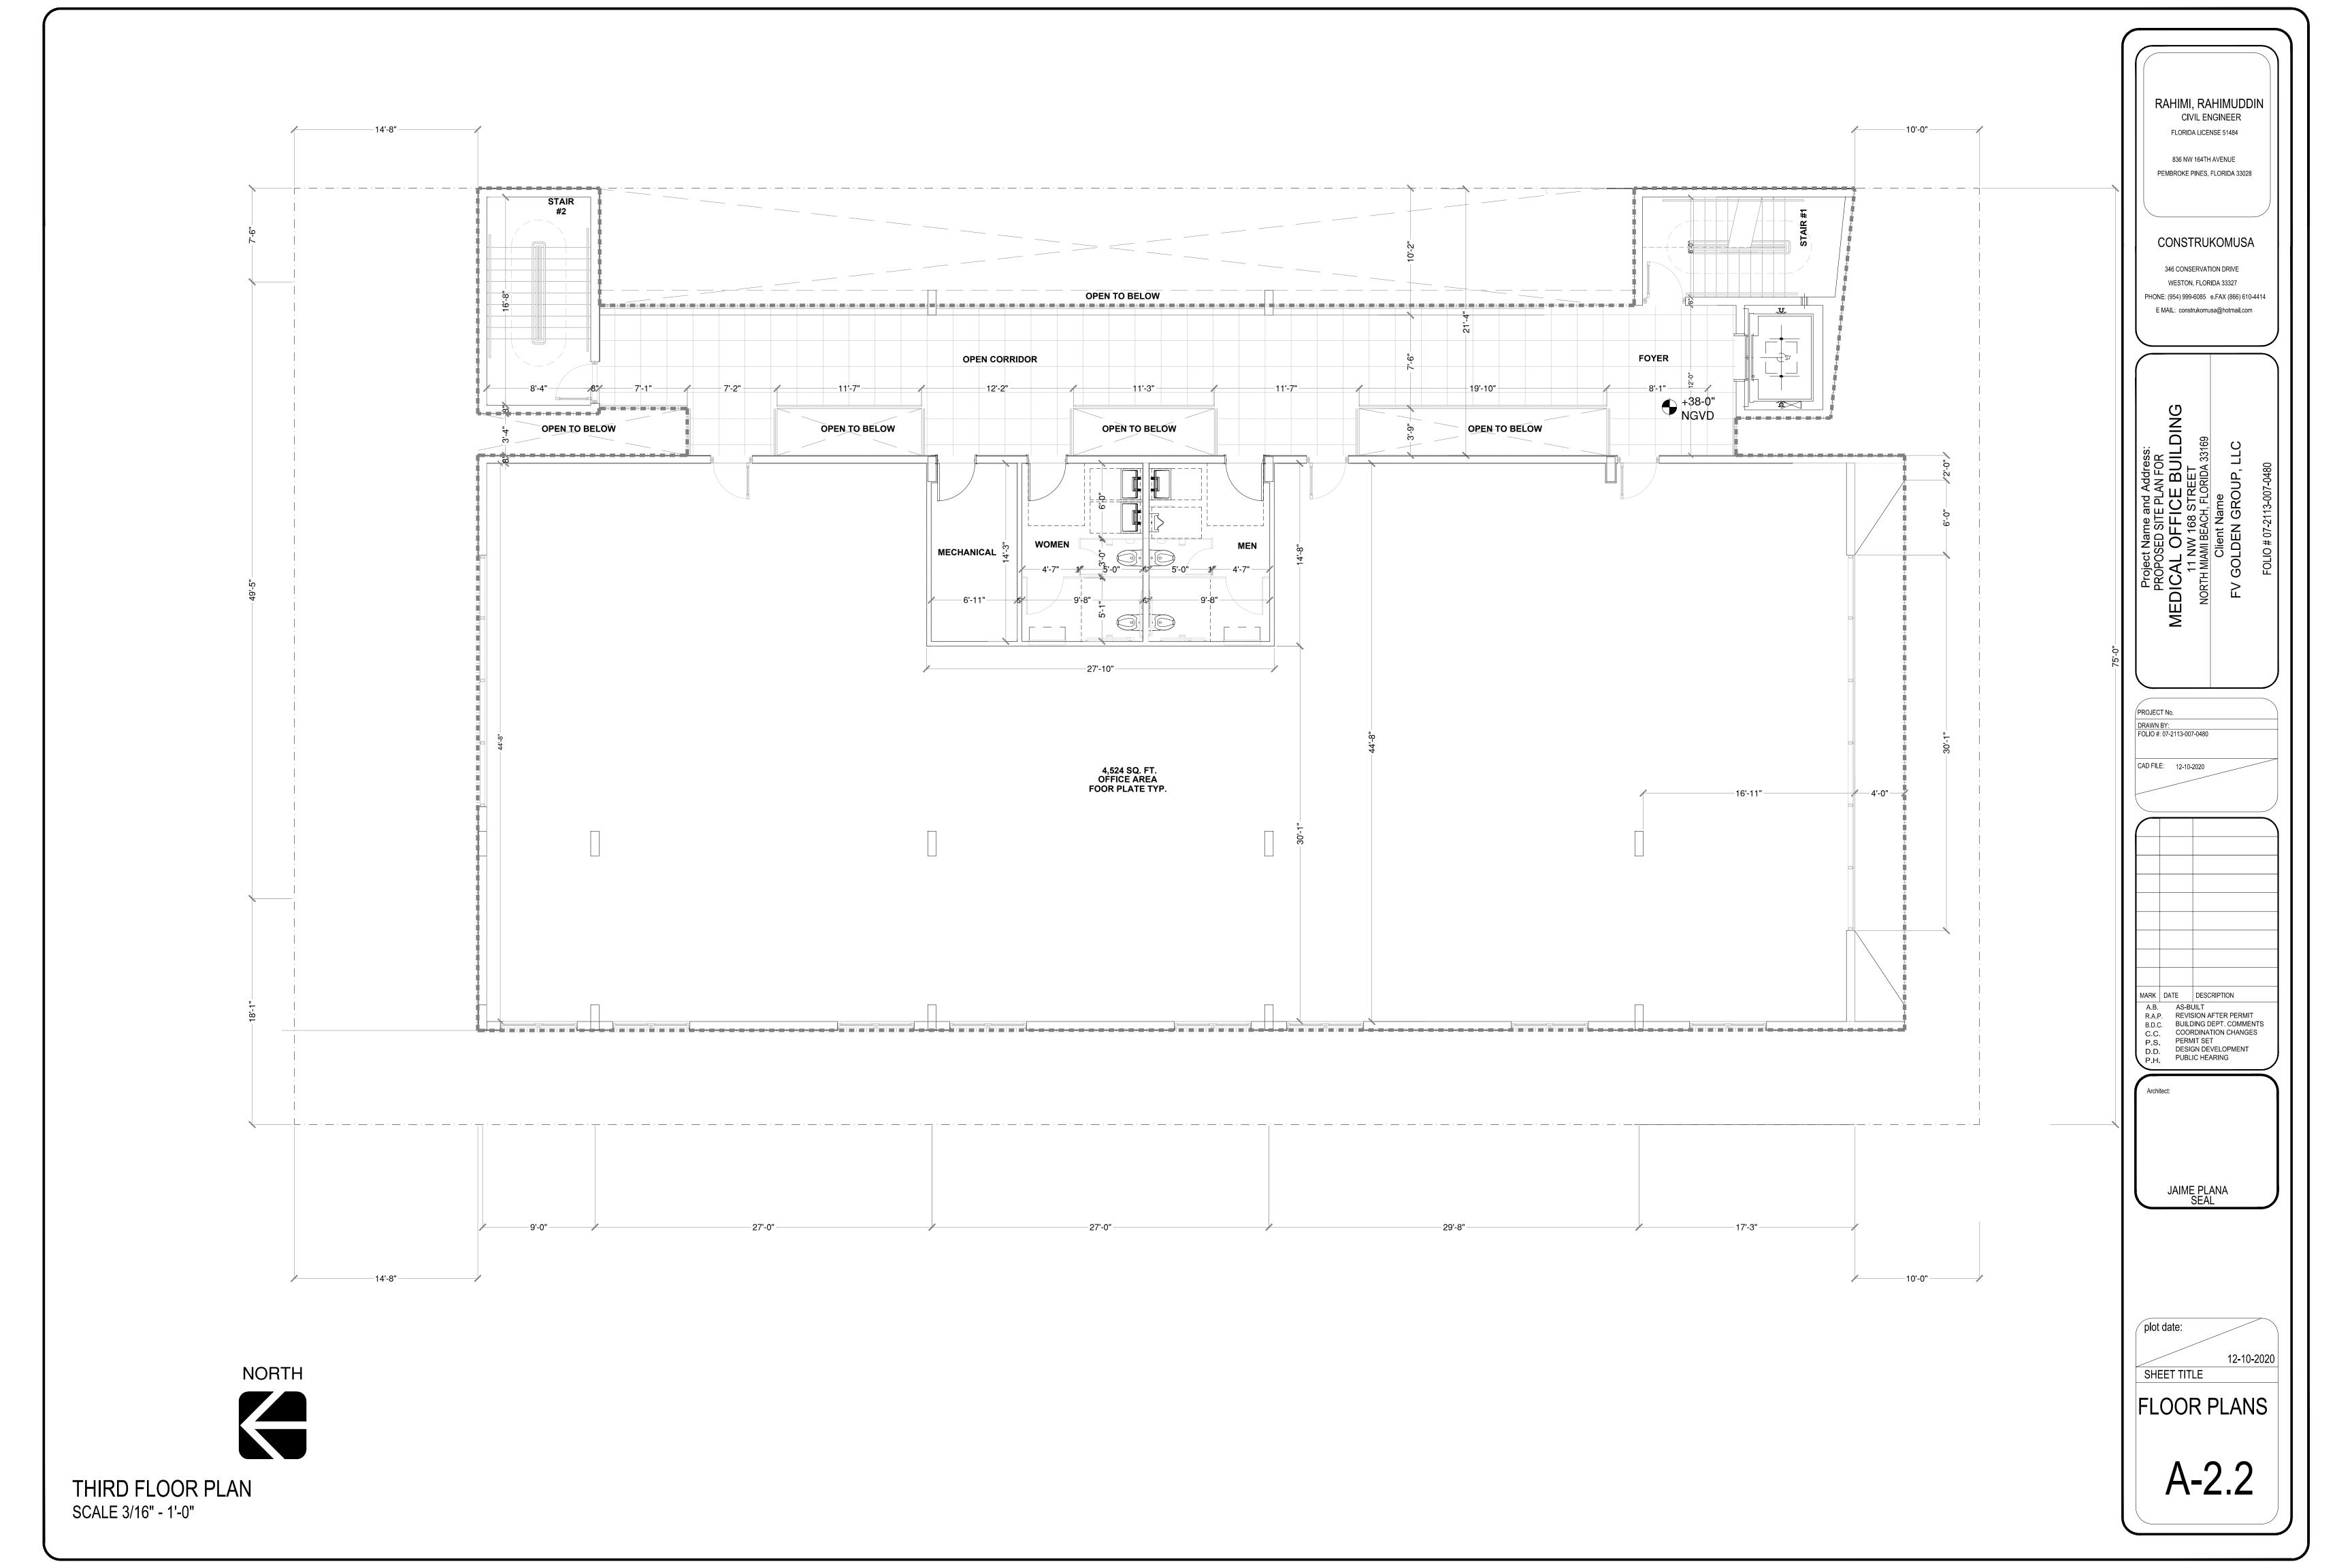
JAIME PLANA SEAL


olot date: 12-10-2020

SHEET TITLE

FLOOR PLANS

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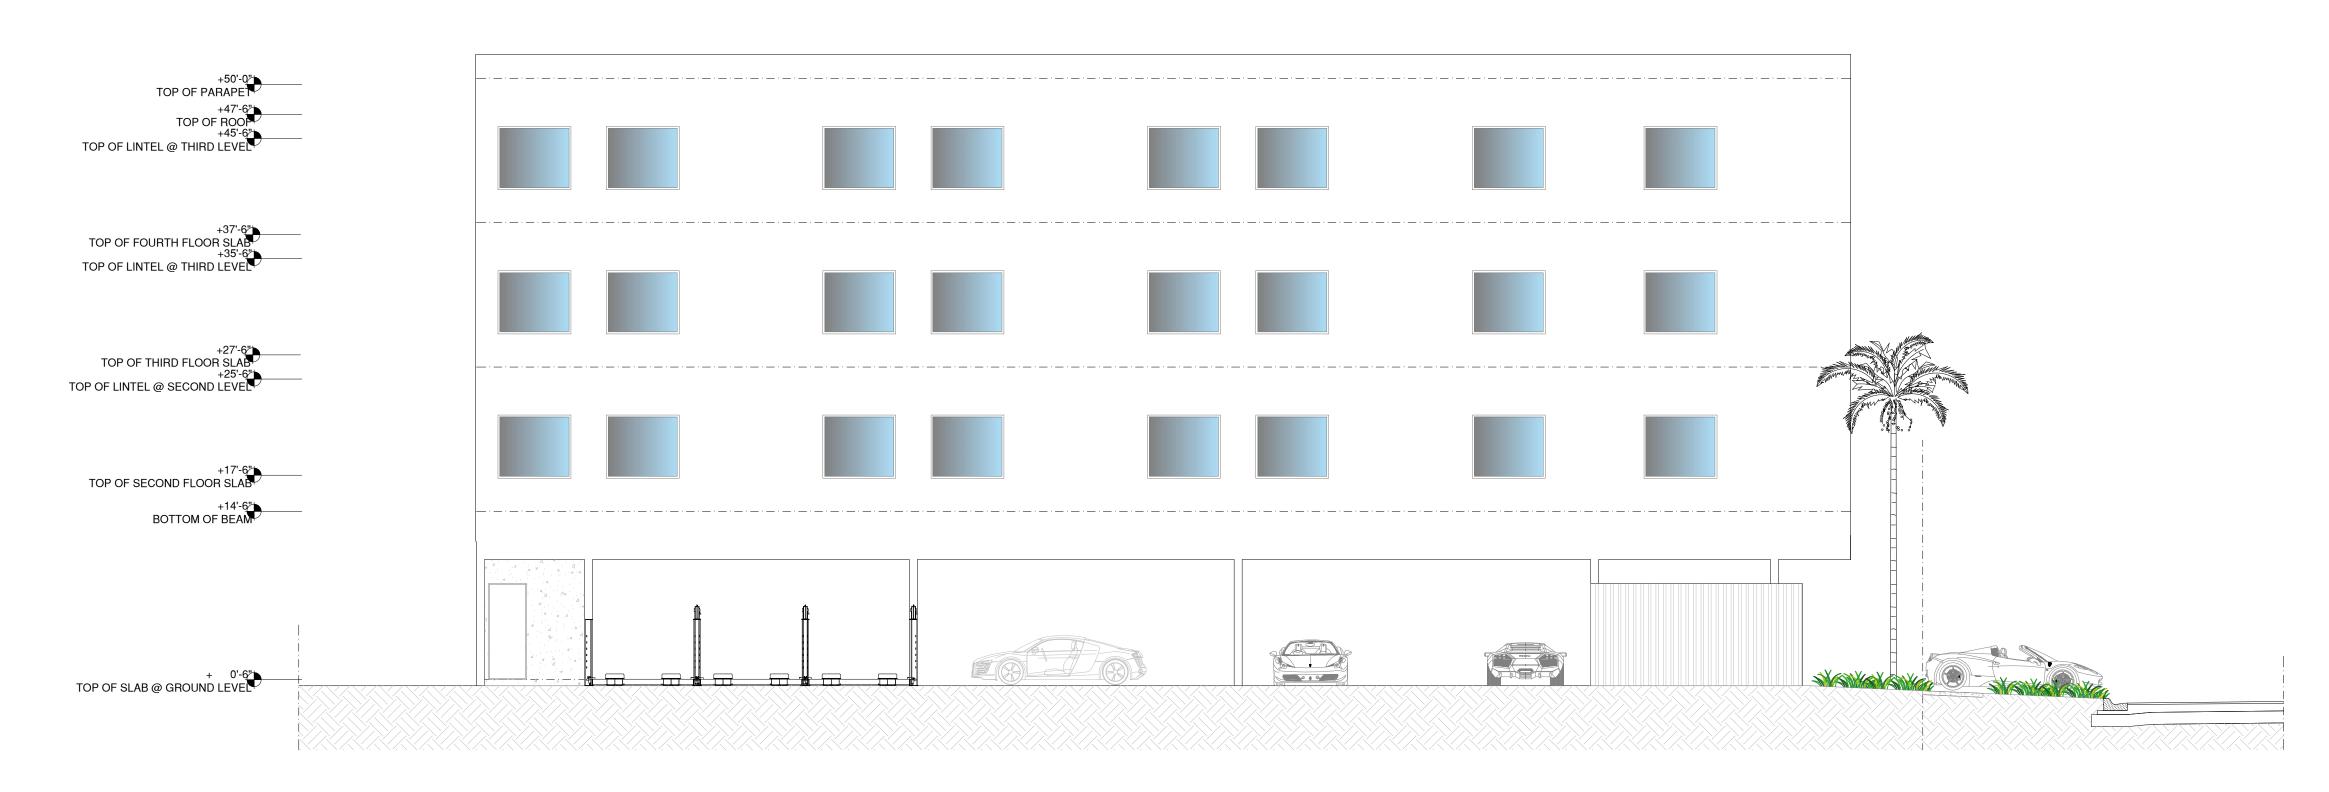
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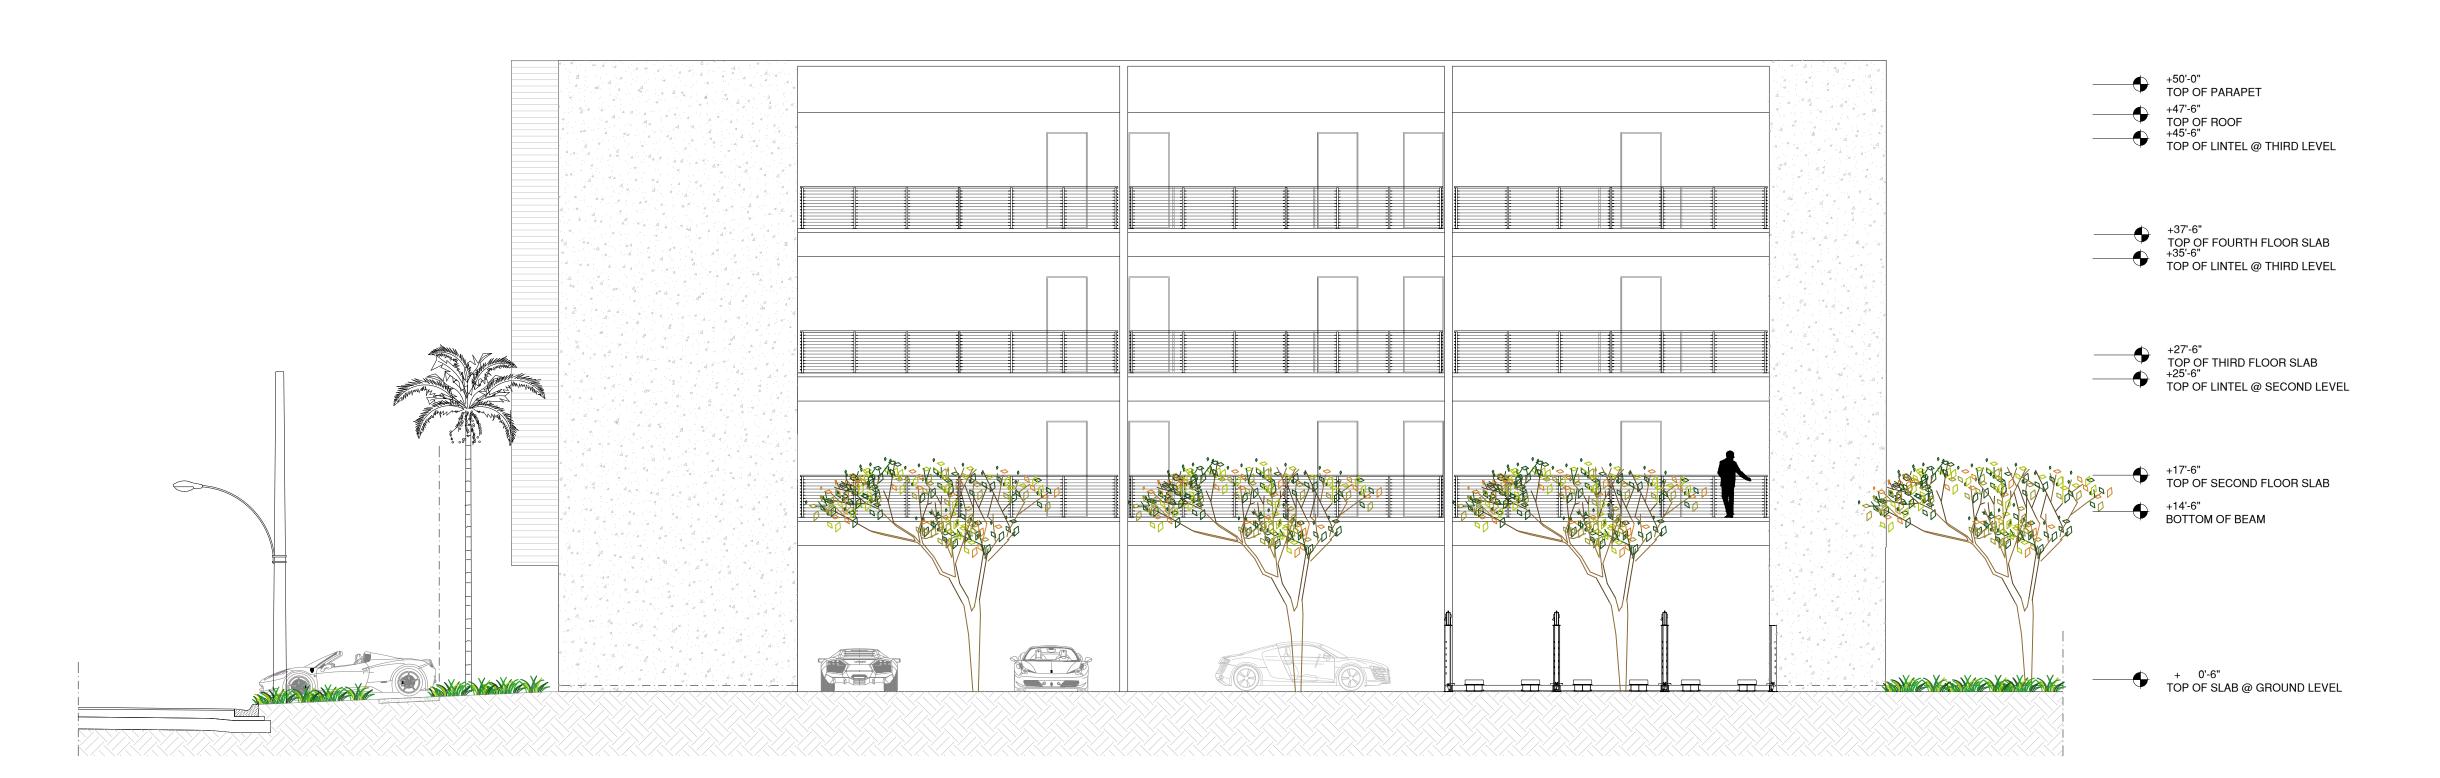
FLOOR PLANS

A-2.3

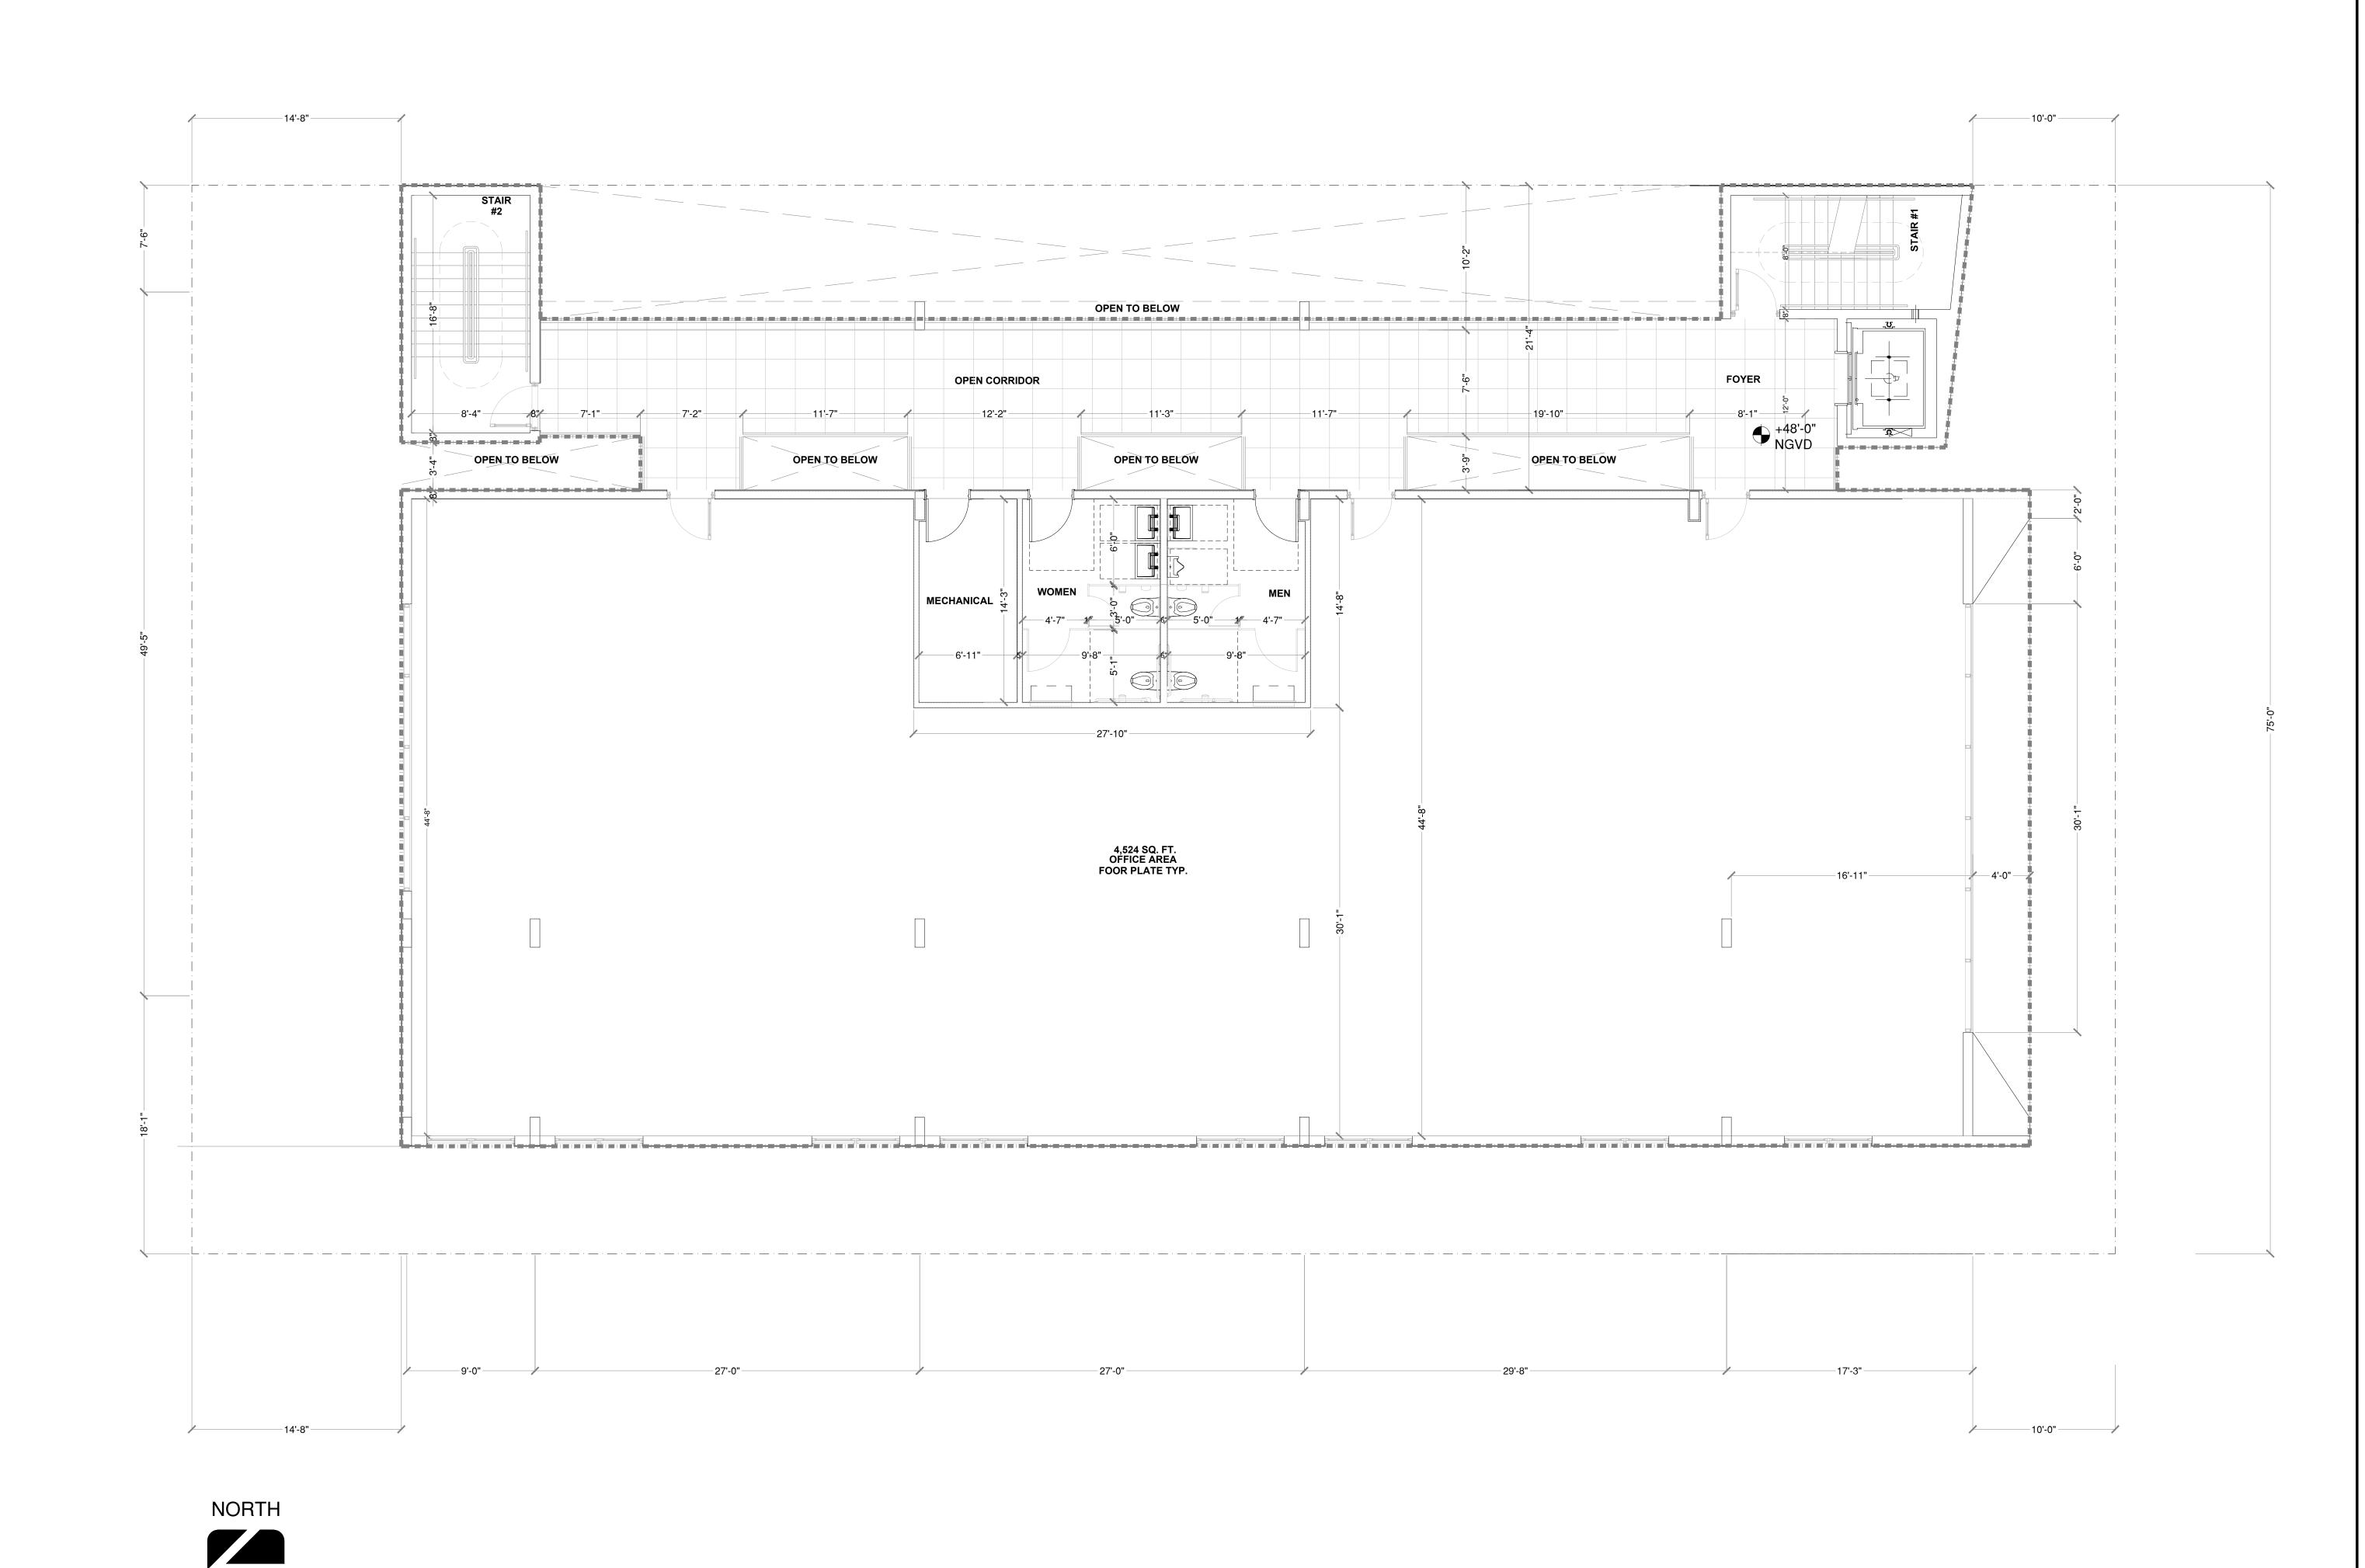FOURTH FLOOR PLAN SCALE 3/16" - 1'-0"



WEST ELEVATION



EAST ELEVATION

PLANA INTERNATION

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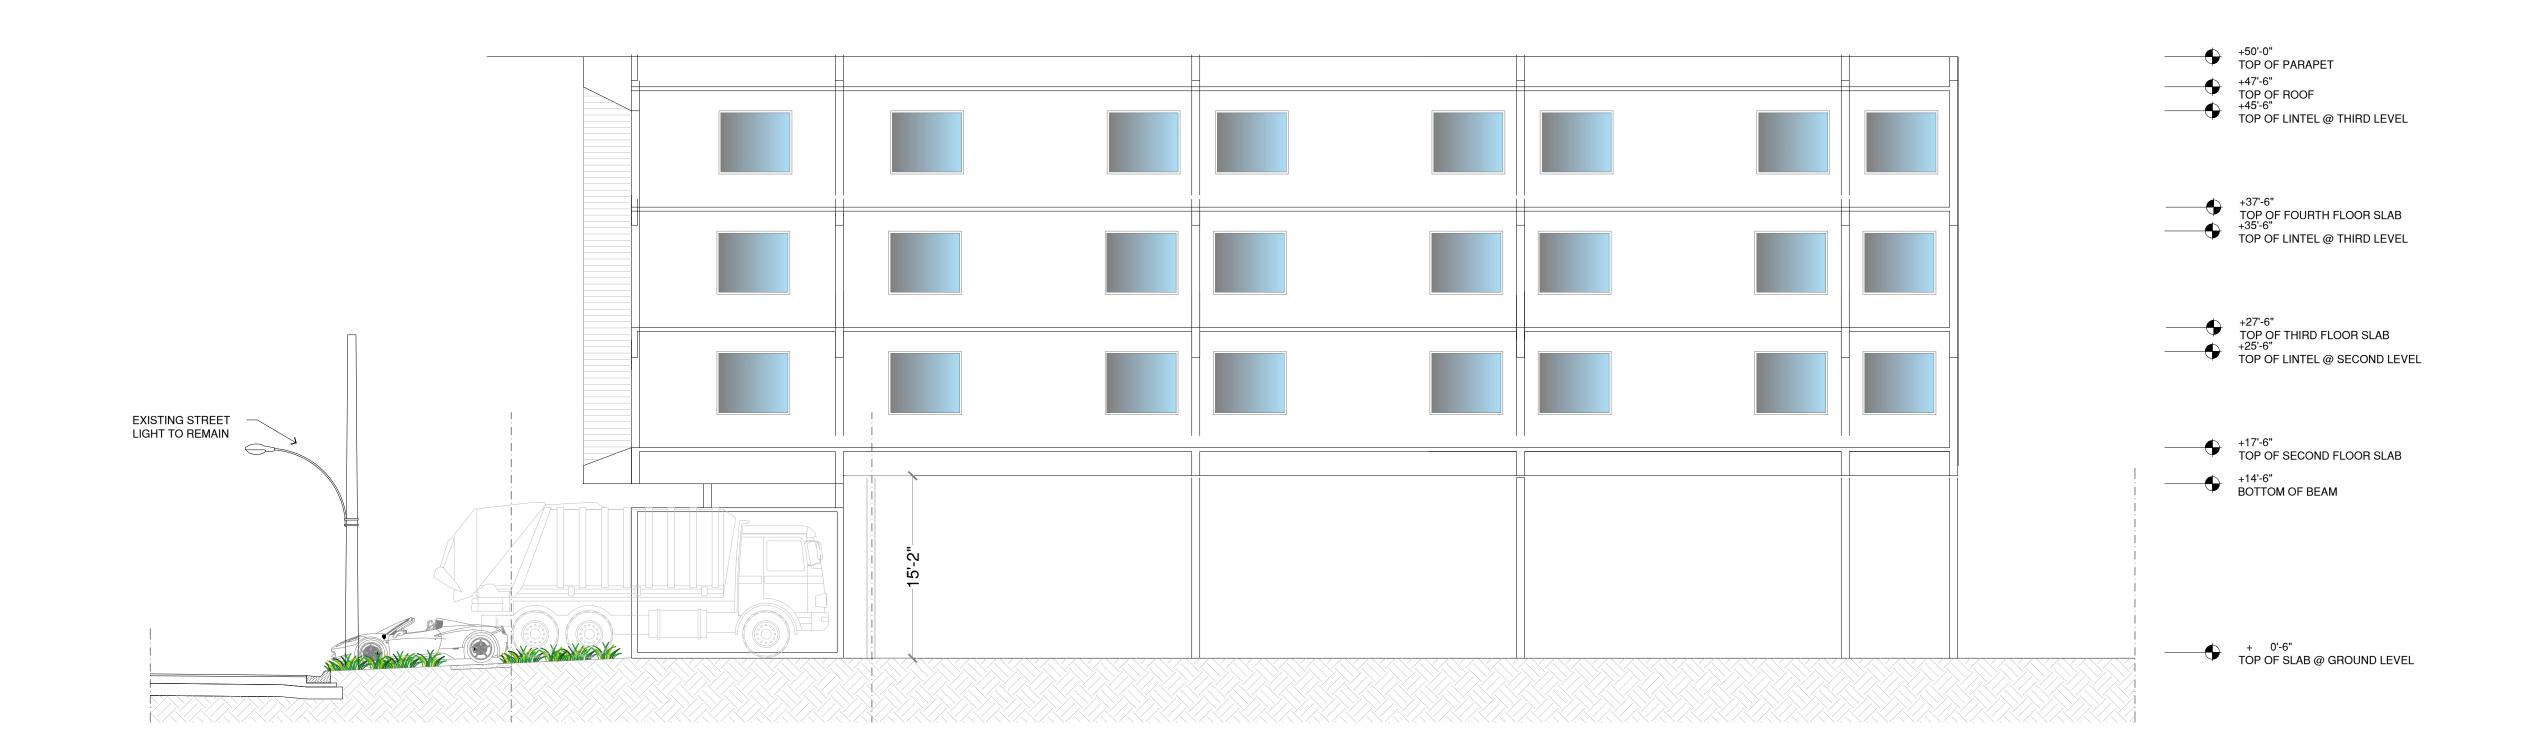
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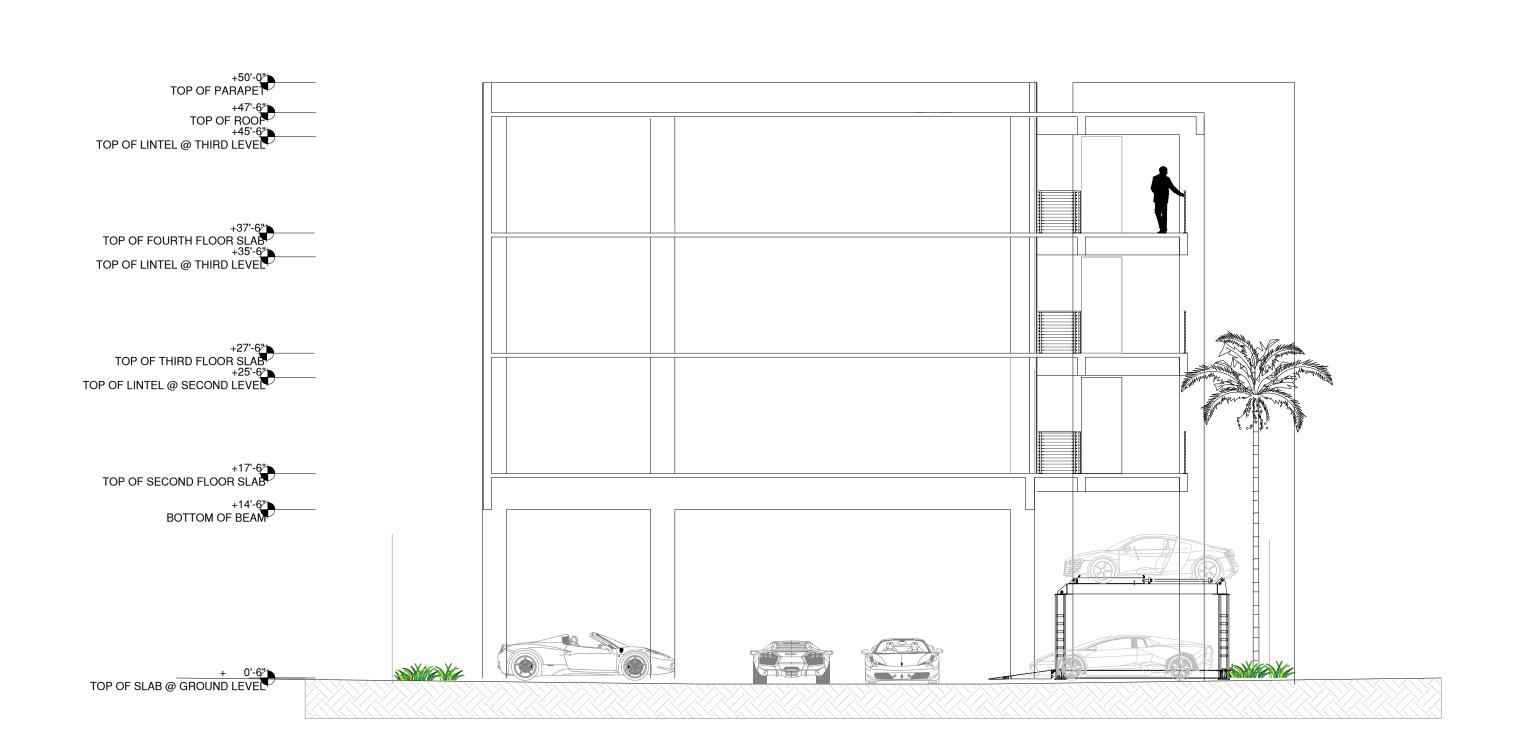
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LONGITUDINAL SECTION





TRANSVERSAL SECTION

PLANA INTERNATIONAL JAIME PLANA ARCHITECT FLORIDA LICENSE AR 9769 1053 SW 12th STREET BOCA RATON, FLORIDA 33486 PHONE: (561) 447-9344 e.FAX (561) 447-4162 E MAIL: archiplan@aol.com CONSTRUKOMUSA 346 CONSERVATION DRIVE WESTON, FLORIDA 33327 PHONE: (954) 999-6085 e.FAX (866) 610-4414 E MAIL: construkomusa@hotmail.com PROJECT No.

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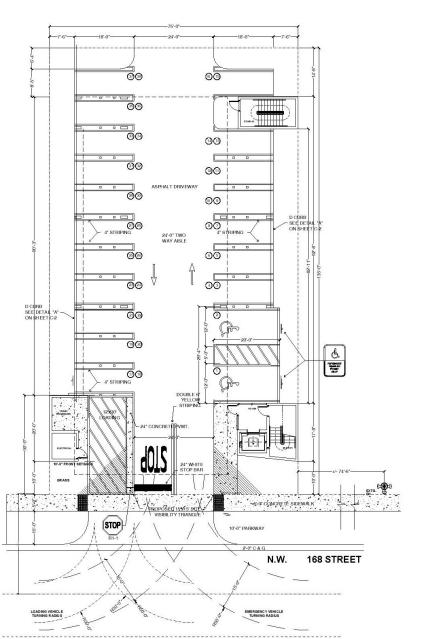
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DRIVEWAY APPROACH CONTRACTOR TO LIFT GRATE OFF AREA DRAINS AND INSTALL FILTER FABRIC ACROSS INLET OPENING, REPLACE GRATE TO HOLD FABRIC SECURELY IN PLACE. 15-FT BY 15-FT DRIVEWAY --15-FT BY 15-FT DRIVEWAY SAFE SIGHT TRIANGLE SAFE SIGHT TRIANGLE GENERAL SEDIMENT AND EROSION CONTROL NOTES - PROPERTY LINE 1. THE CONTRACTOR IS RESPONSIBLE FOR FOLLOWING THE BEST EROSION AND SEDIMENT CONTROL PRACTICES AS OUTLINED IN THE PLANS, SPECIFICATIONS, APPLICABLE PERMIT(S), AND THE PREVENTION, CORRECTION, CONTROL, AND ABATEMENT OF EROSION AND WATER POLLUTION IN ACCORDANCE WITH CHAPTER 63-302, FLORIDA ADMINISTRATIVE CODE. . FILTER FABRIC TO MEET FDOT SIDEWALK _____15'-0"-SIDEWALK 2. EROSION AND SEDIMENT CONTROL BARRIERS SHALL BE PLACED WHERE THERE IS POTENTIAL FOR DOWNSTREAM WATER QUALITY INDEX NO. 199, 280 DEGRADATION; THE CONTRACTOR IS RESPONSIBLE FOR REMOVING THE TEMPORARY EROSION AND SEDIMENT CONTROL DEVICES AFTER COMPLETION SPECIFICATIONS AND FDOT SECTION 985. OF CONSTRUCTION AND ONLY WHEN AREAS HAVE BEEN STABILIZED: AREA DRAIN STRUCTURE . THE CONTRACTOR IS RESPONSIBLE FOR THE MAINTENANCE OF BMPs TO MAKE SURE THEY ARE FUNCTIONING AS DESIGNED AT ALL CONTRACTOR TO REMOVE FILTER FABRIC FROM AREA 5. THE BMP STRUCTURES SHALL BE INSPECTED AFTER EACH RAIN AND REPAIRS MADE AS NEEDED. SEDIMENT DEPOSITS SHOULD BE DRAIN AFTER SOD & PAVER REMOVED AFTER EACH RAINFALL. THEY MUST BE REMOVED WHEN THE LEVEL OF DEPOSITION REACHES APPROXIMATELY ONE-HALF THE HEIGHT OF THE BARRIER; CORRECTLY INSTALLED SILT FENCES WILL BE USED ALONG THE LIMITS OF CONSTRUCTION TO MINIMIZE OFFSITE SILTATION MIGRATION; SAND SET PAVER INSTALLATION. SOD SHALL BE PLACED IN AREAS WHICH MAY REQUIRE IMMEDIATE EROSION PROTECTION TO ENSURE WATER QUALITY STANDARDS ARE MAINTAINED AND WHERE NO ACTIVE CONSTRUCTION IS OCCURRING; THE CONTRACTOR SHALL PAY FOR ANY WATER QUALITY CONTROL VIOLATIONS FROM ANY AGENCY THAT RESULTS IN FINES BEING 15-FT BY 15-FT DRIVEWAY -- 15-FT BY 15-FT DRIVEWAY SAFE SIGHT TRIANGLE SAFE SIGHT TRIANGLE ASSESSED TO THE OWNER BECAUSE OF THE CONTRACTOR'S FAILURE TO ELIMINATE TURBID RUNOFF FROM LEAVING THE SITE AND RAISING BACKGROUND LEVELS OF TURBIDITY ABOVE EXISTING BACKGROUND LEVELS. INLET PROTECTION WRE MESH SHALL BE LAID OVER THE TOP DROP INLET SO THAT THE WIRE EXTENDS A MINIMUM 1 FOOT BEYOND EACH SIDE OF THE 15'-0" INLET STRUCTURE. HARDWARE CLOTH OR COMPARABLE WIRE MESH WITH $\frac{1}{2}$ *-INCH OPENING SHALL BE USED. IF MORE THAN ONE STRIP OF MESH IS NECESSARY THE STRIPS SHALL BE OVERLAPPED; FDOT NO 1. COARSE AGGREGATE SHALL BE PLACED OVER THE WIRE MESH AS INDICATED ON DETAIL. THE DEPTH OF STONE SHALL BE EDGE OF PAVEMENT ROADWAY TEMPORARY CHAIN LINK DETAILS AT LEAST 12 INCHES OVER THE ENTIRE INLET OPENING. THE STONE SHALL BE EXTEND BEYOND THE INLET OPENING AT LEAST 18 INCHES ON ALL SIDES; 3. IF THE STONE FILTER BECOMES CLOGGED WITH SEDIMENT SO THAT IT NO LONGER ADEQUATELY PERFORMS ITS FUNCTION, THE STONE MUST BE PULLED AWAY FROM THE INLET, CLEANED AND REPLACED; 4. THE FILTER BARRIER SHALL BE ENTRENCHED AND BACKFILLED. A TRENCH SHALL BE EXCAVATED AROUND THE INLET AND WIDTH OF A BALE TO A MINIMUM DEPTH OF FOUR INCHES. AFTER THE BALES ARE STACKED, THE EXCAVATED SOIL SHALL BE BACKFILLED AND COMPACTED AGAINST THE FILTER BARRIER; 5. BALE SHALL BE EITHER WIRE-BOUND OR STRING-TIED WITH THE BINDINGS ORIENTED AROUND THE SIDES RATHER THAN OVER AND POLLUTION PREVENTION FOR AREA RAIN 6. BALES SHALL BE PLACED LENGTHWISE IN SINGLE ROW SURROUNDING THE INLET WITH THE ENDS OF ADJACENT BALES PRESSED TOGETHER; 7. EACH BALE SHALL BE SECURELY ANCHORED AND HELD IN PLACE BY AT LEAST TWO STAKES OR REBARS DRIVEN THROUGH THE BALE; N.T.S. 8. LOOSE STRAW SHOULD BE WEDGED BETWEEN BALES TO PREVENT WATER FROM ENTERING BETWEEN BALES. 12 1/2 ga.-FABRIC WIRE TURBIDITY BARRIERS -STEEL TUBE FLOATING TURBIDITY BARRIERS WILL BE PLACED AT ALL OUTFALL LOCATIONS CONNECTED TO THE WORK AREA DURING ACTIVE CONSTRUCTION. IF SEAGRASSES ARE PRESENT BARRIERS WILL NOT BE PLACED OVER THEM. THE FLOATING TURBIDITY BARRIERS SHALL BE INSTALLED IN A MANNER TO PREVENT MANATEE ENTANGLEMENT; STEEL TUBE-Ø1 3/8" x 14 ga. WALL AND/OR CHAIN Ø1 3/8" x 14 ga. TURBIDITY BARRIERS TO BE MARKED WITH SITE CONTRACTOR'S COMPANY NAME USING PERMANENT MARKINGS NO SMALLER THAN 3 LINK FENCE PROPERTY LINE 15-FT BY 15-FT DRIVEWAY - 15-FT BY 15-FT DRIVEWAY SAFE SIGHT TRIANGLE SAFE SIGHT TRIANGLE POST OPTIONS WOOD 2-1/2" MIN. Ø WOOD 2" X 4" OAK 1 STEEL TUBE-1" X 1-1/2" STEEL Ø3/4" x 14 ga. 1,33 LBS/FT. MIN -FILTER FABRIC (IN CONFORMANCE WITH SEC. 985 FDOT SPEC.) VERT. INSERTS 15'-0" EDGE OF PAVEMENT ELEVATION -STEEL TUBE ROADWAY Ø1 3/8" x 14 ga. STEEL TUBE-STAND Ø1 3/8" x 14 ga. -STEEL TUBE GRADE N.T.S. DRIVEWAY SAFE SIGHT TRIANGLE Ø3/4" x 14 ga. STAND THE HEIGHT OF FENCES, WALLS, BUS SHELTERS AND HEDGES SHALL NOT EXCEED 2 FEET IN HEIGHT WITHIN FIFTEEN (15) FEET OF THE EDGE OF DRIVEWAY LEADING TO A PUBLIC RIGHT-OF-WAY. THE SAFE SIGHT DISTANCE TRIANGLE AREA SHALL NOT CONTAIN OBSTRUCTIONS SAND BAG TO CROSS-VISIBILITY AT A HEIGHT BETWEEN 2 FEET AND 6 FEET ABOVE PAVEMENT, Ø1 3/8" x 14 ga. POTENTIAL OBSTRUCTIONS INCLUDE, BUT ARE NOT LIMITED TO STRUCTURES, TYPE III SILT FENCE STAND GRASS, GROUND COVERS, SHRUBS, VINES, HEDGES, TREES, ROCKS, WALLS AND N.T.S. FENCES. STAND PLAN VIEW STAND ELEVATION

PLANA INTERNATIONAL JAIME PLANA ARCHITECT FLORIDA LICENSE AR 9769 1053 SW 12th STREET BOCA RATON, FLORIDA 33486 PHONE: (561) 447-9344 e.FAX (561) 447-4162 E MAIL: archiplan@aol.com **CONSTRUKOMUSA** 346 CONSERVATION DRIVE WESTON, FLORIDA 33327 PHONE: (954) 999-6085 e.FAX (866) 610-4414 E MAIL: construkomusa@hotmail.com PROJECT No. DRAWN BY: FOLIO #: 07-2113-007-0480 CAD FILE: 12-10-2020 MARK DATE DESCRIPTION A.B. AS-BUILT R.A.P. REVISION AFTER PERMIT B.D.C. BUILDING DEPT. COMMENTS COORDINATION CHANGES PERMIT SET P.S. DESIGN DEVELOPMENT D.D. PUBLIC HEARING P.H. / plot date: 12-10-2020 SHEET TITLE

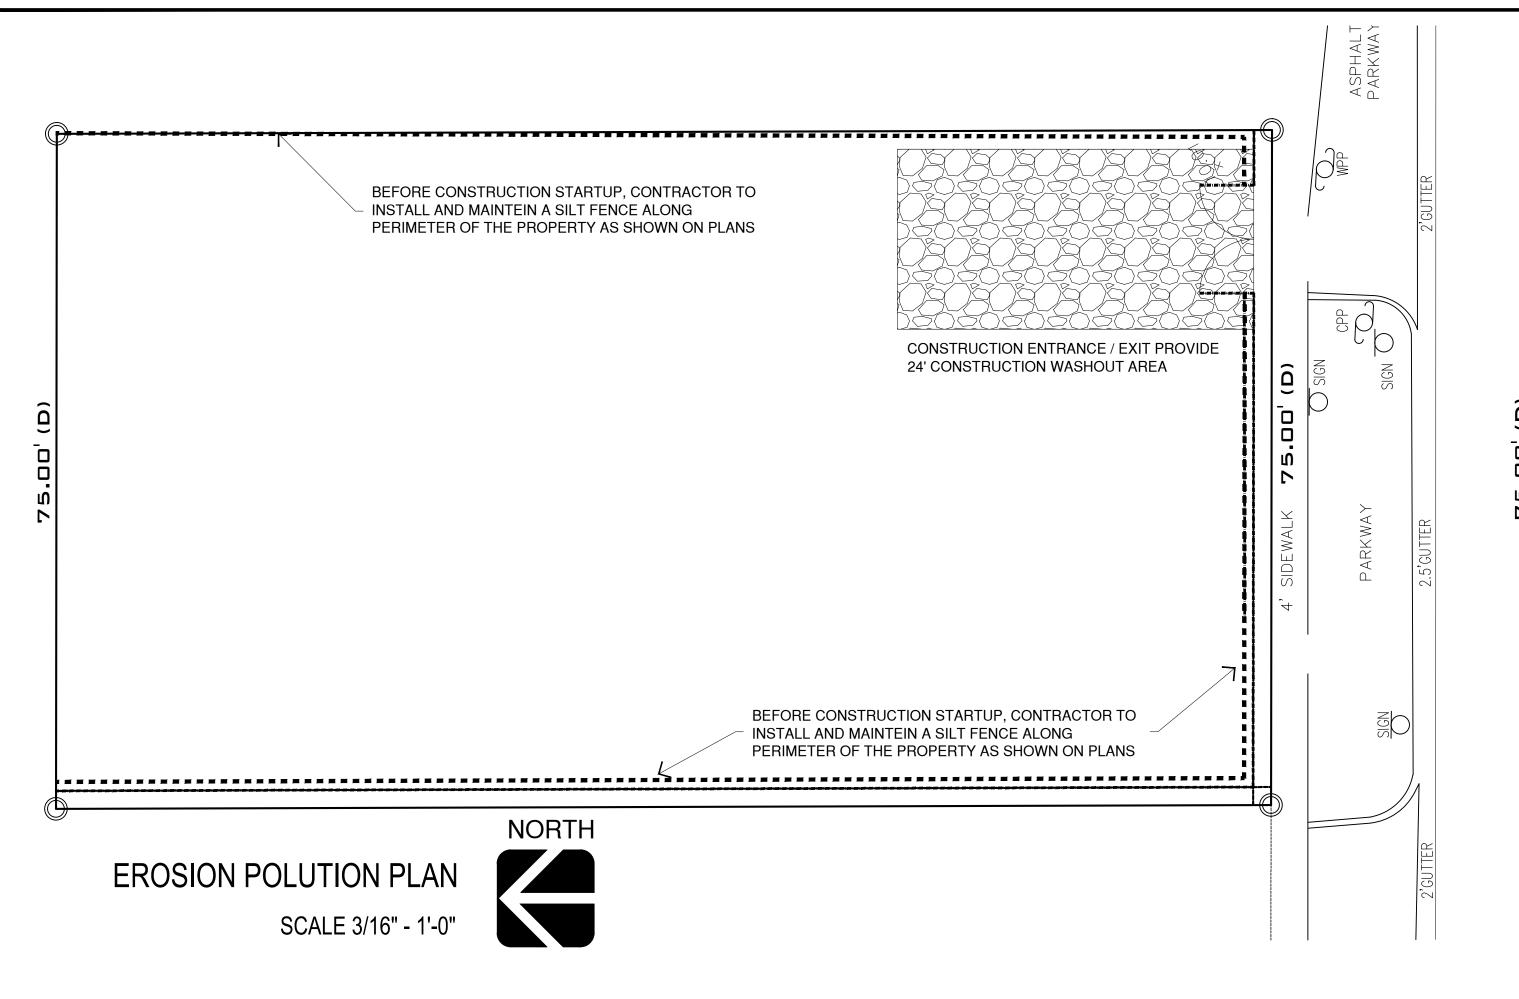

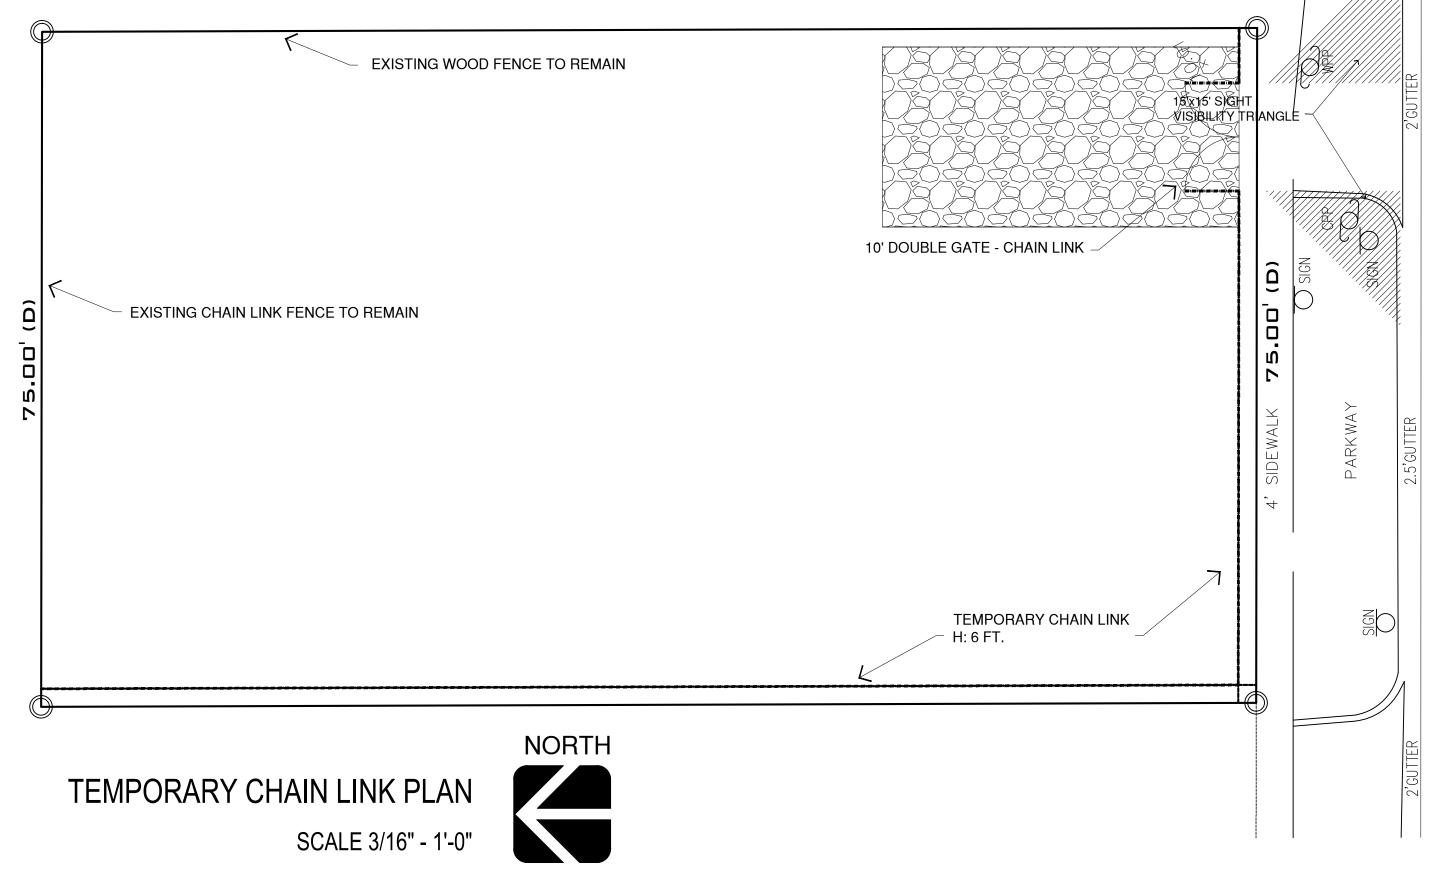Digitally signed by Rahimuddin Rahimi No. Bidded

★ ★ Date:

STATE OF #2021.10.07

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DATE: DESCRIPTION
9/16/21 CITY COMMENTS REVISIONS:

MR ENGINEERING CONSULTANTS INC

STRUCTURAL, CIVIL, GEOTECHNICAL, ENVIRONMENTAL ENGINEERS 10031 PINES BLVD SUITE 23, PEMBEGGE PINES, FLORIDA 33024 P (9 5 4) 3 6 4 - 8 3 5 5 F (9 5 4) 4 3 2 - 9 2 6 6

11 NW 168 STREET NORTH MIAMI BEACH, FLORIDA 33169 PROPOSED PAVING & STRIPING MEDICAL OFFICE BUILDING

DRAWN BY: B.J. DATE: 10/7/21

PROJECT NO:83 DRAWING NO.


SYMBOL LEGEND:



STOP SIGN PARKING BY DISABLED PERMIT ONLY

PAVING AND STRIPING PLAN SCALE 1/8" - 1'-0"



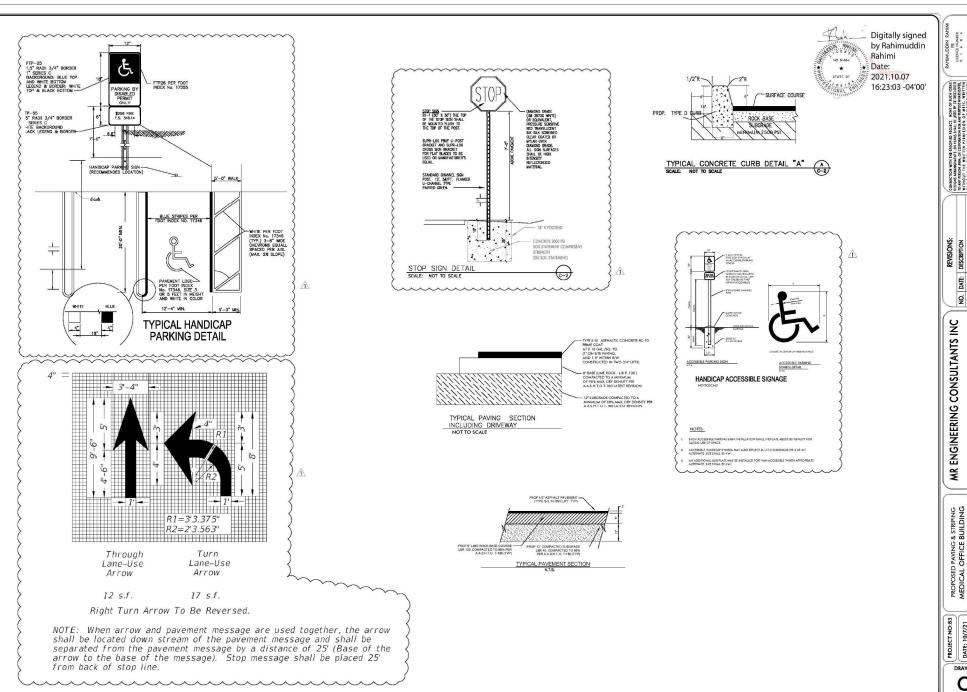


REVISIONS: DESCRIPTION CITY COMMENTS DATE: 9/16/21

STRUCTURAL, CIVIL, GEOTECHHICAL, BIVIRONMENTAL ENGINEERS 50924 10031 PHIES BLVO SUITE 237, PEMBROKE PHIES, FLORIDA 33024 P (954) 432-9266

11 NW 168 STREET NORTH MIAMI BEACH, FLORIDA 33169

DRAWN BY: B.J.
CHECKED:
R.R.

DATE: 10/7/21 DRAWING NO.

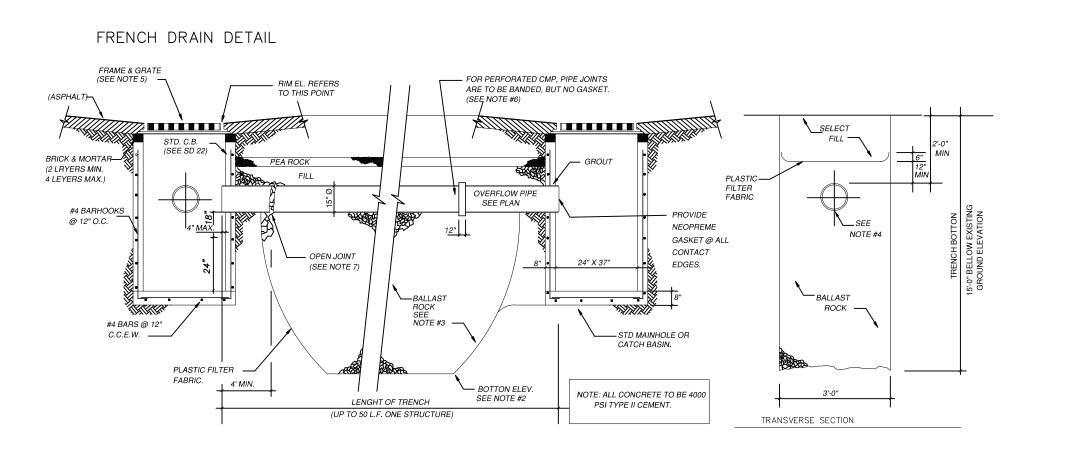

DRAINAGE GENERAL NOTES

1. AFTER THE BALLAST ROCK HAS BEEN PLACED TO THE PROPER ELEVATION IT SHALL BE CAREFULLY WASHED DOWN WITH CLEAN WATER IN ORDER TO ALLOW INITIAL SETTLEMENT THAT MAY OCCUR. IF IT DOES TAKE PLACE, ADDITIONAL BALLAST ROCK WILL BE ADDED TO RESTORE THE BALLAST ROCK TO PROPER ELEVATION, SO THAT THE EXFIL TRATION TRENCH BE COMPLETED IN ACCORDANCE WITH THE DETAILS.

2. PLASTIC FILTER FABRIC SHALL BE WOVEN MONOFILAMENT POLYPROPYLENE GEOTEXTILE. PERMITTIVITY SHALL BE GREATER THAN 0.50 SEC-1 AND FLOW RATE GREATER OR EQUAL TO 50 GAL/MIN. 3. THE CONTRACTOR SHALL TAKE THE NECESSARY PRECAUTIONS TO PREVENT CONTAMINATION OF THE TRENCH WITH SAND, SILT, AND 4. ANY DAMAGE CAUSED WITHIN THE SITE OR TO ADJOINING PROPERTIES DURING CONSTRUCTION MUST BE 4. AND DAWNED AND THE GENERAL CONTRACTOR.

5. THE GENERAL CONTRACTOR SHALL CALL IN A LOCATION REQUEST TO SUNSHINE STATE ONE CALL OF FLORIDA, INC. 6. THE CONTRACTOR IS RESPONSIBLE FOR VERIFYING THE NATURE, SIZE, AND LOCATION OF ALL EXISTING UTILITIES PRIOR TO

- THE FOLLOWING UTILITY COMPANIES SHOULD BE NOTIFIED 48 HOURS IN ADVANCE OF EXCAVATION IN AREA. FLORIDA POWER AND LIGHT CO. BELL SOUTH/AT&T
- MIAMI DADE WATER AND SEWER DEPT. COMCAST
- MIAMI-DADE COUNTY PUBLIC WORKS DEPT. CITY OF NORTH MIAMI BEACH PUBLIC WORKS DEPT.
- SUNSHINE STATE ONE CALL OF FLORIDA, INC. I ALL MATERIAL SHOULD BE D.I.P. EXCEPT SERVICES. IF EVIDENCE OF POTENTIAL CONTAMINATION IS DETECTED DURING EXCAVATION, STOP EXCAVATION WORK AND NOTIFY
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 WASD ENVIRONMENTAL, HEALTH AND SAFETY SECTION AT (786)552-8579 AND THE
 CONSTRUCTION CONTRACT MANAGEMENT DIVISION AT (786)552-8252. EVIDENCE OF POTENTIAL CONTAMINATION
 MAY INCLUDE ANY OF THE FOLLOWING: 1. ODOR 2. SOLID WASTE DEBRIS 3. SHEEN ON THE GROUNDWATER 4.
 STAINED OR SATURATED SOIL (SOIL THAT CONTAINS PRODUCT THAT DRAINS WHEN IT IS HANDLED OR CREATES STREAKS ON EXCAVATION TOOLS) OR
 FREE FLOATING PRODUCT ON THE GROUNDWATER (OIL, DIESEL, GASOLINE, ETC.). MATERIAL THAT HAS ODOR, IS STAINED OR
 IS SATURATED MUST BE SEGREGATED ON AN IMPERMEABLE SURFACE FOR APPROPIATE FUTURE DISPOSAL.
- ALL WATER MAIN PIPE AND FITTINGS INSTALLED UNDER THIS PROJECT MUST BECOLOR CODED WITH
 BLUE PAINT AS STATED IN THE FLORIDA ADMINISTRATIVE CODE, SUBPARAGRAPH 62-555.320(21) (B)3 AND AS
 REQUIRED BY THE FLORIDA DEPARTMENT OF ENVIRONMENTAL PROTECTION. IF PAINT IS APPLIED DURING INSTALLATION OF THE PIPE, THE PAINT SHALL
 BE APPLIED IN A CONTINUOUS LINETHAT RUNS PARALLEL TO THE AXIS OF THE PIPE AND THAT IS LOCATED ON THE TOP OF THE PIPE.

FULL ENCASEMENT

LONGITUDINAL SECTION

* NO SLOTS OR PERFORATIONS ON THIS LENGHT OF PIPE.


NOTE: IF THIS DETAIL IS TO BE USED FOR PRETREATMENT OF STORMWATER RUN-OFF, THE INVERT OF PIPE TO BE AS SHOWN IN W.C. 2.2, IF PRETEATMENT HAS BEEN PROVIDED THRU OTHER. MEANS THE INVERT OF PIPE CAN BE LOWER THAN SHOWN IN W.C. 2.2

1- PLASTIC FILTER FABRIC (AT EACH SIDE) SHALL BE USED IN SANDY AREAS AS NOTED

- ON PLANS AND/OR AS DIRECTED BY THE ENGINEER. 2- THE BOTTON OF THE EXFILTRATION TRENCH SHALL BE 15'-0" BELLOW EXISTING GROUND ELEVATION, UNLESS FIELD CONDITION WARRANT OTHERWISE.
- 3- AFTER THE BALLAST ROCK HAS BEEN PLACED TO THE PROPER ELEVATION, IT SHALL BE CAREFULLY WASHED DOWN WITH CLEAN WATER IN ORDER TO ALLOW FOR INITIAL SETTLEMENT THAT MAY OCCUR. IF IT DOES TAKE PLACE ADDITIONAL BALLAST ROCK WILL BE ADDED TO RESTORE THE
- TRENCH BE COMPLETED IN ACCORDANCE WITH THE DETAILS. 4- INVERT ELEVATION TO BE AS SHOWN IN W.C. 3.0. (AVG. OCTOBER GROUND WATER LRVEL) + 4'-0" 5- FRAME AND GRATE: USF 4155-6210 OR EQUAL MIN. WEIGT 240 LB. TOTAL WEIGTH 575 LB.
- 6- PIPE SHALL BE PERFORATED CORRUGATED ALUMINUM.

BALLAST ROCK TO THE PROPER ELEVATION SO THAT THE EXFILTRATION

7- PIPES SHALL TERMINATE 2 FEET FROM END OF TRENCH OR CONNECTED TO ADDITIONAL CATCH BASIN AS REQUIRED.

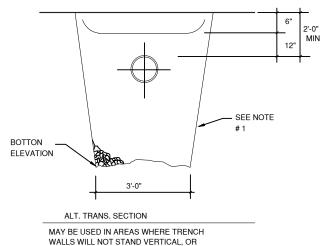


WHERE CAVE IN BELLOW THE WATER

USED AT THE ENGINEER'S DISCRETION.

TABLE IS LIKELY TO OCCUR. TO BE

CONCRETE ANCHORS

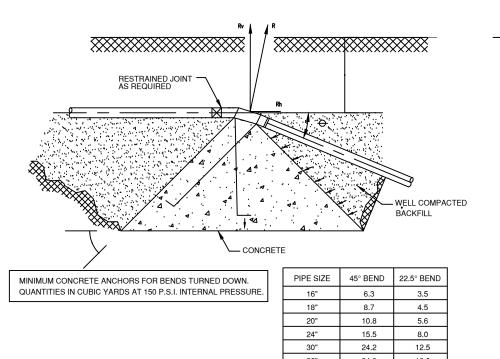


1. QUANTITIES ARE GIVEN FOR CONCRETE ANCHORS IN DRY SOIL. 2. ANCHOR RODS TO BE MINIMUM #6 EPOXY COATED STEEL REINFORCING BAR AND MORTAR COATED AFTER INSTALLATION. 3. QUANTITIES OF CONCRETE ANCHORS TO BE USED BELOW THE GROUND WATER TABLE SHALL BE CALCULATED BY MULTIPLYING ABOVE VALUES WITH 1.76. 4. VERTICAL BENDS TURNED UP SHALL BE ANCHORED WITH THE SAME SIZE ANCHORS AS SPECIFIED FOR HORIZONTAL BENDS. 5. WEIGHT OF PIPE, WATER, WEIGHT OF SOIL ABOVE ANCHORS AND RESTRAINED PIPE LENGTH, MAY BE

6. WHERE FIELD CONDITIONS WARRANT - ANCHORS MAY BE REQUIRED ON 6" TO 12" PIPE


CONSIDERED TO DECREASE VOLUME OF CONCRETE BLOCK.

TYPICAL TRENCH BACKFILL

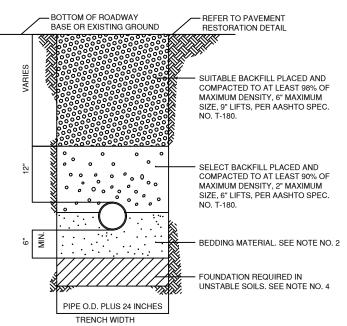

1. FOR EXCAVATION AND BACKFILL AROUND MANHOLES, APPURTENANCES, OR IN WATER, REFER TO PROVISIONS WITHIN THE SPECIFICATIONS. 2. UNLESS OTHERWISE SPECIFIED, BEDDING MATERIAL SHALL CONSIST OF SELECT BACKFILL MATERIAL 2" MAX. SIZE, OR WASHED AND GRADED LIMEROCK (3/8" - 7/8"), COMPACTED TO AT LEAST 90% OF MAX. DENSITY, 6" LIFTS, PER AASHTO SPEC. NO. T-180. 3. WHERE REQUIRED, SHEETING AND SHORING SHALL BE IN ACCORDANCE WITH SPECIFICATION. 4. WHERE UNSTABLE SOILS ARE ENCOUNTERED, INCLUDING PEAT, MUCK OR OTHER ORGANIC SOILS, ELASTIC SILT AND CLAYS, A FOUNDATION IS REQUIRED, COMPACTED TO AT LEAST 90% OF MAX. DENSITY, 6" LIFTS PER AASHTO SPEC. NO. T-180. FOUNDATION MATERIAL SHALL BE SELECT BACKFILL MATERIAL, 2" MAXIMUM SIZE, 6" LIFTS. EXTEND EXCAVATION UNTIL A SUITABLE MATERIAL IS FOUND. 5. IN A LOW PRESSURE SEWER SYSTEM USE SAND OR 1/4" RICE ROCK FOR SELECT BEDDING AND 12" SELECT BACKFILL MATERIAL AS SHOWN ABOVE. MINIMUM 36" OF COVER.


CONCRETE ARCH

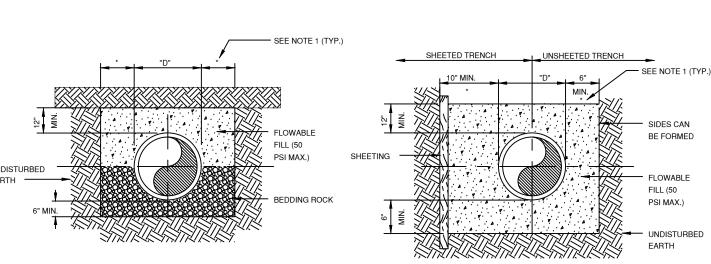


1. (*): 15" MAX. FOR PIPE DIAMETER LESS THAN 24", AND 24" MAX. FOR PIPE DIA. 24" AND OVER. 2. "D" REFERS TO THE DIAMETER OF THE PIPE. T' REFERS TO THE THICKNESS OF THE PIPE.

USE OF CONCRETE ARCH HALF ENCASEMENT OR FULL ENCASEMENT TO BE DETERMINED IN THE FIELD AS 5. REFER TO SECTION 2.18-E OF THE UTILITY AND ENGINEERING STANDARDS MANUAL FOR SHEETING AND BRACING IN EXCAVATIONS.

CRADLE OR HALF ENCASEMENT

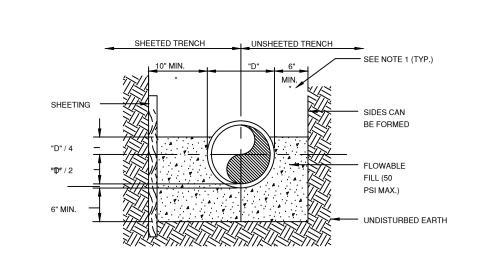

TYPICAL WATER SERVICE CONNECTION

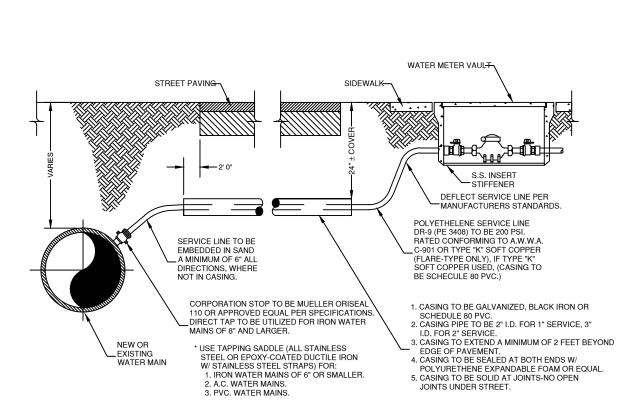


1. POI YETHELENE SERVICE LINE TO BE CONTINUOUS FROM CORPORATION STOP TO METER, NO COUPLINGS ARE PERMITTED.

2. KINKED OR CRIMPED PIPE AND OR TUBING SHALL BE REJECTED.

3. SERVICE LINES SHALL BE 3' COVER IN STATE D.O.T. RIGHTS-OF-WAY CONTINUOUSLY TO METER BOX. (SEE DETAIL No. WM-1A). 4. SERVICES SHALL HAVE 2' COVER IN TRAFFIC AREA AND 18" COVER IN NON-TRAFFIC AREA (CITY MBB & MIAMI-DADE CTY. RIGHTS-OF-WAY).

5. WRAP NON-METALLIC SERVICE LINE WITH 10 GAUGE COPPER WIRE OR METALLIC DETECTOR TAPE.


TYPICAL 3/4" TO 2" REDUCED PRESSURE BACKFLOW ASSEMBLY INSTALLATION

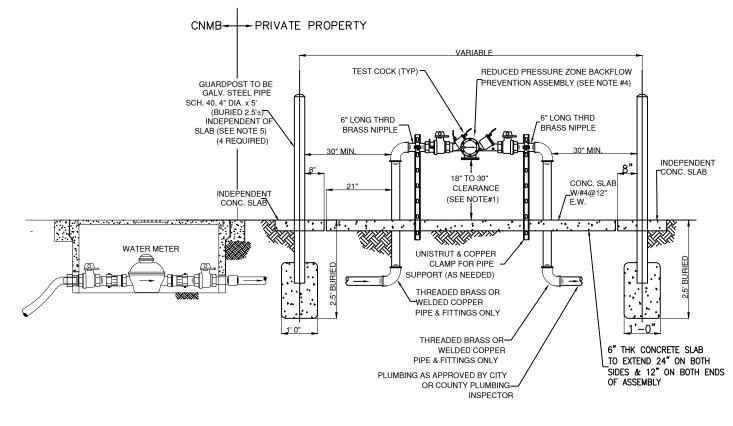

THE ASSEMBLY MUST BE INSTALLED WITH MINIMUM HORIZONTAL CLEARANCE OF 18" MINIMUM TO 30" MAXIMUM, FREE FROM OBSTRUCTIONS IN ALL DIRECTIONS.

- 2. THE BACKFLOW PREVENTION ASSEMBLY SHALL BE ON THE APPROVED LIST OF FOUNDATION FOR CROSS CONNECTION AND HYDRAULIC RESEARCH CONTROL OF THE UNIVERSITY OF SOUTHERN CALIFORNIA. CONTRACTOR TO PROVIDE MANUFACTURERS CERTIFICATION OF U.S.C. APPROVAL.
- 3. ALL BACKFLOW PREVENTION ASSEMBLIES 3" AND SMALLER SHALL BE FACTORY ASSEMBLED INCLUDING SHUT OFF VALVE AS REQUIRED BY U.S.C. FOUNDATION FOR CROSS CONNECTION CONTROL STANDARDS. ON DEVICES. 4. BACKFLOW PREVENTION ASSEMBLIES SHALL BE INSTALLED IN AN ACCESSIBLE LOCATION APPROVED BY CITY OF NORTH MIAMI BEACH PUBLIC UTILITIES. ${\tt LOCATIONS\ INSIDE\ BUILDING\ OR\ WITH\ OTHERWISE\ RESTRICTED\ ACCESS\ WILL\ NOT\ BE\ APPROVED.}$
- 5. GUARDPOSTS OR PROTECTIVE ENCLOSURE MAY BE REQUIRED DEPENDING ON SITE CONDITIONS. 6. INSTALL PIPE SUPPORTS AS NEEDED.
- 7. ALL PIPE AND FITTINGS 2" AND SMALLER SHALL BE BRASS OR COPPER. 8. ALL EXPOSED METALLIC THREADS SHALL BE PAINTED WITH BITUMASTIC PAINT. ALL OUTLETS SHALL BE PLUGGED WITH BRASS.

TYPICAL 1 1/2 " & 2" SERVICE & METER INSTALLATION

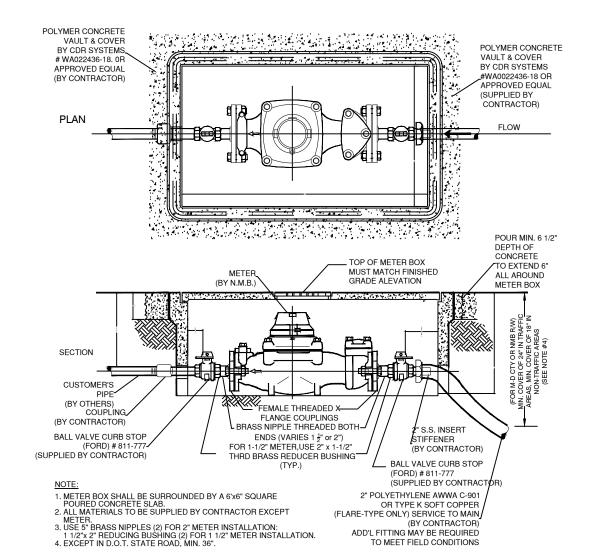

REQUIREMENTS PER DEPARTMENT OF HEALTH

WATER MAIN HORIZONTAL SEPERATIONS 1. Separations shall be measured outside edge to outside

 Between water mains and, storm sewers, storm water or reclaimed water lines, SHALL be 3 ft. minimum.

3. Between water mains and vacuum type sewer preferably 10 ft, and at least 3 ft, minimum. mains or reclaimed water preferably 10 ft. and at least 6 ft. MAY be reduced to 3 ft. Where bottom of water main is at least 6 inches above top of sewer. 5. 10ft. of any part of on-site sewer treatment or disposal

WATER MAIN VERTICAL SEPARATIONS

1. Separations between water mains and gravity sewer, vacuum type sewer, or storm sewers to be preferably 12 inches, or at least 6 inches above, or at least 12 inches if below. 2. Pressure sanitary sewer, wastewater or storm water force main, or reclaimed water, at least 12 inches above or below.

* Note: Center 1 - full length of water main pipe at crossings, alternatively arrange pipes so joints are at least 3 feet from joints in vacuum, storm or At least 6 feet from joints in gravity of pressure sewers, wastewater force mains or reclaimed water.

TRENCH PROTECTION

required by the provisions of Part 1926, Subpart P, Excavations, Trenching and Shoring of the Occupational Safety and Health Administrations Standards and Interpretations

PLANA INTERNATIONA


IAIME PLANA ARCHITECT FLORIDA LICENSE AR 9769

1053 SW 12th STREET

BOCA RATON, FLORIDA 33486 PHONE: (561) 447-9344 e.FAX (561) 447-4162 E MAIL: archiplan@aol.com


CONSTRUKOMUSA

346 CONSERVATION DRIVE WESTON, FLORIDA 33327 PHONE: (954) 999-6085 e.FAX (866) 610-4414 E MAIL: construkomusa@hotmail.com

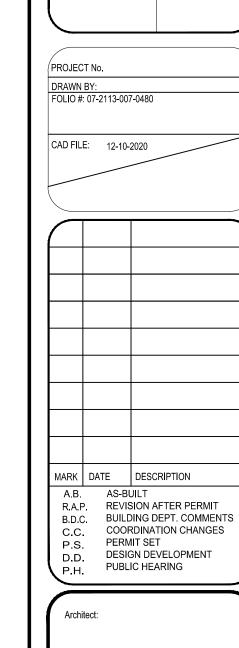

JAIME PLANA

/ plot date: 12-10-2020 SHEET TITLE **ENGINEERING DETAILS**

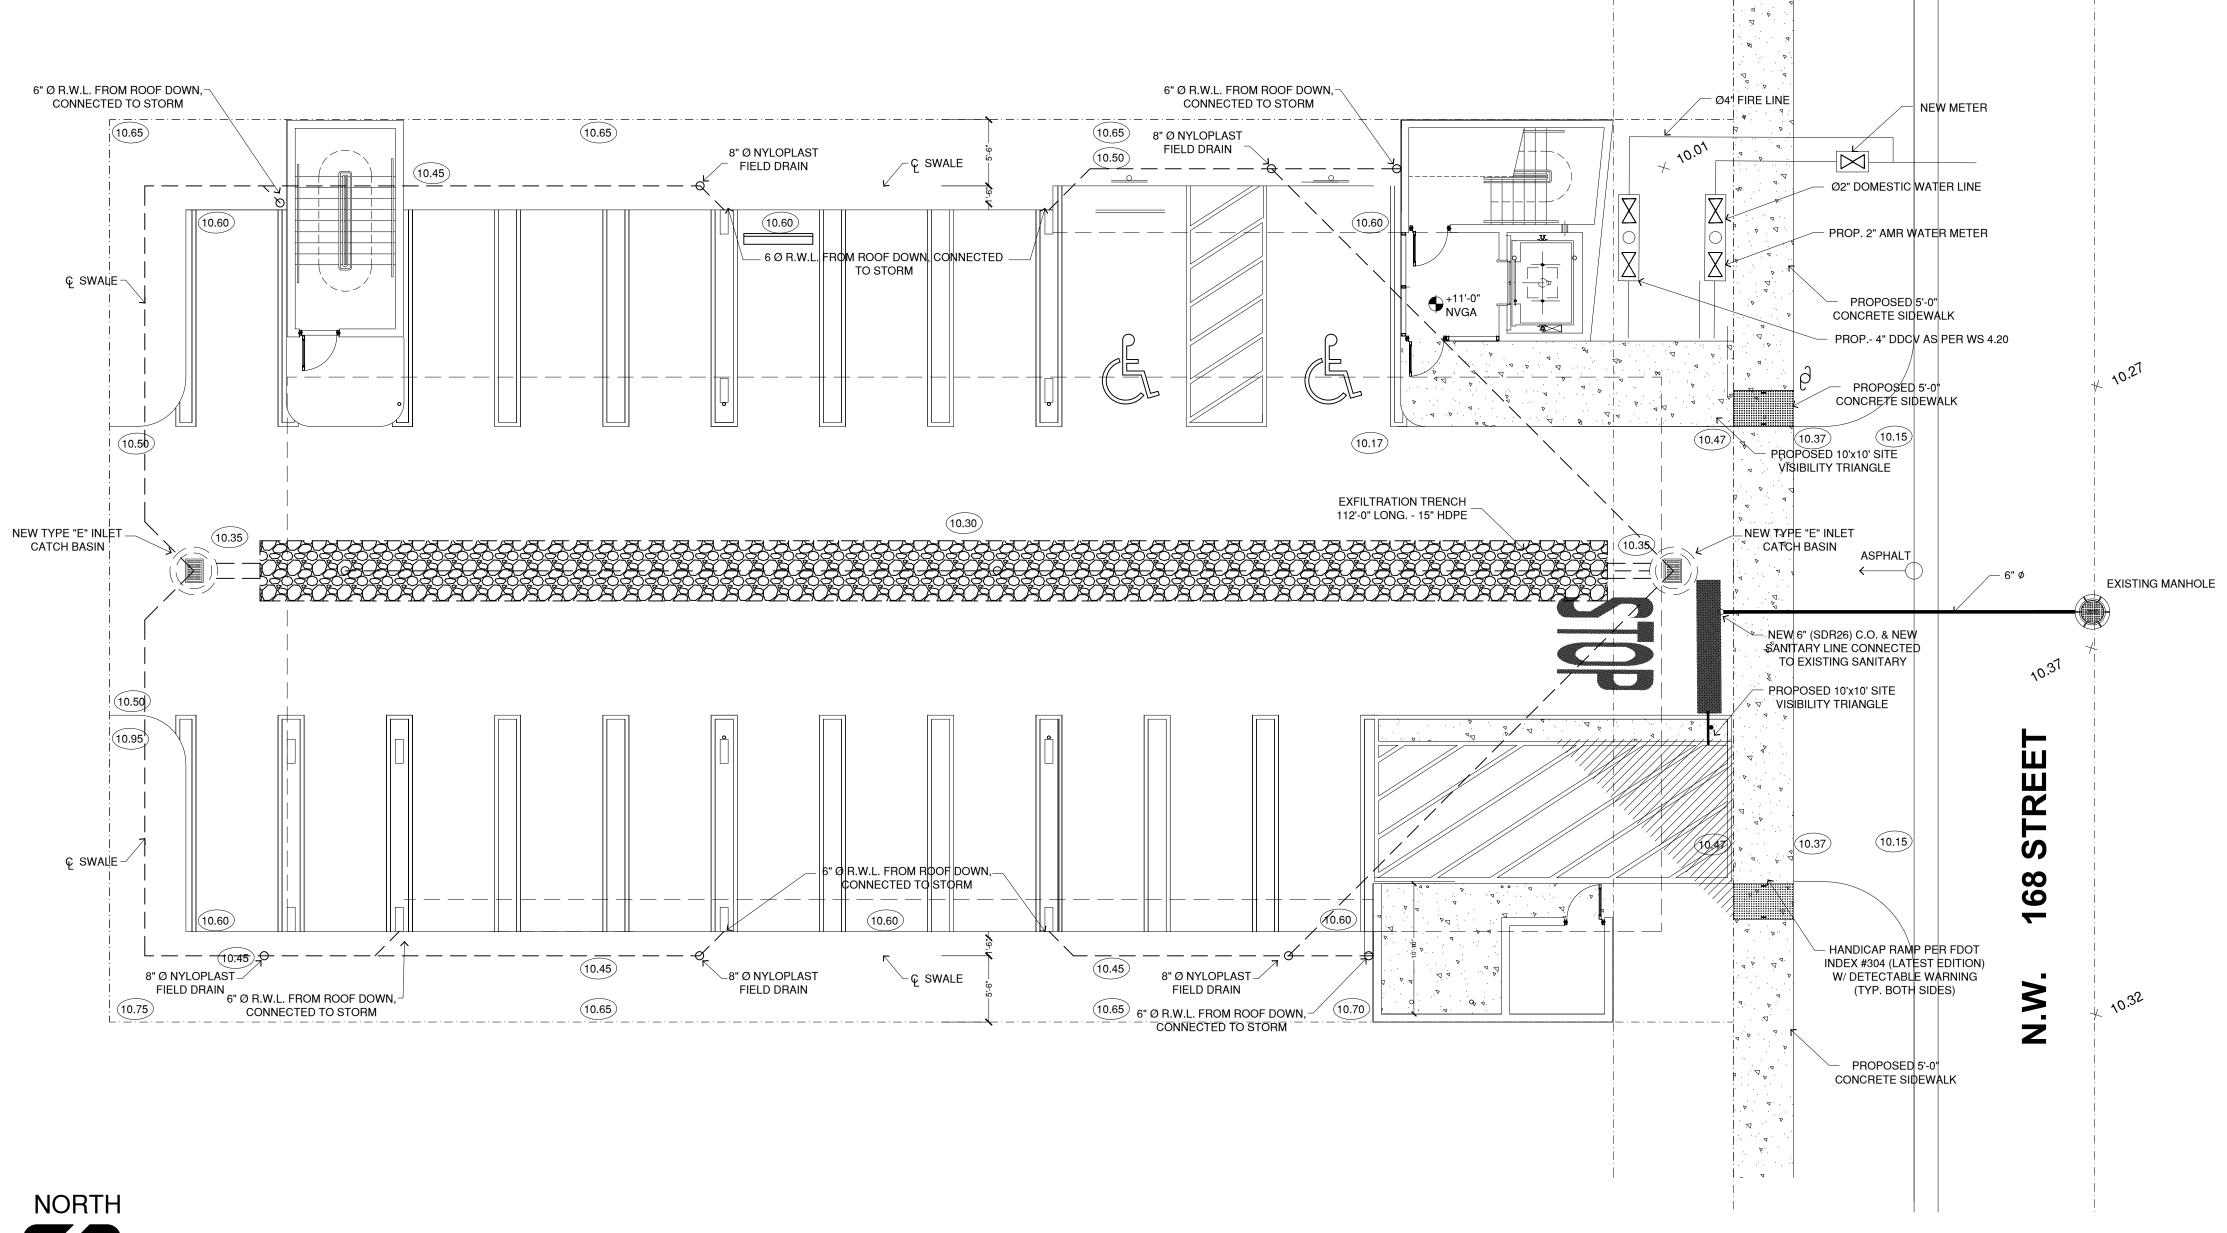

DRAINAGE PLAN
SCALE 1/8" - 1'-0"

PLANA INTERNATIONAL

JAIME PLANA ARCHITECT FLORIDA LICENSE AR 9769

1053 SW 12th STREET

BOCA RATON, FLORIDA 33486

PHONE: (561) 447-9344 e.FAX (561) 447-4162

E MAIL: archiplan@aol.com

CONSTRUKOMUSA

346 CONSERVATION DRIVE
WESTON, FLORIDA 33327
PHONE: (954) 999-6085 e.FAX (866) 610-4414
E MAIL: construkomusa@hotmail.com

IEDICAL OFFICE BUILDING
11 NW 168 STREET
NORTH MIAMI BEACH, FLORIDA 33169
Client Name
FV GOLDEN GROUP, LLC

PROJECT No.

DRAWN BY:

FOLIO #: 07-2113-007-0480

CAD FILE: 12-10-2020

MARK DATE DESCRIPTION

A.B. AS-BUILT

R.A.P. REVISION AFTER PERMIT

B.D.C. BUILDING DEPT. COMMENTS

C.C. COORDINATION CHANGES

P.S. PERMIT SET

D.D. DESIGN DEVELOPMENT

P.H. PUBLIC HEARING

JAIME PLANA SEAL


plot date:

12-10-2020
SHEET TITLE

DRAINAGE

PLAN - C

 $D_{-}10$

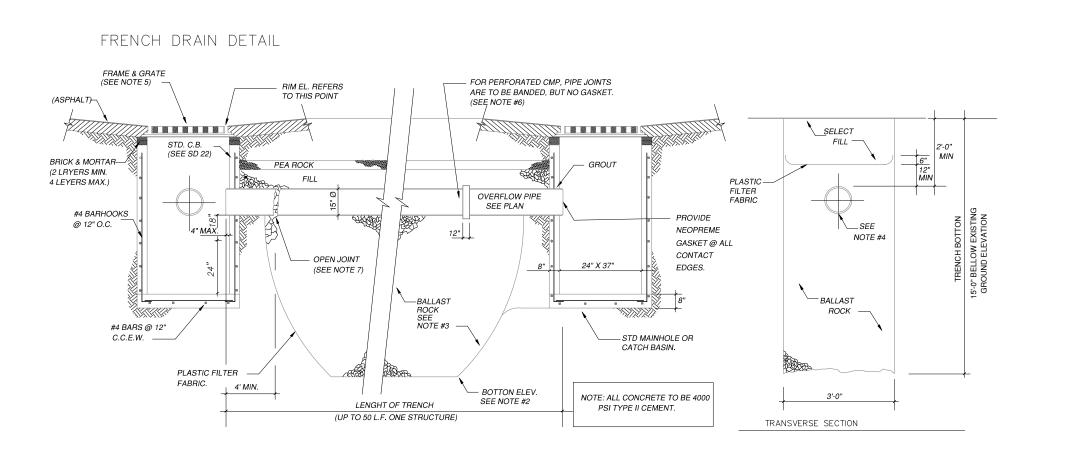

DRAINAGE GENERAL NOTES

1. AFTER THE BALLAST ROCK HAS BEEN PLACED TO THE PROPER ELEVATION IT SHALL BE CAREFULLY WASHED DOWN WITH CLEAN WATER IN ORDER TO ALLOW INITIAL SETTILEMENT THAT MAY OCCUR. IF IT DOES TAKE PLACE, ADDITIONAL BALLAST ROCK WILL BE ADDED TO RESTORE THE BALLAST ROCK TO PROPER ELEVATION, SO THAT THE EXFIL TRATION TRENCH BE COMPLETED IN ACCORDANCE WITH THE DETAILS.

2. PLASTIC FILTER FABRIC SHALL BE WOVEN MONOFILAMENT POLYPROPYLENE GEOTEXTILE. PERMITTIVITY SHALL BE GREATER THAN 0.50 SEC-1 AND FLOW RATE GREATER OR EQUAL TO 50 GAL/MIN.

3. THE CONTRACTOR SHALL TAKE THE NECESSARY PRECAUTIONS TO PREVENT CONTAMINATION OF THE TRENCH WITH SAND, SILT, AND FOREIGN MATERIALS.

4. ANY DAMAGE CAUSED WITHIN THE SITE OR TO ADJOINING PROPERTIES DURING CONSTRUCTION MUST BE CORRECTED BY THE GENERAL CONTRACTOR.

5. THE GENERAL CONTRACTOR SHALL CALL IN A LOCATION REQUEST TO SUNSHINE STATE ONE CALL OF FLORIDA, INC. PHONE NUMBER 1-800-432-4 770, TWO WORKING DAYS BEFORE DIGGING.

6. THE CONTRACTOR IS RESPONSIBLE FOR VERIFYING THE NATURE, SIZE, AND LOCATION OF ALL EXISTING UTILITIES PRIOR TO STARTING CONSTRUCTION.

NOTES:

- THE FOLLOWING UTILITY COMPANIES SHOULD BE NOTIFIED 48 HOURS IN ADVANCE OF EXCAVATION IN AREA.
- FLORIDA POWER AND LIGHT CO.
 BELL SOUTH/AT&T
 MIAMI DADE WATER AND SEWER DEPT.
- COMCAS I

 MIAMI-DADE COUNTY PUBLIC WORKS DEPT.

 CITY OF NORTH MIAMI BEACH PUBLIC WORKS DEPT.
- SUNSHINE STATE ONE CALL OF FLORIDA, INC. I ALL MATERIAL SHOULD BE D.I.P. EXCEPT SERVICES.

 IF EVIDENCE OF POTENTIAL CONTAMINATION IS DETECTED DURING EXCAVATION, STOP EXCAVATION WORK AND NOTIFY WASD ENVIRONMENTAL HEALTH AND SAFETY SECTION AT (786)552-8579 AND THE
- 3. IF EVIDENCE OF POTENTIAL CONTAMINATION IS DETECTED DURING EXCAVATION, STOP EXCAVATION WORK AND NOTIFY
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 MAY INCLUDE ANY OF THE FOLLOWING: 1. ODOR 2. SOLID WASTE DEBRIS 3. SHEEN ON THE GROUNDWATER 4.
 STAINED OR SATURATED SOIL (SOIL THAT CONTAINS PRODUCT THAT DRAINS WHEN IT IS HANDLED OR CREATES STREAKS ON EXCAVATION TOOLS) OR
 FREE FLOATING PRODUCT ON THE GROUNDWATER (OIL, DIESEL, GASOLINE, ETC.). MATERIAL THAT HAS ODOR, IS STAINED OR
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- ALL WATER MAIN PIPE AND FITTINGS INSTALLED UNDER THIS PROJECT MUST BECOLOR CODED WITH
 BLUE PAINT AS STATED IN THE FLORIDA ADMINISTRATIVE CODE, SUBPARAGRAPH 62-555.320(21) (B)3 AND AS
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 BE APPLIED IN A CONTINUOUS LINETHAT RUNS PARALLEL TO THE AXIS OF THE PIPE AND THAT IS LOCATED ON THE TOP OF THE PIPE.

FULL ENCASEMENT

LONGITUDINAL SECTION

* NO SLOTS OR PERFORATIONS ON THIS LENGHT OF PIPE. NOTE: IF THIS DETAIL IS TO BE USED FOR PRETREATMENT OF STORMWATER RUN-OFF, THE INVERT OF PIPE TO BE AS SHOWN IN W.C. 2.2, IF PRETEATMENT HAS BEEN PROVIDED THRU OTHER. MEANS THE INVERT OF PIPE CAN BE LOWER THAN SHOWN IN W.C. 2.2

NOTE:

1- PLASTIC FILTER FABRIC (AT EACH SIDE) SHALL BE USED IN SANDY AREAS AS NOTED ON PLANS AND/OR AS DIRECTED BY THE ENGINEER.

2- THE BOTTON OF THE EXFILTRATION TRENCH SHALL BE 15'-0" BELLOW EXISTING GROUND ELEVATION, UNLESS FIELD CONDITION WARRANT OTHERWISE.

3- AFTER THE BALLAST ROCK HAS BEEN PLACED TO THE PROPER ELEVATION, IT SHALL BE CAREFULLY WASHED DOWN WITH CLEAN WATER IN ORDER TO ALLOW FOR INITIAL SETTLEMENT THAT MAY OCCUR. IF IT DOES TAKE

PLACE ADDITIONAL BALLAST ROCK WILL BE ADDED TO RESTORE THE


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5- FRAME AND GRATE: USF 4155-6210 OR EQUAL MIN. WEIGT 240 LB. TOTAL WEIGTH 575 LB.

6- PIPE SHALL BE PERFORATED CORRUGATED ALUMINUM.7- PIPES SHALL TERMINATE 2 FEET FROM END OF TRENCH OR CONNECTED TO


ADDITIONAL CATCH BASIN AS REQUIRED.



ALT. TRANS. SECTION

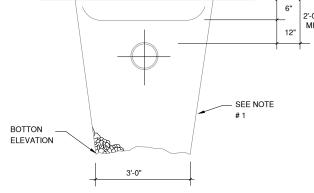MAY BE USED IN AREAS WHERE TRENCH
WALLS WILL NOT STAND VERTICAL, OR
WHERE CAVE IN BELLOW THE WATER
TABLE IS LIKELY TO OCCUR. TO BE
USED AT THE ENGINEER'S DISCRETION.

CONCRETE ANCHORS

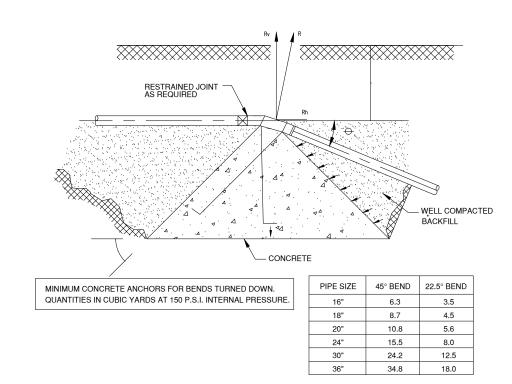

NOTES:

1. QUANTITIES ARE GIVEN FOR CONCRETE ANCHORS IN DRY SOIL.

2. ANCHOR RODS TO BE MINIMUM #6 EPOXY COATED STEEL REINFORCING BAR AND MORTAR COATED AFTER INSTALLATION.


3. QUANTITIES OF CONCRETE ANCHORS TO BE USED BELOW THE GROUND WATER TABLE SHALL BE CALCULATED BY MULTIPLYING ABOVE VALUES WITH 1.76.

4. VERTICAL BENDS TURNED UP SHALL BE ANCHORED WITH THE SAME SIZE ANCHORS AS SPECIFIED FOR HORIZONTAL BENDS.

5. WEIGHT OF PIPE, WATER, WEIGHT OF SOIL ABOVE ANCHORS AND RESTRAINED PIPE LENGTH, MAY BE CONSIDERED TO DECREASE VOLUME OF CONCRETE BLOCK.

6. WHERE FIELD CONDITIONS WARRANT - ANCHORS MAY BE REQUIRED ON 6" TO 12" PIPE

TYPICAL TRENCH BACKFILL

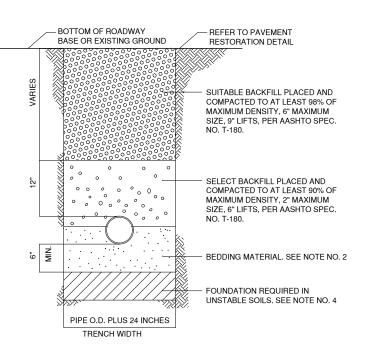

1. FOR EXCAVATION AND BACKFILL AROUND MANHOLES, APPURTENANCES, OR IN WATER, REFER TO PROVISIONS WITHIN THE SPECIFICATIONS.

2. UNLESS OTHERWISE SPECIFIED, BEDDING MATERIAL SHALL CONSIST OF SELECT BACKFILL MATERIAL 2" MAX. SIZE, OR WASHED AND GRADED LIMEROCK (3/8" - 7/8"), COMPACTED TO AT LEAST 90% OF MAX. DENSITY, 6" LIFTS, PER AASHTO SPEC. NO. T-180.


3. WHERE REQUIRED, SHEETING AND SHORING SHALL BE IN ACCORDANCE WITH SPECIFICATION.

4. WHERE UNSTABLE SOILS ARE ENCOUNTERED, INCLUDING PEAT, MUCK OR OTHER ORGANIC SOILS, ELASTIC SILT AND CLAYS, A FOUNDATION IS REQUIRED, COMPACTED TO AT LEAST 90% OF MAX. DENSITY, 6" LIFTS PER AASHTO SPEC. NO. T-180. FOUNDATION MATERIAL SHALL BE SELECT BACKFILL MATERIAL, 2" MAXIMUM SIZE, 6" LIFTS. EXTEND EXCAVATION UNTIL A SUITABLE MATERIAL IS FOUND.

5. IN A LOW PRESSURE SEWER SYSTEM USE SAND OR 1/4" RICE ROCK FOR SELECT BEDDING AND 12" SELECT BACKFILL MATERIAL AS SHOWN ABOVE.

MINIMUM 36" OF COVER.

CONCRETE ARCH

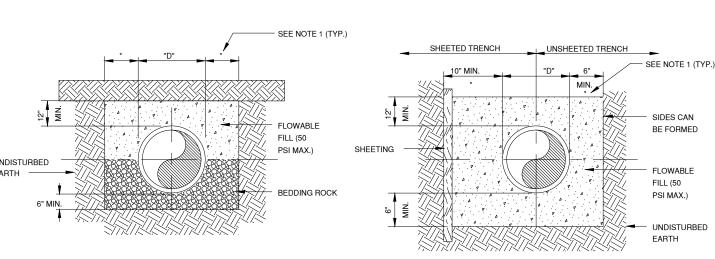

NOTES:

1. (*): 15" MAX. FOR PIPE DIAMETER LESS THAN 24", AND 24" MAX. FOR PIPE DIA. 24" AND OVER.


2. "D" REFERS TO THE DIAMETER OF THE PIPE.

3. "T" REFERS TO THE THICKNESS OF THE PIPE.


4. USE OF CONCRETE ARCH HALF ENCASEMENT OR FULL ENCASEMENT TO BE DETERMINED IN THE FIELD AS DIRECTED BY THE CITY.

5. REFER TO SECTION 2.18-E OF THE UTILITY AND ENGINEERING STANDARDS MANUAL FOR SHEETING AND BRACING IN EXCAVATIONS.

CRADLE OR HALF ENCASEMENT

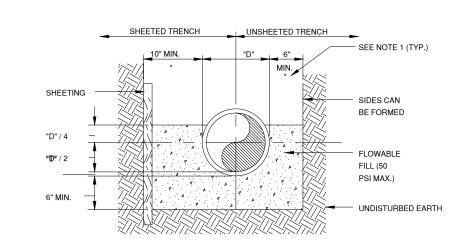

TYPICAL WATER SERVICE CONNECTION

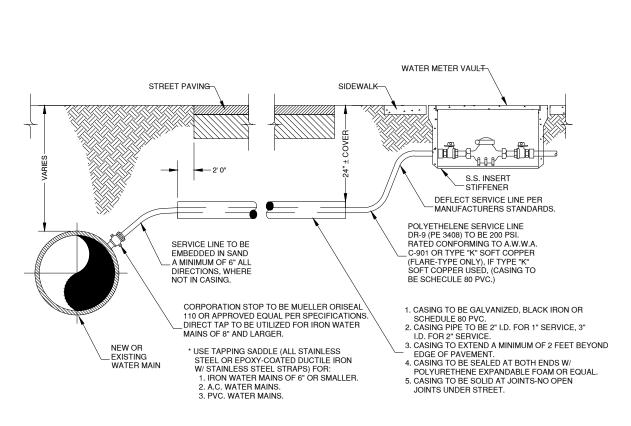

NOTE:

1. POLYETHELENE SERVICE LINE TO BE CONTINUOUS FROM CORPORATION STOP TO METER, NO COUPLINGS ARE PERMITTED.


2. KINKED OR CRIMPED PIPE AND OR TUBING SHALL BE REJECTED.

3. SERVICE LINES SHALL BE 3: COVER IN STATE D.O.T. RIGHTS-OF-WAY CONTINUOUSLY TO METER BOX. (SEE DETAIL NO. WM-1A).

4. SERVICES SHALL HAVE 2' COVER IN TRAFFIC AREA AND 18" COVER IN NON-TRAFFIC AREA (CITY NMB & MIAMI-DADE CTY. RIGHTS-OF-WAY).

5. WRAP NON-METALLIC SERVICE LINE WITH 10 GAUGE COPPER WIRE OR METALLIC DETECTOR TAPE.

TYPICAL 3/4" TO 2" REDUCED PRESSURE BACKFLOW ASSEMBLY INSTALLATION

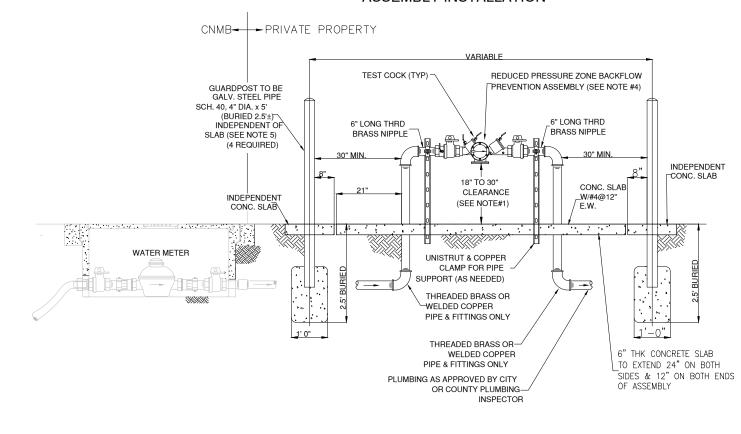

NOTE:

1. THE ASSEMBLY MUST BE INSTALLED WITH MINIMUM HORIZONTAL CLEARANCE OF 18" MINIMUM TO 30" MAXIMUM, FREE FROM OBSTRUCTIONS IN ALL DIRECTIONS.


2. THE BACKFLOW PREVENTION ASSEMBLY SHALL BE ON THE APPROVED LIST OF FOUNDATION FOR CROSS CONNECTION AND HYDRAULIC RESEARCH CONTROL OF THE UNIVERSITY OF SOUTHERN CALIFORNIA. CONTRACTOR TO PROVIDE MANUFACTURERS CERTIFICATION OF U.S.C. APPROVAL.

ALL BACKFLOW PREVENTION ASSEMBLIES 3" AND SMALLER SHALL BE FACTORY ASSEMBLED INCLUDING SHUT OFF VALVE AS REQUIRED BY U.S.C. FOUNDATION FOR CROSS CONNECTION CONTROL STANDARDS. ON DEVICES.
 BACKFLOW PREVENTION ASSEMBLIES SHALL BE INSTALLED IN AN ACCESSIBLE LOCATION APPROVED BY CITY OF NORTH MIAMI BEACH PUBLIC UTILITIES. LOCATIONS INSIDE BUILDING OR WITH OTHERWISE RESTRICTED ACCESS WILL NOT BE APPROVED.
 GUARDPOSTS OR PROTECTIVE ENCLOSURE MAY BE REQUIRED DEPENDING ON SITE CONDITIONS.

6. INSTALL PIPE SUPPORTS AS NEEDED.7. ALL PIPE AND FITTINGS 2" AND SMALLER SHALL BE BRASS OR COPPER.

8. ALL EXPOSED METALLIC THREADS SHALL BE PAINTED WITH BITUMASTIC PAINT. ALL OUTLETS SHALL BE PLUGGED WITH BRASS.

TYPICAL 1 1/2 " & 2" SERVICE & METER INSTALLATION

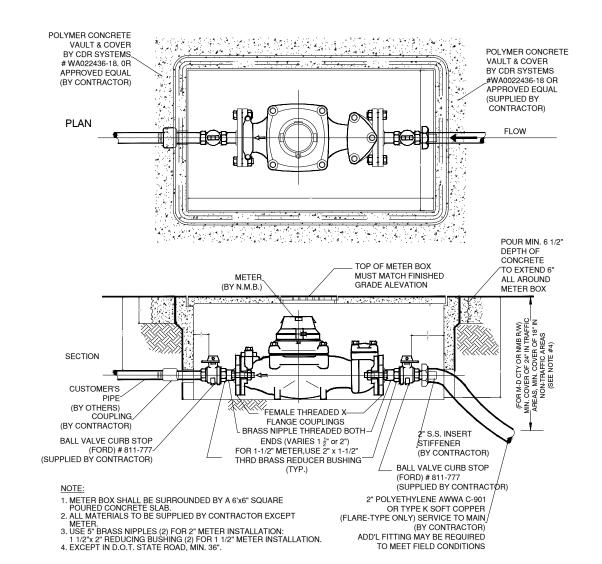

REQUIREMENTS PER DEPARTMENT OF HEALTH

WATER MAIN HORIZONTAL SEPERATIONS

1. Separations shall be measured outside edge to outside edge.
2. Between water mains and, storm sewers, storm water force mains, or reclaimed water lines, SHALL be 3 ft. minimum.
3. Between water mains and vacuum type sewer preferably 10 ft. and at least 3 ft. minimum.
4. Gravity or pressure sanitary sewers, wastewater force mains or reclaimed water preferably 10 ft. and at least 6 ft. MAY be reduced to 3 ft. Where bottom of water main is at least 6 inches above top of sewer.

WATER MAIN VERTICAL SEPARATIONS

5. 10ft. of any part of on-site sewer treatment or disposal

Separations between water mains and gravity sewer, vacuum type sewer, or storm sewers to be preferably 12 inches, or at least 6 inches above, or at least 12 inches if below.
 Pressure sanitary sewer, wastewater or storm water force main, or reclaimed water, at least 12 inches above or below.

* Note: Center 1 - full length of water main pipe at crossings, alternatively arrange pipes so joints are at least 3 feet from joints in vacuum, storm or storm force mains.

At least 6 feet from joints in gravity of pressure sewers, wastewater force mains or reclaimed water.

TRENCH PROTECTION

Trench excavation protection sh

Trench excavation protection shall be accomplished as required by the provisions of Part 1926, Subpart P, Excavations, Trenching and Shoring of the Occupational Safety and Health Administrations Standards and Interpretations.

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WESTON, FLORIDA 33327
PHONE: (954) 999-6085 e.FAX (866) 610-4414
E MAIL: construkomusa@hotmail.com

ROPOSED SITE PLAN FOR

CAL OFFICE BUILDING
11 NW 168 STREET
TH MIAMI BEACH, FLORIDA 33169
Client Name
/ GOLDEN GROUP, LLC

PROJECT No.

DRAWN BY:
FOLIO #: 07-2113-007-0480

CAD FILE: 12-10-2020

MARK DATE DESCRIPTION

A.B. AS-BUILT

R.A.P. REVISION AFTER PERMIT

B.D.C. BUILDING DEPT. COMMENTS

C.C. COORDINATION CHANGES

P.S. PERMIT SET

JAIME PLANA SFAI

DESIGN DEVELOPMENT

PUBLIC HEARING


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plot date:

12-10-2020
SHEET TITLE

ENGINEERING
DETAILS

C-2

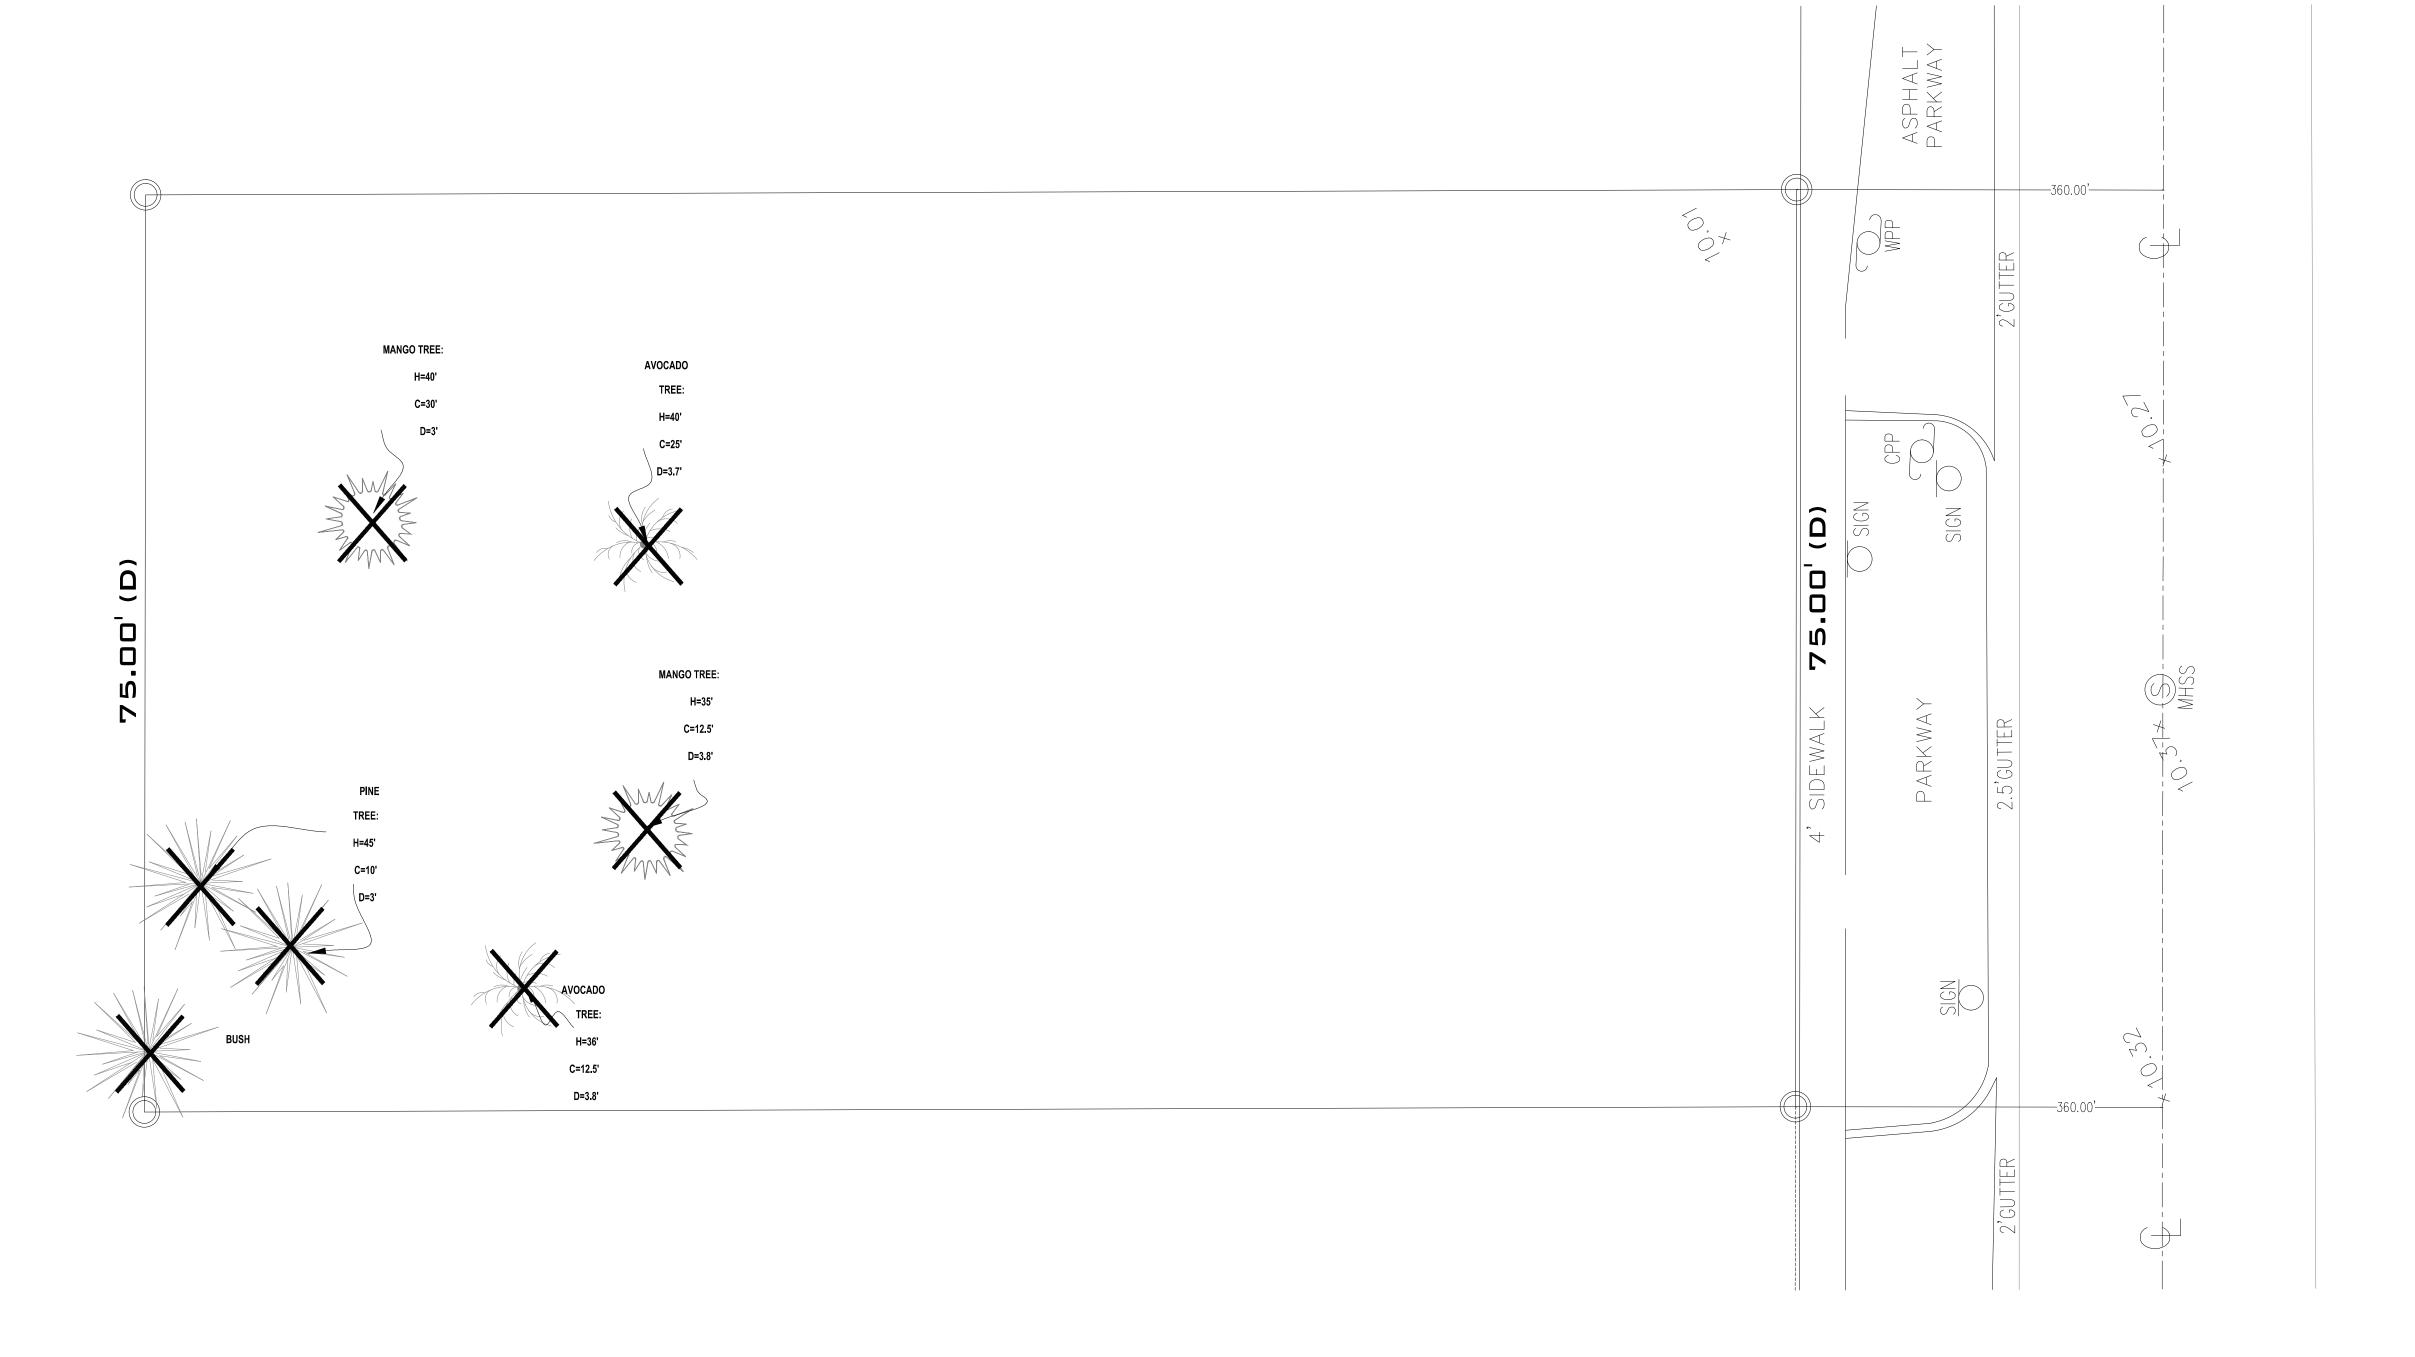

MIAMI-DADE COUNTY LANDSCAPE ORDINANCE REQUI	REMENTS

SITE DATA

MCUCD - MODEL CITY URBAN CENTER DISTRICT EDGE SUB-DISTRICT MC - MIXED-USE CORRIDOR ZONING DISTRICT

OPEN SPACE

IRRIGATION

IF REQUIRED BY CHAPTER 33

A. SQUARE FEET OF OPEN SPACE REQUIRED BY CHAPTER 33, AS INDICATED ON SITE PLAN:

NET LOT AREA

A. SQUARE FEET OF OPEN SPACE REQUIRED BY CHAPTER 33, AS INDICATED ON SITE PLAN:

B. SQUARE FEET OF PARKING LOT OPEN SPACE REQUIRED BY CHAPTER 18A, AS INDICATED ON SITE PLAN:

NA	NA
4,6,075 (MAX. PERM'D)	1,835 PROV'D
7 REQ'D	12 PROV'D
4 REQ'D	9 PROV'D
3 REQ'D	3 PROV'D
3 REQ'D	3 PROV'D
50 REQ'D	90 PROV'D
15 REQ'D	30 PROV'D
	4,6,075 (MAX. PERM'D) 7 REQ'D 4 REQ'D 3 REQ'D 3 REQ'D

PLANT_SCH	HEDULE								
TREES	QTY	BOTANICAL NAME	COMMON NAME	CONT	SPECIFICATIONS	NATIVE	DROUGHT		REMARKS
SM	9	SWIETENIA MAHOGANY	MAHOGANY	FG/B&B	18` HT. X 6` SPR	YES	HIGH		
RR	1	ROYSTONEA ELATA	FLORIDA ROYAL PALM	FG/B&B	8` GW., HEAVY & MATCHED	YES	MEDIUM		
MP	2	VEITCHIA MONTGOMERYANA	MONTGOMERY PALM	FG/B&B	SGL TK, FG, 25' O.A. FULL HA 10' C.T., HTS 25',28'-31'		MEDIUM		
FMG	134	FICUS MICROCARPA `GREEN ISLAND`	GREEN ISLAND FICUS	3 GAL.,	14" HT X 16" SPR	NO	HIGH	18" o.c.	
ID	12	IXORA MAUI	DWARF MAUI IXORA	3 GAL.,	20" HT X 20" SPR	NO	HIGH	20" o.c.	
JVW	100	JASMINUM VOLUBILE	WAX JASMINE	3 GAL.,	20" HT X 20" SPR	NO	MEDIUM	24" o.c.	
SOD	1,800 SF	STENOTAPHRUM SECUNDATUM `FLORITAM`	`FLORITAM` ST. AUGUSTINE SOD	SOD					

NOTES TRIANGLE OF VISIBILITY, MAINTAIN CROSS VISIBILITY BETWEEN 2'-6" AND 6'-0" IN ELEVATION ABOVE ESTABLISHED GRADE. ALL SODDED AREAS TO BE STENOTAPHRUM SECUNDATUM `FLORITAM`, ST. AGUSTINE GRASS SOD FLATS. 2 SM - STREET TREES

NA

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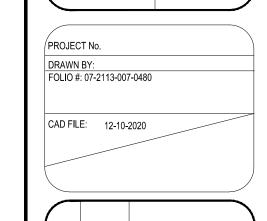
FLORIDA LICENSE AR 9769


1053 SW 12th STREET BOCA RATON, FLORIDA 33486 PHONE: (561) 447-9344 e.FAX (561) 447-4162 E MAIL: archiplan@aol.com


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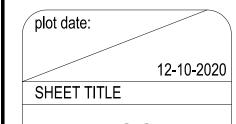







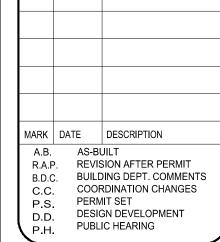

JAIME PLANA SEAL

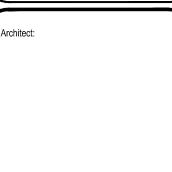

LANDSCAPE **EXISTING**

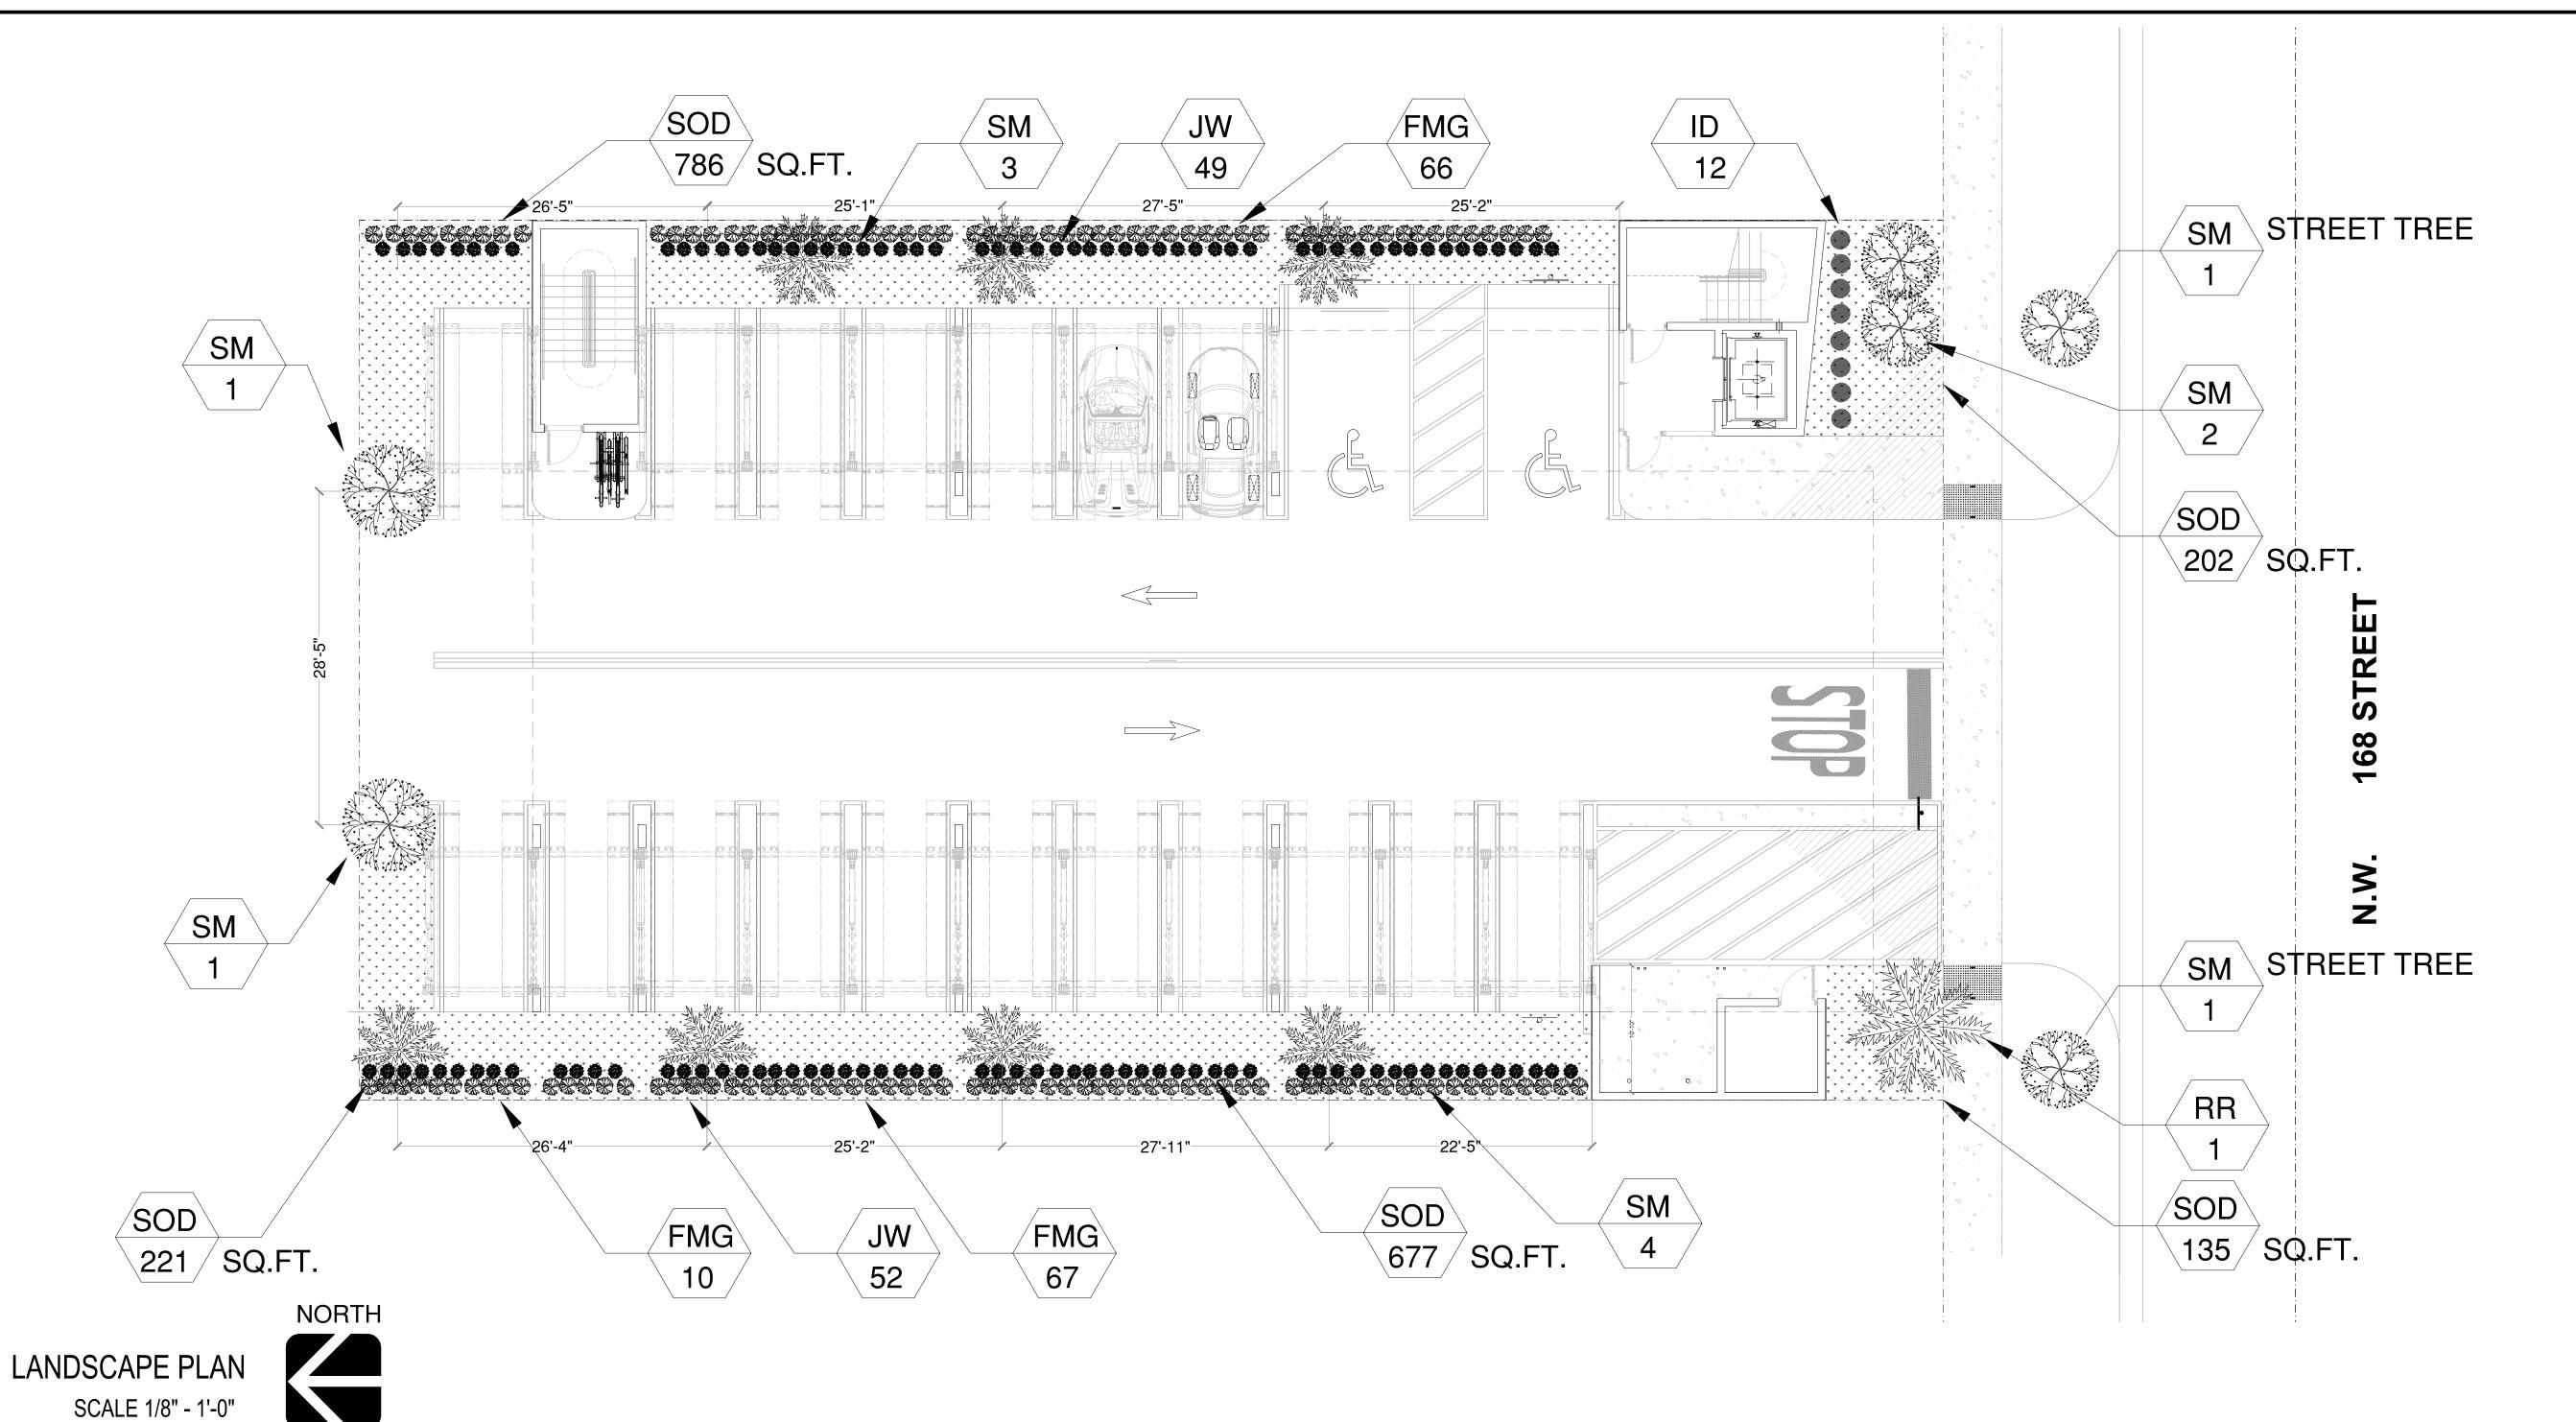

LANDSCAPE NOTES

- 1. ALL PLANT MATERIAL SHALL BE FLORIDA NO. 1 OR BETTER.
- 2. CONTRACTOR SHALL FAMILIARIZE HIMSELF WITH THE LOCATION OF AND AVOID AND PROTECT UTILITY LINES, BURIED CABLES, AND OTHER UTILITIES.
- 3. TREE, PALM, ACCENT AND BED LINES ARE TO BE LOCATED IN THE FIELD AND APPROVED BY THE LANDSCAPE ARCHITECT PRIOR TO INSTALLATION.
- 4. ALL PLANTING SOIL SHALL BE 50:50 TOPSOIL:SAND MIX, FREE OF CLAY, STONES, ROCKS OR OTHER FOREIGN MATTER. THIS SPECIFICATION INCLUDES ALL BACKFILL FOR ALL LANDSCAPE AREAS.
- SODDED-LAWN AREAS:
- 2" DEPTH PLANTING SOIL SPREAD IN PLACE THROUGHOUT.
 GROUNDCOVER PLANTING BEDS:
- 6" DEPTH PLANTING SOIL SPREAD IN PLACE THROUGHOUT.
- SHRUB AND HEDGE PLANTING AREAS:
- 12" DEPTH PLANTING SOIL SPREAD IN PLACE THROUGHOUT.


 TREES, PALMS, SPECIMEN PLANT MATERIAL:
 - 24" DEPTH PLANTING SOIL SPREAD IN PLACE -OR-
- TO THE DEPTH OF THE ROOTBALL OR CONTAINER, WHICHEVER IS GREATEST, THROUGHOUT.
- LANDSCAPE ISLANDS AND BUILDING FOUNDATIONS:
 - EXCAVATE AND REMOVE ALL LIMEROCK, ROCKS, DEBRIS, ETC, TO A DEPTH OF 12" AND BACKFILL W/ 50:50 TOPSOIL:SAND MIX. BUILDING FOUNDATIONS SHALL BE THE SAME FOR A WIDTH OF 36" FROM THE BUILDING BASE.

- THE SITE CONTRACTOR SHALL BE RESPONSIBLE TO BRING ALL GRADES TO WITHIN 2" OF FINAL GRADES. THIS SHALL INCLUDE A 2" APPLICATION OF 50:50 TOPSOIL:SAND MIX FOR ALL LANDSCAPE AND AREAS TO BE SODDED.
- THE LANDSCAPE CONTRACTOR SHALL CALCULATE AND SUBMIT AN ITEMIZED PRICE FOR THE 2" APPLICATION OF 50:50 MIX FOR ALL SOD AREAS AS A REFERENCE IN THE CASE THAT THERE WOULD BE A DISCREPANCY BETWEEN SITE AND LANDSCAPE CONTRACTORS AND NOTIFY THE SITE CONTRACTOR OR PROJECT SUPERINTENDENT AS TO THIS DISCREPANCY. IT WILL THEN BE DETERMINED WHICH PARTY WILL PROVIDE THIS 2" TOPSOIL:SAND SOIL APPLICATION AND SUBSEQUENT PAYMENT.
- OTHER PLANTING SOIL MIXES TO BE ADDED, I.E., FOR TREES, PALMS, SPECIMEN PLANTS, SHRUBS, AND GROUNDCOVERS SHALL BE THE RESPONSIBILITY OF THE LANDSCAPE CONTRACTOR AND BE INCLUSIVE WITH THE LANDSCAPE BID.
- 5. CONTRACTOR SHALL COORDINDATE WITH THE IRRIGATION CONTRACTOR AND LEAVE PROVISIONS FOR ALL.
- 6. ALL PLANTING BEDS SHALL BE MULCHED TO A DEPTH OF 3" WITH AN APPROVED RECYCLED MULCH BY THE PRESIDING GOVERNING AGENCY.
 NO HEAVY METALS, I.E. ARSENIC, ETC. ARE TO BE CONTAINED IN THE MULCH, THE CONTRACTOR SHALL PROVIDE CERTIFICATION OR PROOF THAT ALL MULCH IS FREE OF HEAVY METALS OR SIMILAR ENVIRONMENTAL CONTAMINANTS.
- 7. SOD SHALL BE ARGENTINE "BAHIA" OR ST. AUGUSTINE "FLORATAM" AS SHOWN ON PLAN, STRONGLY ROOTED, FREE FROM WEED, FUNGUS, INSECTS AND DISEASE. CONTRACTOR SHALL SOD ALL AREAS AS INDICATED ON THE PLANS OR AS DIRECTED. CONTRACTOR SHALL BE PAID BY THE TOTAL SODDED AREA X THE UNIT PRICE SUBMITTED (FIELD VERIFIED).
- 8. SOD SHALL BE INSTALLED IN ACCORDANCE WITH THE SPECIFICATIONS AS DEFINED BY FDOT. SOD SHALL CARRY A 5-MONTH WARRANTY.
- 9. ALL TREES, PALMS, SHRUBS AND GROUNDCOVERS SHALL CARRY A 1-YEAR WARRANTY FROM THE DATE OF FINAL ACCEPTANCE.

- 10. ALL TREES AND PALMS SHALL BE STAKED PER ACCEPTED STANDARDS BY THE FLORIDA NURSERYMEN & GROWERS ASSOCIATION (FNGA).

 THERE SHALL BE ONE FINAL INSPECTION FOR APPROVAL BY THE PRESIDING GOVERNING AGENCY. CONTRACTOR SHALL INSURE THAT THE PLANS, DETAILS, SPECIFICATIONS AND NOTES HAVE BEEN ADHERED TO AND THAT THE LANDSCAPE AND IRRIGATION INSTALLATION IS COMPLIANT TO ALL ITEMS AS DIRECTED ON THE PLANS PRIOR TO SCHEDULING OF THE FINAL INSPECTION.
- 11. THE PLANT LIST IS INTENDED ONLY AS AN AID TO BIDDING. ANY DISCREPANCIES FOUND BETWEEN THE QUANTITIES ON THE PLAN AND PLANT LIST THE QUANTITIES ON THE PLAN SHALL BE HELD VALID.
- 12. IRRIGATION SHALL PROVIDED FOR A 100% COVERAGE W/ A 100% OVERLAP AUTOMATIC SYSTEM W/ RAIN MOISTURE SENSOR AS PER FLORIDA XERISCAPE LAW REQUIREMENTS. NO OVERSPRAY SHALL FALL ONTO PAVED SURFACES. ALL GUIDELINES AS OUTLINED BY THE SOUTH FLORIDA WATER MANAGEMENT DISTRICT (SFWMD) SHALL BE STRICTLY ADHERED.
- 13. EXISTING IRRIGATION SYSTEM (IF APPLICABLE) SHALL BE RETROFITTED TO COMPLY WITH THOSE SPECIFICATIONS AS OUTLINED ABOVE.
- 14. CONTRACTOR SHALL PROVIDE A WATER TRUCK DURING PLANTING TO INSURE PROPER WATERING-IN DURING INSTALLATION AND WILL BE RESPONSIBLE FOR CONTINUAL WATERING UNTIL FINAL ACCEPTANCE BY THE OWNER.
- 15. ALL TREES AND PLANT MATERIAL TO REMAIN SHALL BE PROTECTED DURING CONSTRUCTION. CONTRACTOR SHALL INSTALL PROTECTIVE BARRIERS SUCH AS "TENAX" ORANGE SAFETY FENCING OR SIMILAR, TO BE INSTALLED AT THE BEGINNING OF THE PROJECT. BARRIERS SHALL BE LOCATED TO INCLUDE THE DRIP LINE OF THE TREES, PALMS AND PLANT MATERIAL. THE CONTRACTOR SHALL TAKE EXTRA CAUTION TO PREVENT ANY DAMAGE TO THE TRUNK, ROOT ZONES AND GRADE.
- 16. EXISTING TREES TO REMAIN SHALL BE TRIMMED PER ANSI-300 STANDARDS. SUPERVISION OF THE TRIMMING SHALL BE PERFORMED BY A CERTIFIED ARBORIST TO INSURE QUALITY WORK.
- 17. REMOVAL OF ANY TREES OR PALMS WILL REQUIRE A WRITTEN "TREE REMOVAL PERMIT" FROM THE LOCAL GOVERNING AGENCY PRIOR TO REMOVAL. NON-NATIVE TREES CLASSIFIED AS "NUISANCE" TREES MAY BE EXEMPT FROM THE PERMIT.

PLANA INTERNATION JAIME PLANA FLORIDA LICENSE AR 9769 1053 SW 12th STREET BOCA RATON, FLORIDA 33486 HONE: (561) 447-9344 e.FAX (561) 447-4 E MAIL: archiplan@aol.com CONSTRUKOMUSA 346 CONSERVATION DRIVE WESTON, FLORIDA 33327 E MAIL: construkomusa@hotmail.com MEDIC, PROJECT No. DRAWN BY: FOLIO #: 07-2113-007-0480 CAD FILE: 12-10-2020 MARK DATE DESCRIPTION R.A.P. REVISION AFTER PERMIT B.D.C. BUILDING DEPT. COMMENTS COORDINATION CHANGES PERMIT SET DESIGN DEVELOPMENT PUBLIC HEARING JAIME PLANA SEAL plot date: 12-10-2020 SHEET TITLE LANDSCAPE

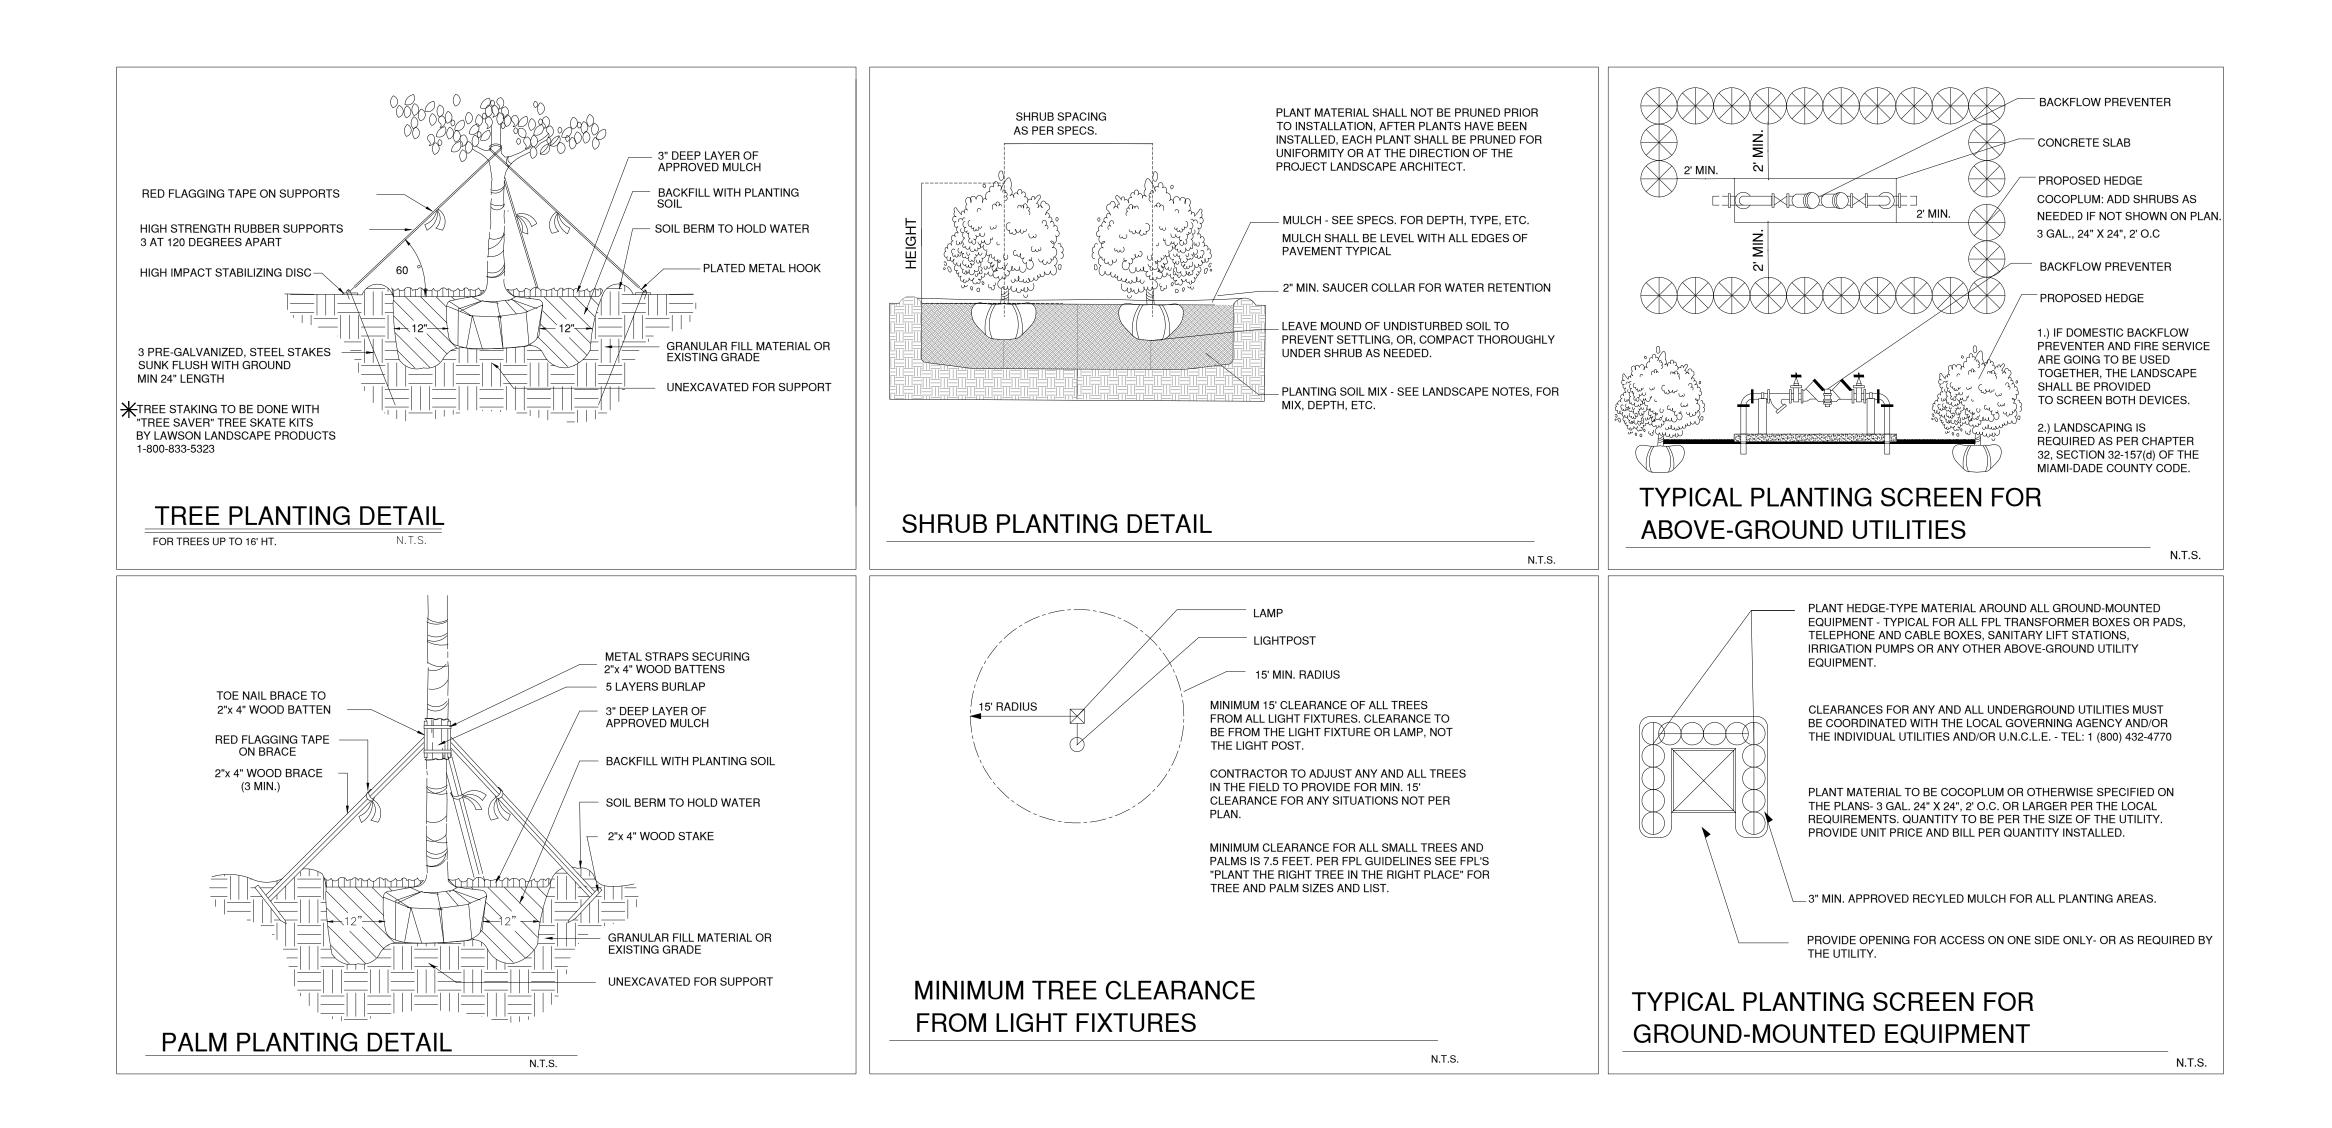

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JAIME PLANA ARCHITECT FLORIDA LICENSE AR 9769

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CAL OFFICE BUILDING
11 NW 168 STREET
TH MIAMI BEACH, FLORIDA 33169
Client Name
' GOLDEN GROUP, LLC

PROJEC		
DRAWN FOLIO#	<u>вү:</u> : 07-2113-00	7-0480
CAD FIL	E: 12-10-	-2020
MARK	DATE	DESCRIPTION
A.B. R.A.F B.D.C C.C P.S. D.D	REVIS BUILI COOI PERM	UILT SION AFTER PERMIT DING DEPT. COMMENT RDINATION CHANGES MIT SET GN DEVELOPMENT


NIME PLANA SEAL

plot date:

12-10-2
SHEET TITLE

LANDSCAPE DETAILS

1-30

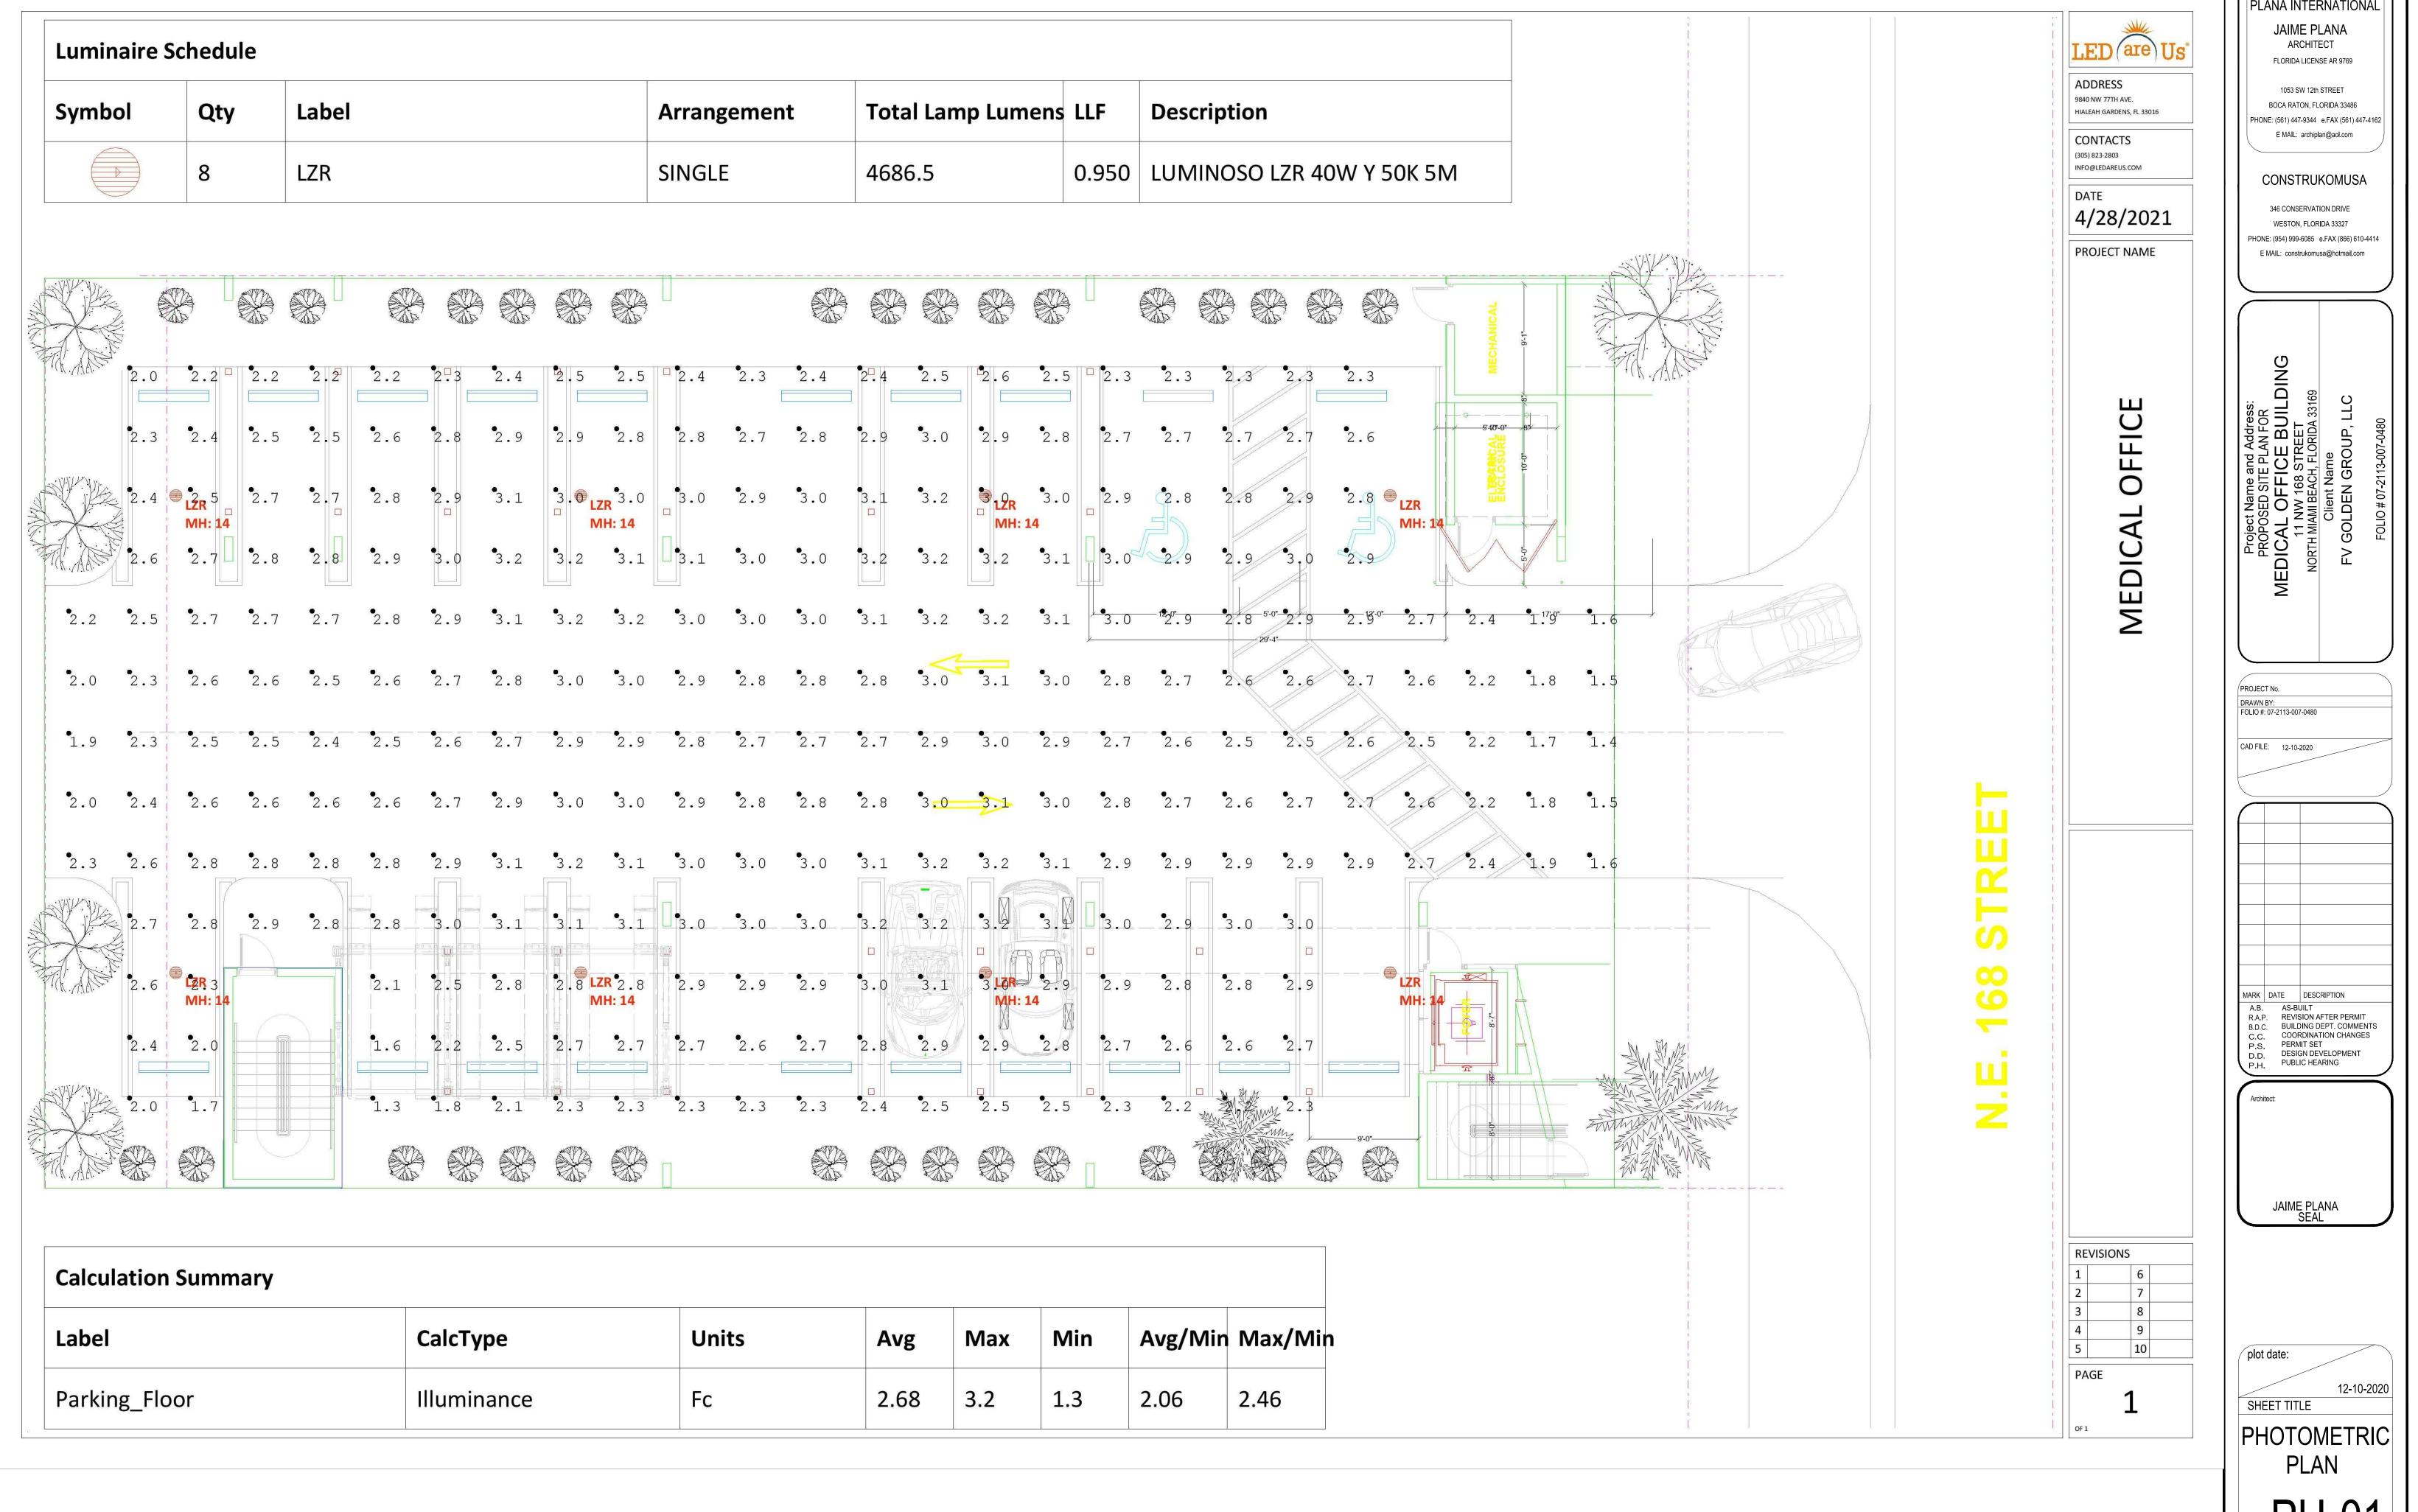

PLANA INTERNATIONA

PH-01

GRAPHIC SCALE -20' -10'10' (IN FFFT ' 1 INCH = 20 FT.

LEGAL DESCRIPTION:

LOTS 29, 30 & 31, BLOCK 6, OF "OLETA TERRACE", ACCORDING TO THE PLAT THEREOF, AS RECORDED IN PLAT BOOK 8. AT PAGE 117. OF THE PUBLIC RECORDS OF MIAMI-DADE COUNTY, FLÓRIDA.

PROPERTY ADDRESS:

FOLIO NO. 07-2113-007-0480

11 NW 168TH STREET, NORTH MIAMI BEACH, FL 33169-6027

AREA OF PROPERTY: 10.125 SQUARE FEET AND/OR 0.232 ACRES MORE OR LESS.

CERTIFIED TO:

THIS BOUNDARY SURVEY HAS BEEN PREPARED FOR THE EXCLUSIVE USE OF THE ENTITIES NAME HEREON. THE CERTIFICATIONS DO NOT EXTEND TO ANY UNNAMED PARTIES.


-FV GOLDEN GROUP LLC.

SURVEYOR'S NOTES:

- 1.) THE ABOVE CAPTIONED PROPERTY WAS SURVEYED AND DESCRIBED BASED ON THE ABOVE LEGAL DESCRIPTION: PROVIDED BY CLIENT.
- 2.) THIS CERTIFICATION IS ONLY FOR THE LANDS AS DESCRIBED. IT IS NOT A CÉRTIFICATION OF TITLE, ZONING, EASEMENTS, OR FREEDOM OF ENCUMBRANCES. ABSTRACT NOT REVIEWED.
- 3.) THERE MAY BE ADDITIONAL RESTRICTIONS NOT SHOWN ON THIS BOUNDARY SURVEY THAT MAY BE FOUND IN THE PUBLIC RECORDS OF HIS COUNTY, EXAMINATION OF ABSTRACT OF TITLE WILL HAVE TO BE MADE TO DETERMINE RECORDED INSTRUMENTS, IF ANY AFFECTING THIS PROPERTY.
- 4.) ACCURACY: THE EXPECTED USE OF THE LAND, AS CLASSIFIED IN FLORIDA MINIMUM TECHNICAL STANDARDS (5J-17.51FAC), IS "RESIDENTIAL". THE MINIMUM RELATIVE DISTANCE ACCURACY FOR THIS TYPE OF BOUNDARY SURVEY IS 1 FOOT IN 7,500 FEET. THE ACCURACY OBTAINED BY MEASUREMENT AND CALCULATION OF A CLOSED GEOMETRIC FIGURE WAS FOUND TO EXCEED THIS REQUIREMENT. 5.) FOUNDATIONS AND/OR FOOTINGS THAT MAY CROSS BEYOND THE BOUNDARY
- LINES OF THE PARCEL HEREIN DESCRIBED ARE NOT SHOWN.
- TYPE OF SURVEY: BOUNDARY SURVEY 7.) ELEVATIONS SHOWN HEREON ARE BASED ON TO THE NATIONAL GEODETIC
- VÉRTICAL DATUM OF 1929 (N.G.V.D.29)
 8.) ALL MEASUREMENTS ARE IN ACCORDANCE WITH THE UNITED STATES
- STANDARD U.S. FOOT 9.) CONTACT THE APPROPRIATE AUTHORITY PRIOR TO ANY DESIGN WORK ON
- THE HEREIN DESCRIBED PARCEL FOR BUILDING AND ZONING INFORMATION.


 10.) UNDERGROUND UTILITIES ARE NOT DEPICTED HEREON, CONTACT THE APPROPRIATE AUTHORITY PRIOR TO ANY DESIGN WORK OR CONSTRUCTION ON THE PROPERTY HEREIN DESCRIBED. SURVEYOR SHALL BE NOTIFIED AS TO ANY DEVIATION FROM UTILITIES SHOWN HEREON.
- 11.) ENCUMBRANCES NOT SHOWN ON THE PLAT.
- 12.) THE WRITTEN CONSENT OF LANDMARK SURVEYING & ASSOCIATES, INC. UNDERGROUND PORTIONS OF FOOTING, FOUNDATIONS OR OTHER IMPROVEMENTS WERE NOT LOCATED
- 13.) ONLY VISIBLE AND ABOVE GROUND ENCROACHMENTS LOCATED.
- 14.) WALL TIES ARE TO THE FACE OF THE WALL.
- FENCE OWNERSHIP NOT DETERMINED.
- 16.) BASIS OF BEARINGS REFERENCED TO LINE NOTED AS B.B.
- 17.) BOUNDARY SURVEY MEANS A DRAWING AND/OR GRAPHIC REPRESENTATION
- OF THE SURVEY WORK PERFORMED IN THE FIELD. 18.) NO IDENTIFICATION FOUND ON PROPERTY CORNERS UNLESS NOTED.
- 19.) THE SOURCES OF DATA USED FOR THE PREPARATION OF THIS BOUNDARY SURVEY IS "OLETA TERRACE" RECORDED IN PLAT BOOK 8, AT PAGE 117. 20.) THIS MAP OF SURVEY IS INTENDED TO BE DISPLAYED AT A SCALE OF ONE INCH FQUALS 20 FFFT OR SMALLER.

MAP OF BOUNDARY SURVEY

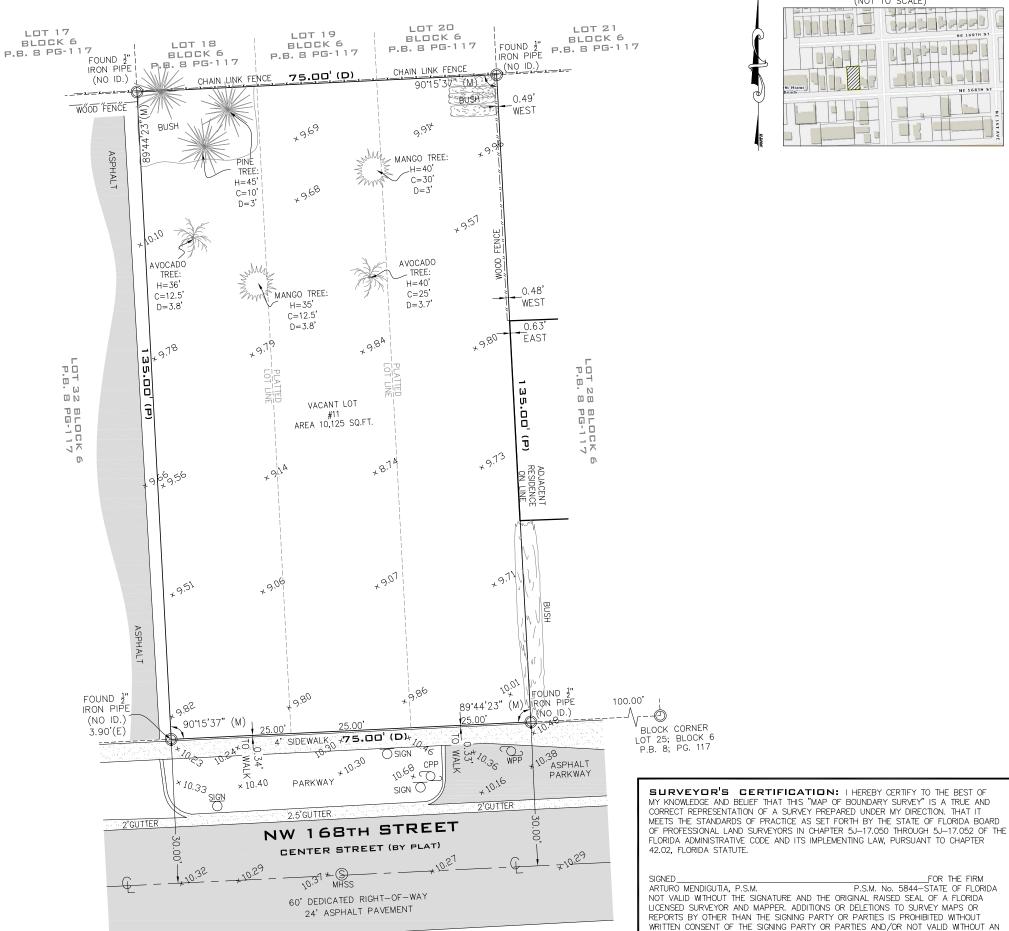

LOCATION MAP

SECTION 12, TOWNSHIP 52 SOUTH, RANGE 41 EAST LYING AND BEING IN DADE COUNTY FLORIDA

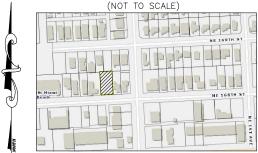

P.S.M. No. 5844-STATE OF FLORIDA

AUTHENTIC ELECTRONIC SIGNATURE AND AUTHENTICATED ELECTRONIC SEAL.

Σ



LB No. 7633

PROFESSIONAL SURVEYORS AND MAPPERS 1435 S.W. 87th AVENUE, SUITE "201" MIAMI FI .33174

PHONE: (305) 556-4002 FAX: (305) 556-4003 WWW.LMSURVEYING.COM EMAIL-REQUEST@LMSURVEYING.COM

ABBREVIATIONS AND LEGEND:

=DENOTES AIR CONDITIONING UNIT =DENOTES BASIS OF BEARINGS =DENOTES ASPHALT =DENOTES PROPERTY LINE B.M. C.B.S. CONC. L.P CB =DENOTES PROPERTY LINE
=DENOTES BENCH MARK
=DENOTES CONCRETE BLOCK STUCCO
=DENOTES CONCRETE
=DENOTES LIGHT POLE
=DENOTES CATCH BASIN =DENOTES CENTERLINE =DENOTES MONUMENT LINE =DENOTES LAKE & MAINTENANCE L.M.E.

=DENOTES LAKE & MAINTENANCE
EASEMENT
=DENOTES DRAINAGE EASEMENT
=DENOTES MERCORD
=DENOTES MEASURE
=DENOTES RECORD
=DENOTES WOOD POWER POLE
=DENOTES VITILITY EASEMENT
=DENOTES PLAT
=DENOTES PAGE D.E. D.H. (M) (R)

=DENOTES PAGE

=DENOTES PERMANENT CONTROL POINT =DENOTES POINT OF BEGINNING =DENOTES TYPICAL =DENOTES MEAN HIGH WATER LINE

- // --- = DENOTES WOOD FENCE -x - =DENOTES CHAIN LINK FENCE - =DENOTES IRON FENCE

=DENOTES FOUND IRON PIPE (NO ID.)

=DENOTES ASPHALT PAVEMENT

=DENOTES FOUND NAIL AND DISC

=DENOTES BRICK

=DENOTES CONCRETE PAD $\frac{X.XX}{}$ =DENOTES ELEVATIONS

ALL BEARINGS AND DISTANCES SHOWN HEREON ARE RECORD AND MEASURED UNLESS OTHERWISE NOTED.

	FLOOD ZC	NE:	X			
_	ELEVATIO	N:	N/A			
E)	COMMUNI	TY:	120656			
URVEY	PANEL:		12086C0137			
ЭU	DATE OF F	IRM:	09-11-2009			
	SUFFIX	:	L			
OUNDARY	ORIGINAL F WORK SUR DATE		02-02-2021			
	BENCH MA	ARK:	N/A			
	ELEVATIO	N:	N/A			
	DATE	DR <i>A</i> B	AWN Y	SCALE		
В	02-02-2021	J.FEE		1"=20'		
OF	REVISION / UPDATE OF SURVE					
_	DATE		DESCRIPTION			
AΕ	N/A			N/A		

JOB No.

2102.0011